# CONWAY, SOUTH CAROLINA WASTE FACILITIES IMPROVEMENTS

SEPTEMBER, 1977
JOB NO. C-374

EPA PROJECT NUMBER 0450486-01

# CITY OF CONWAY, SOUTH CAROLINA

KENNETH S. HOLT .... MAYOR

### COUNCILMEN:

SAMUEL W. PRINCE
HOWARD BANNER
CLEVELAND L. FLADGER
JAMES B. GOLDFINCH
WILLIAM D. AVANT, JR.
LLOYD B. DAVIS
R.S. WINFIELD DIRECTOR OF PUBLI

R.S. WINFIELD... DIRECTOR OF PUBLIC WORKS
BILL GRAHAM . . . . CITY ADMINISTRATOR

Agreed and Approved As Correct
The City of Conway

By Megory K. Martin

Market

6.5.W. = 5A

By Fred R Kukarbon

Dated 12-5-95

# FORCE MAINS & SEWER LINES U2-U9 B 3-10 B WATER LINE TO PLANT U8-U9 9-10 STANDARD STRUCTURES FOR SEWER LINES U10 11 PUMP STATION NO I RENOVATIONS, PUMP PI 12 STATION NO 2 & PUMP STATION NO 4 YARD PIPING REVISIONS PUMP STATION NO 3 RENOVATIONS P2 13 LOCATION AND PIPING PLAN P3 14 GRADING PLAN P4 15 PUMP STATION NO 5-SITE IMPROVEMENTS P5 16 BAR SCREEN AND PARSHALL FLUME P6 17

INDEX TO DRAWINGS

DRAWING NO.

DESCRIPTION

COVER SHEET


PROJECT SITE MAP


THE HARWOOD BEEBE COMPANY ENGINEERS


FLORENCE, S.C.


SPARTANBURG, S.C.


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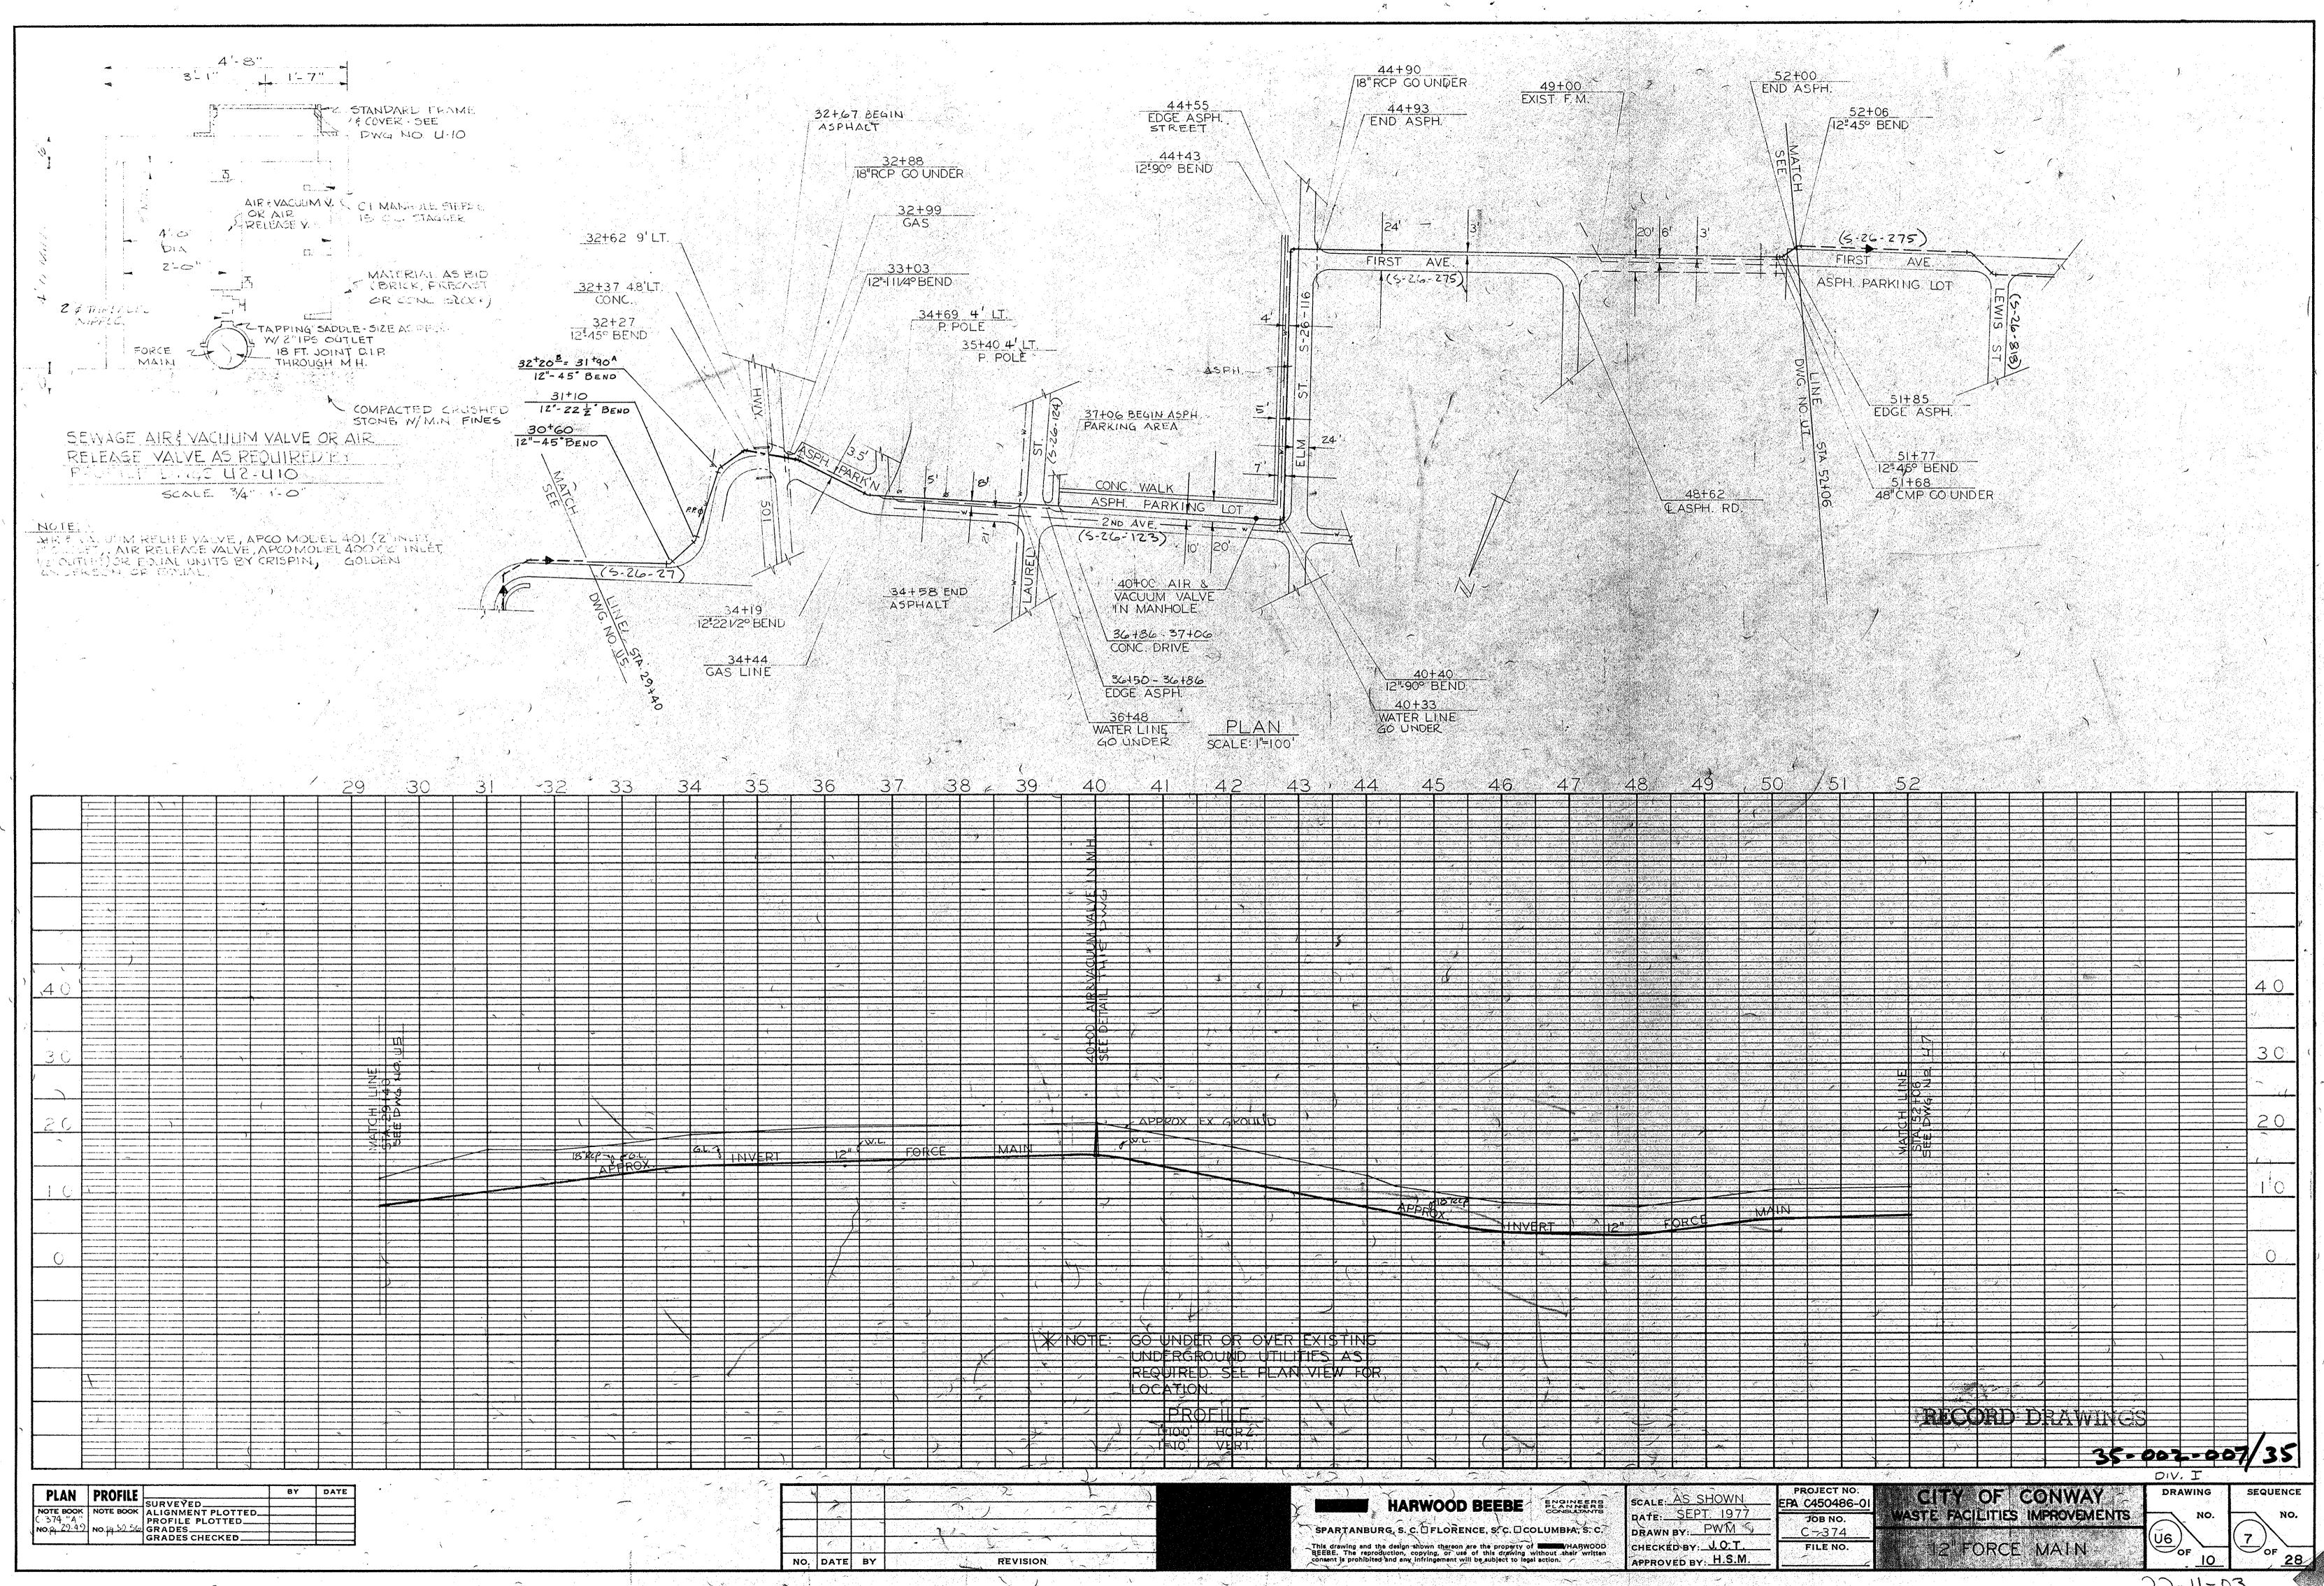


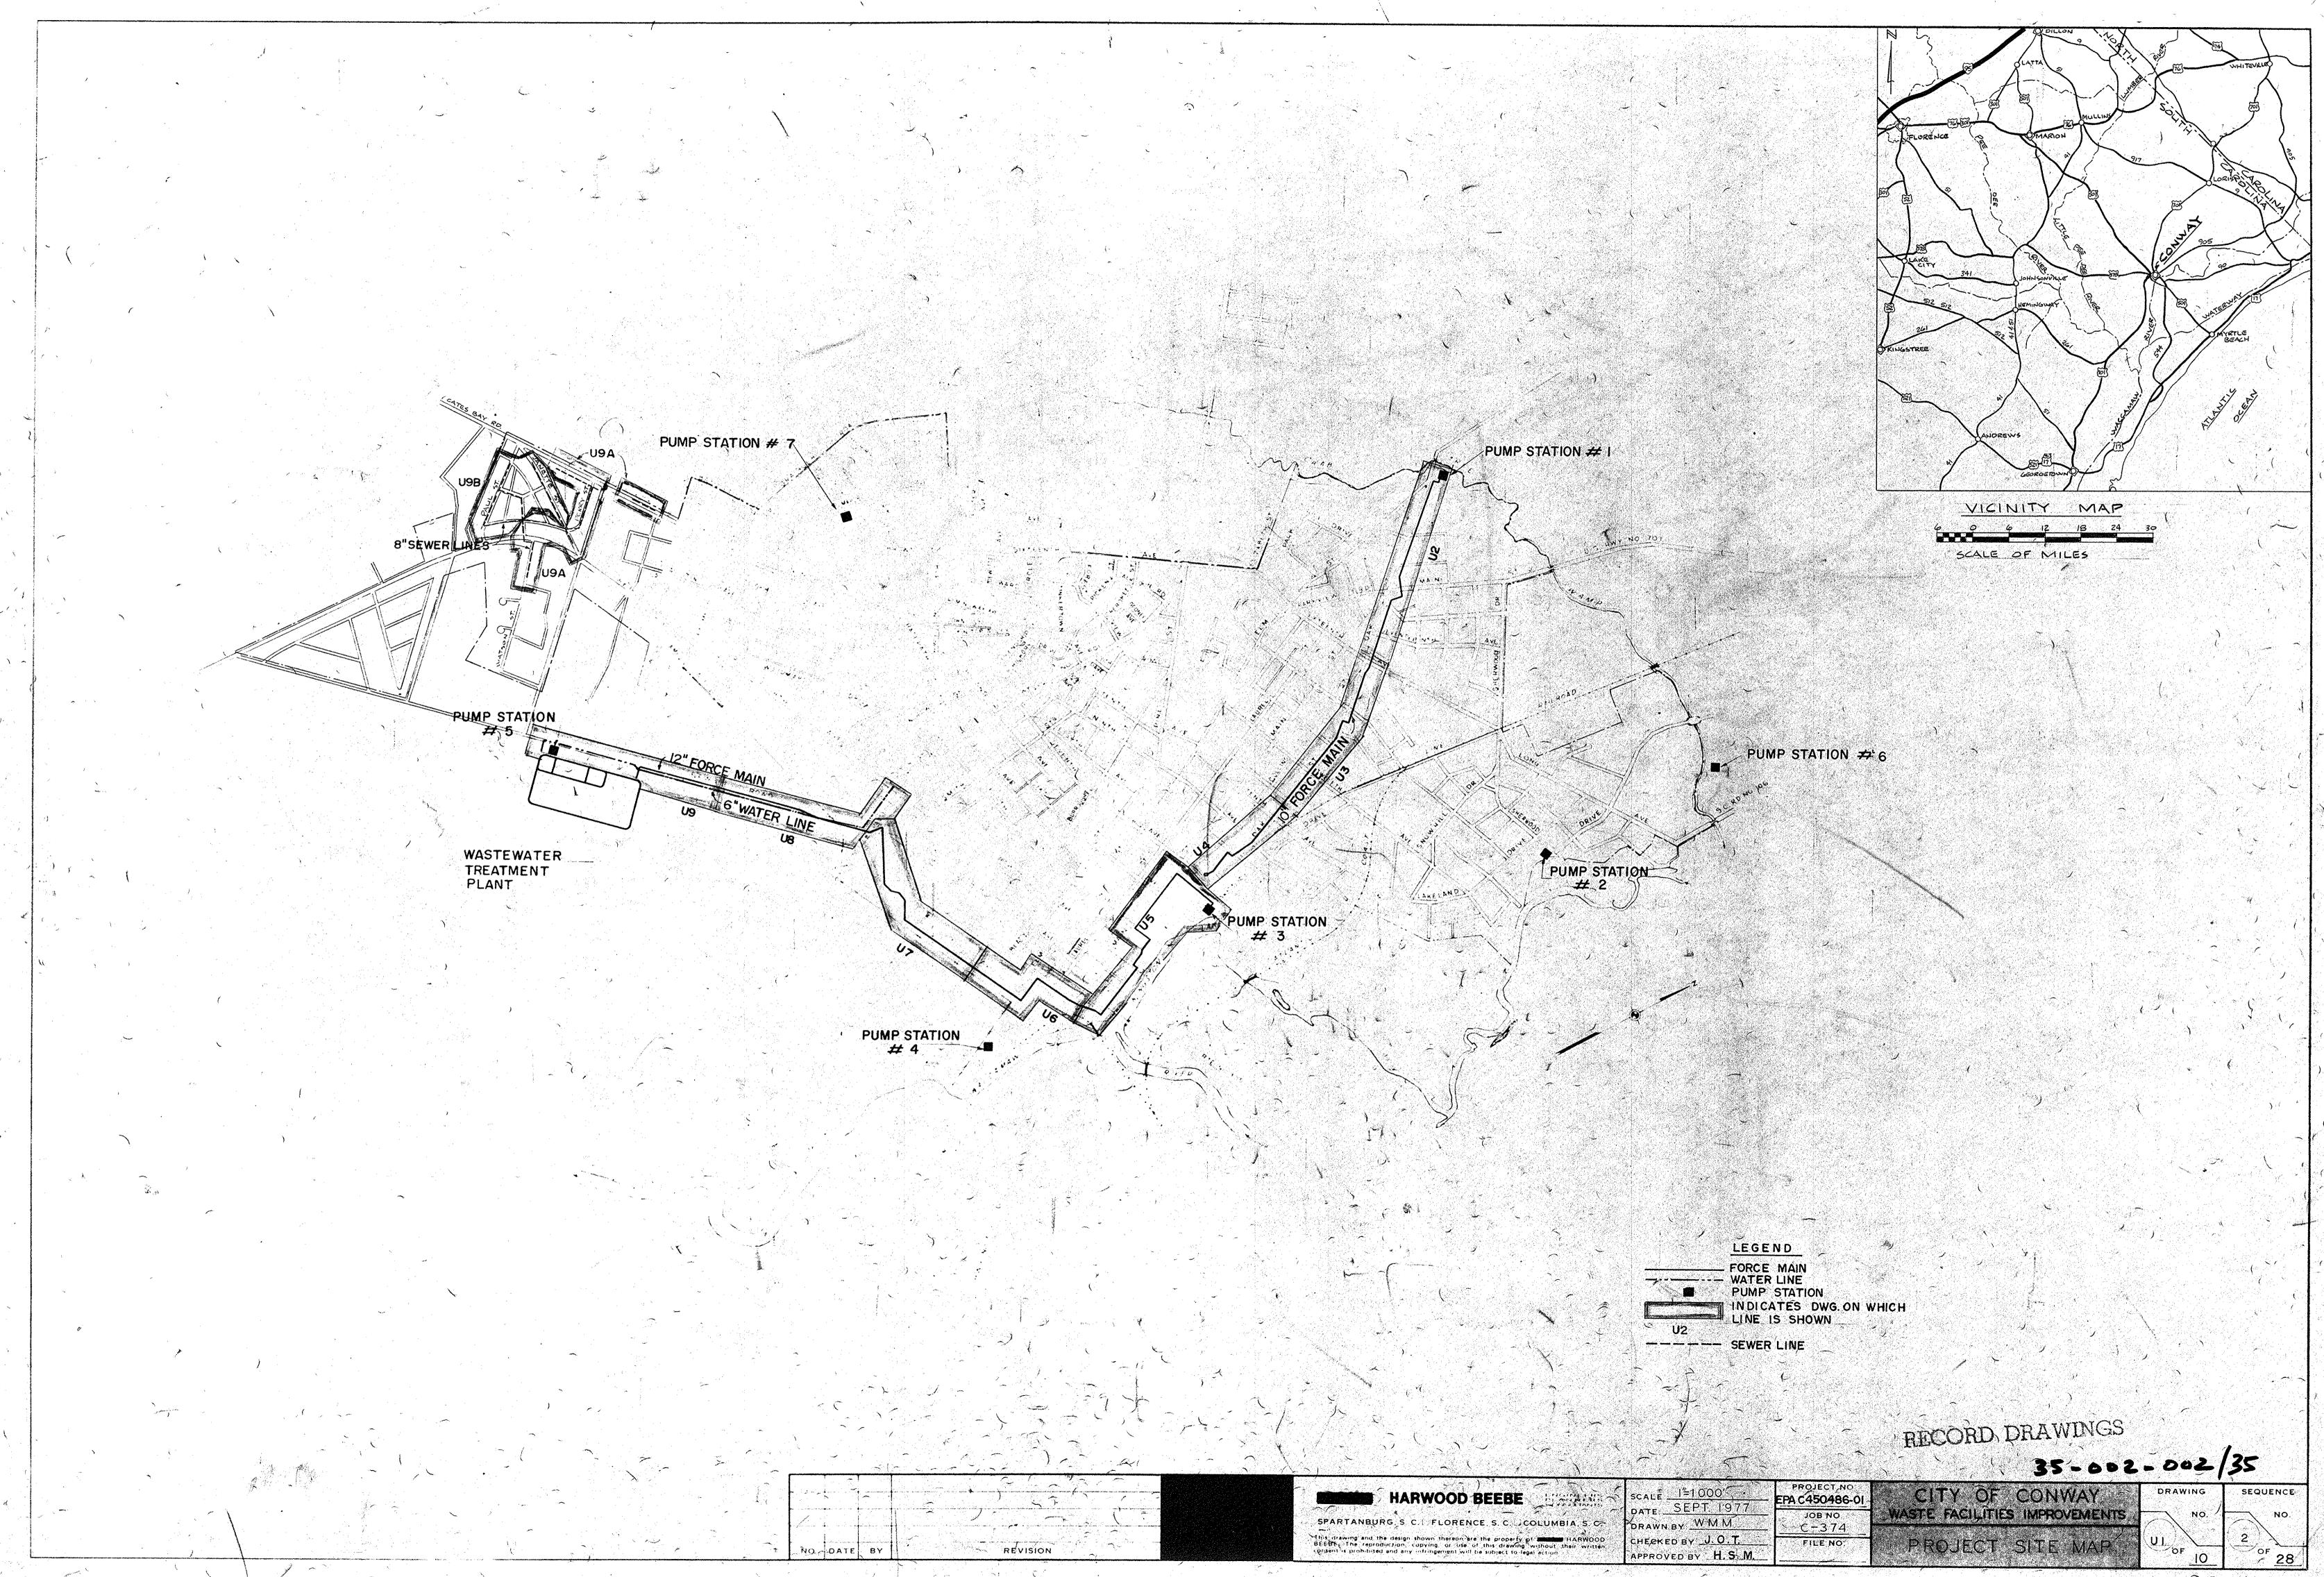


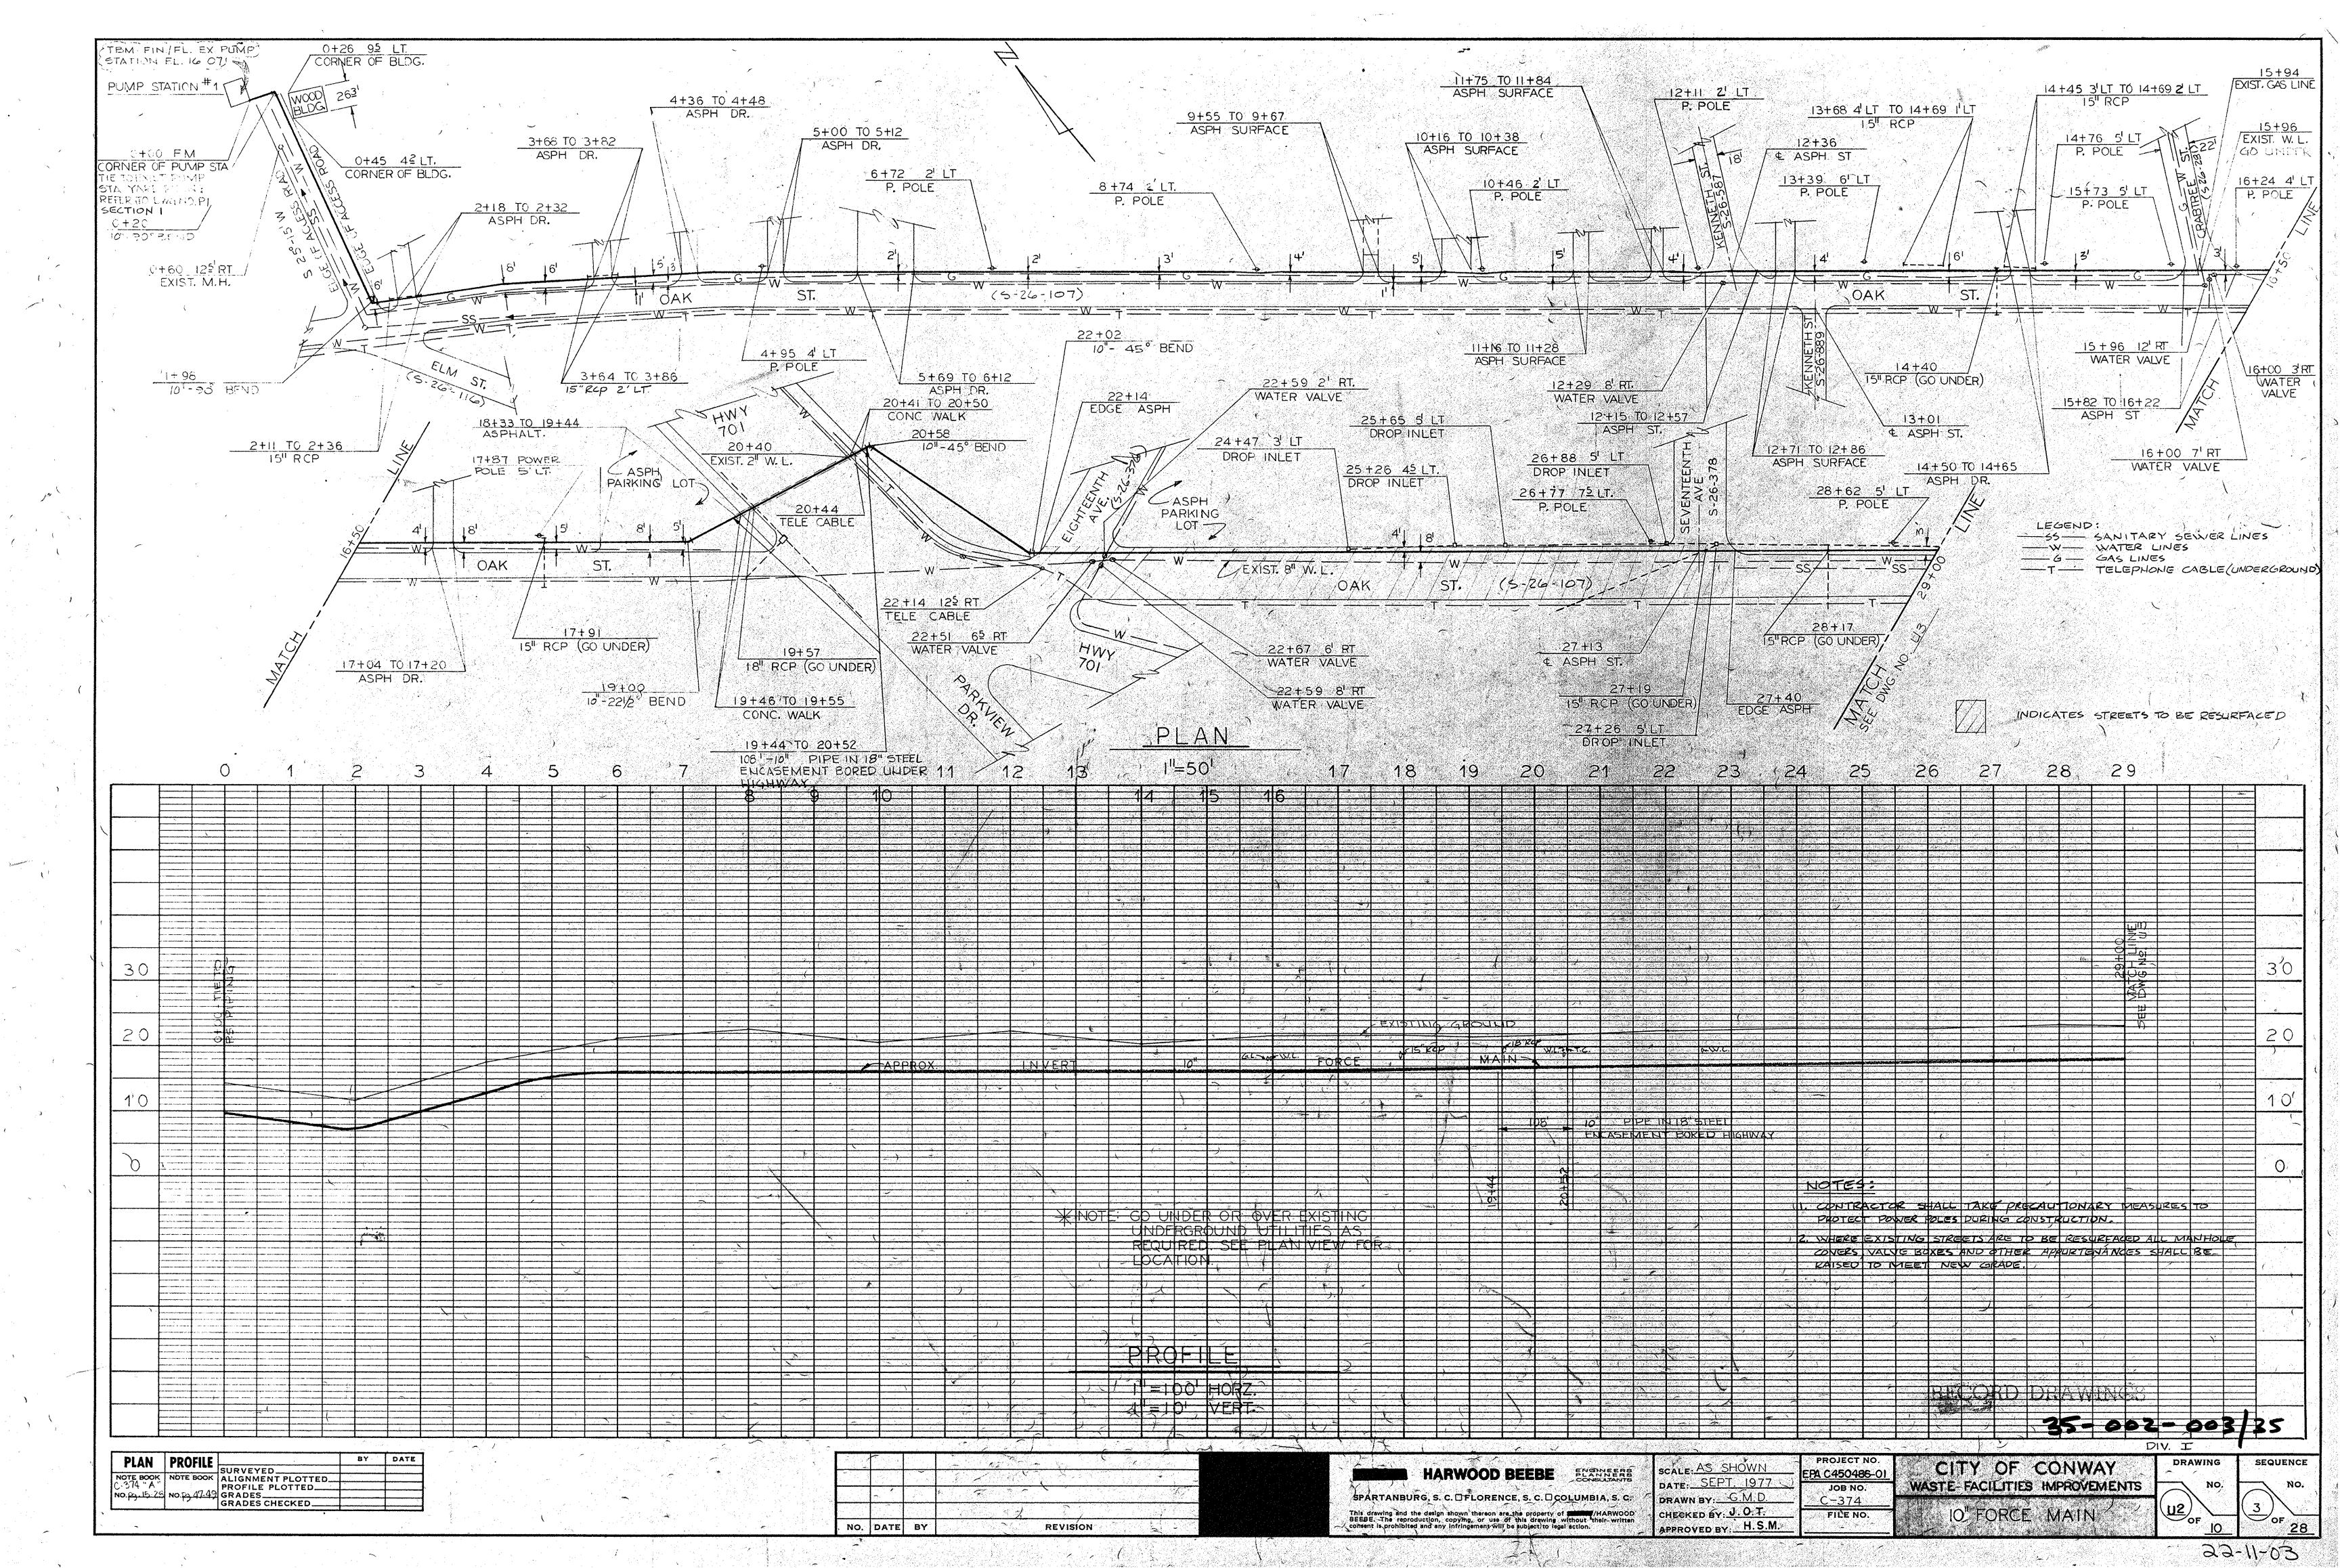


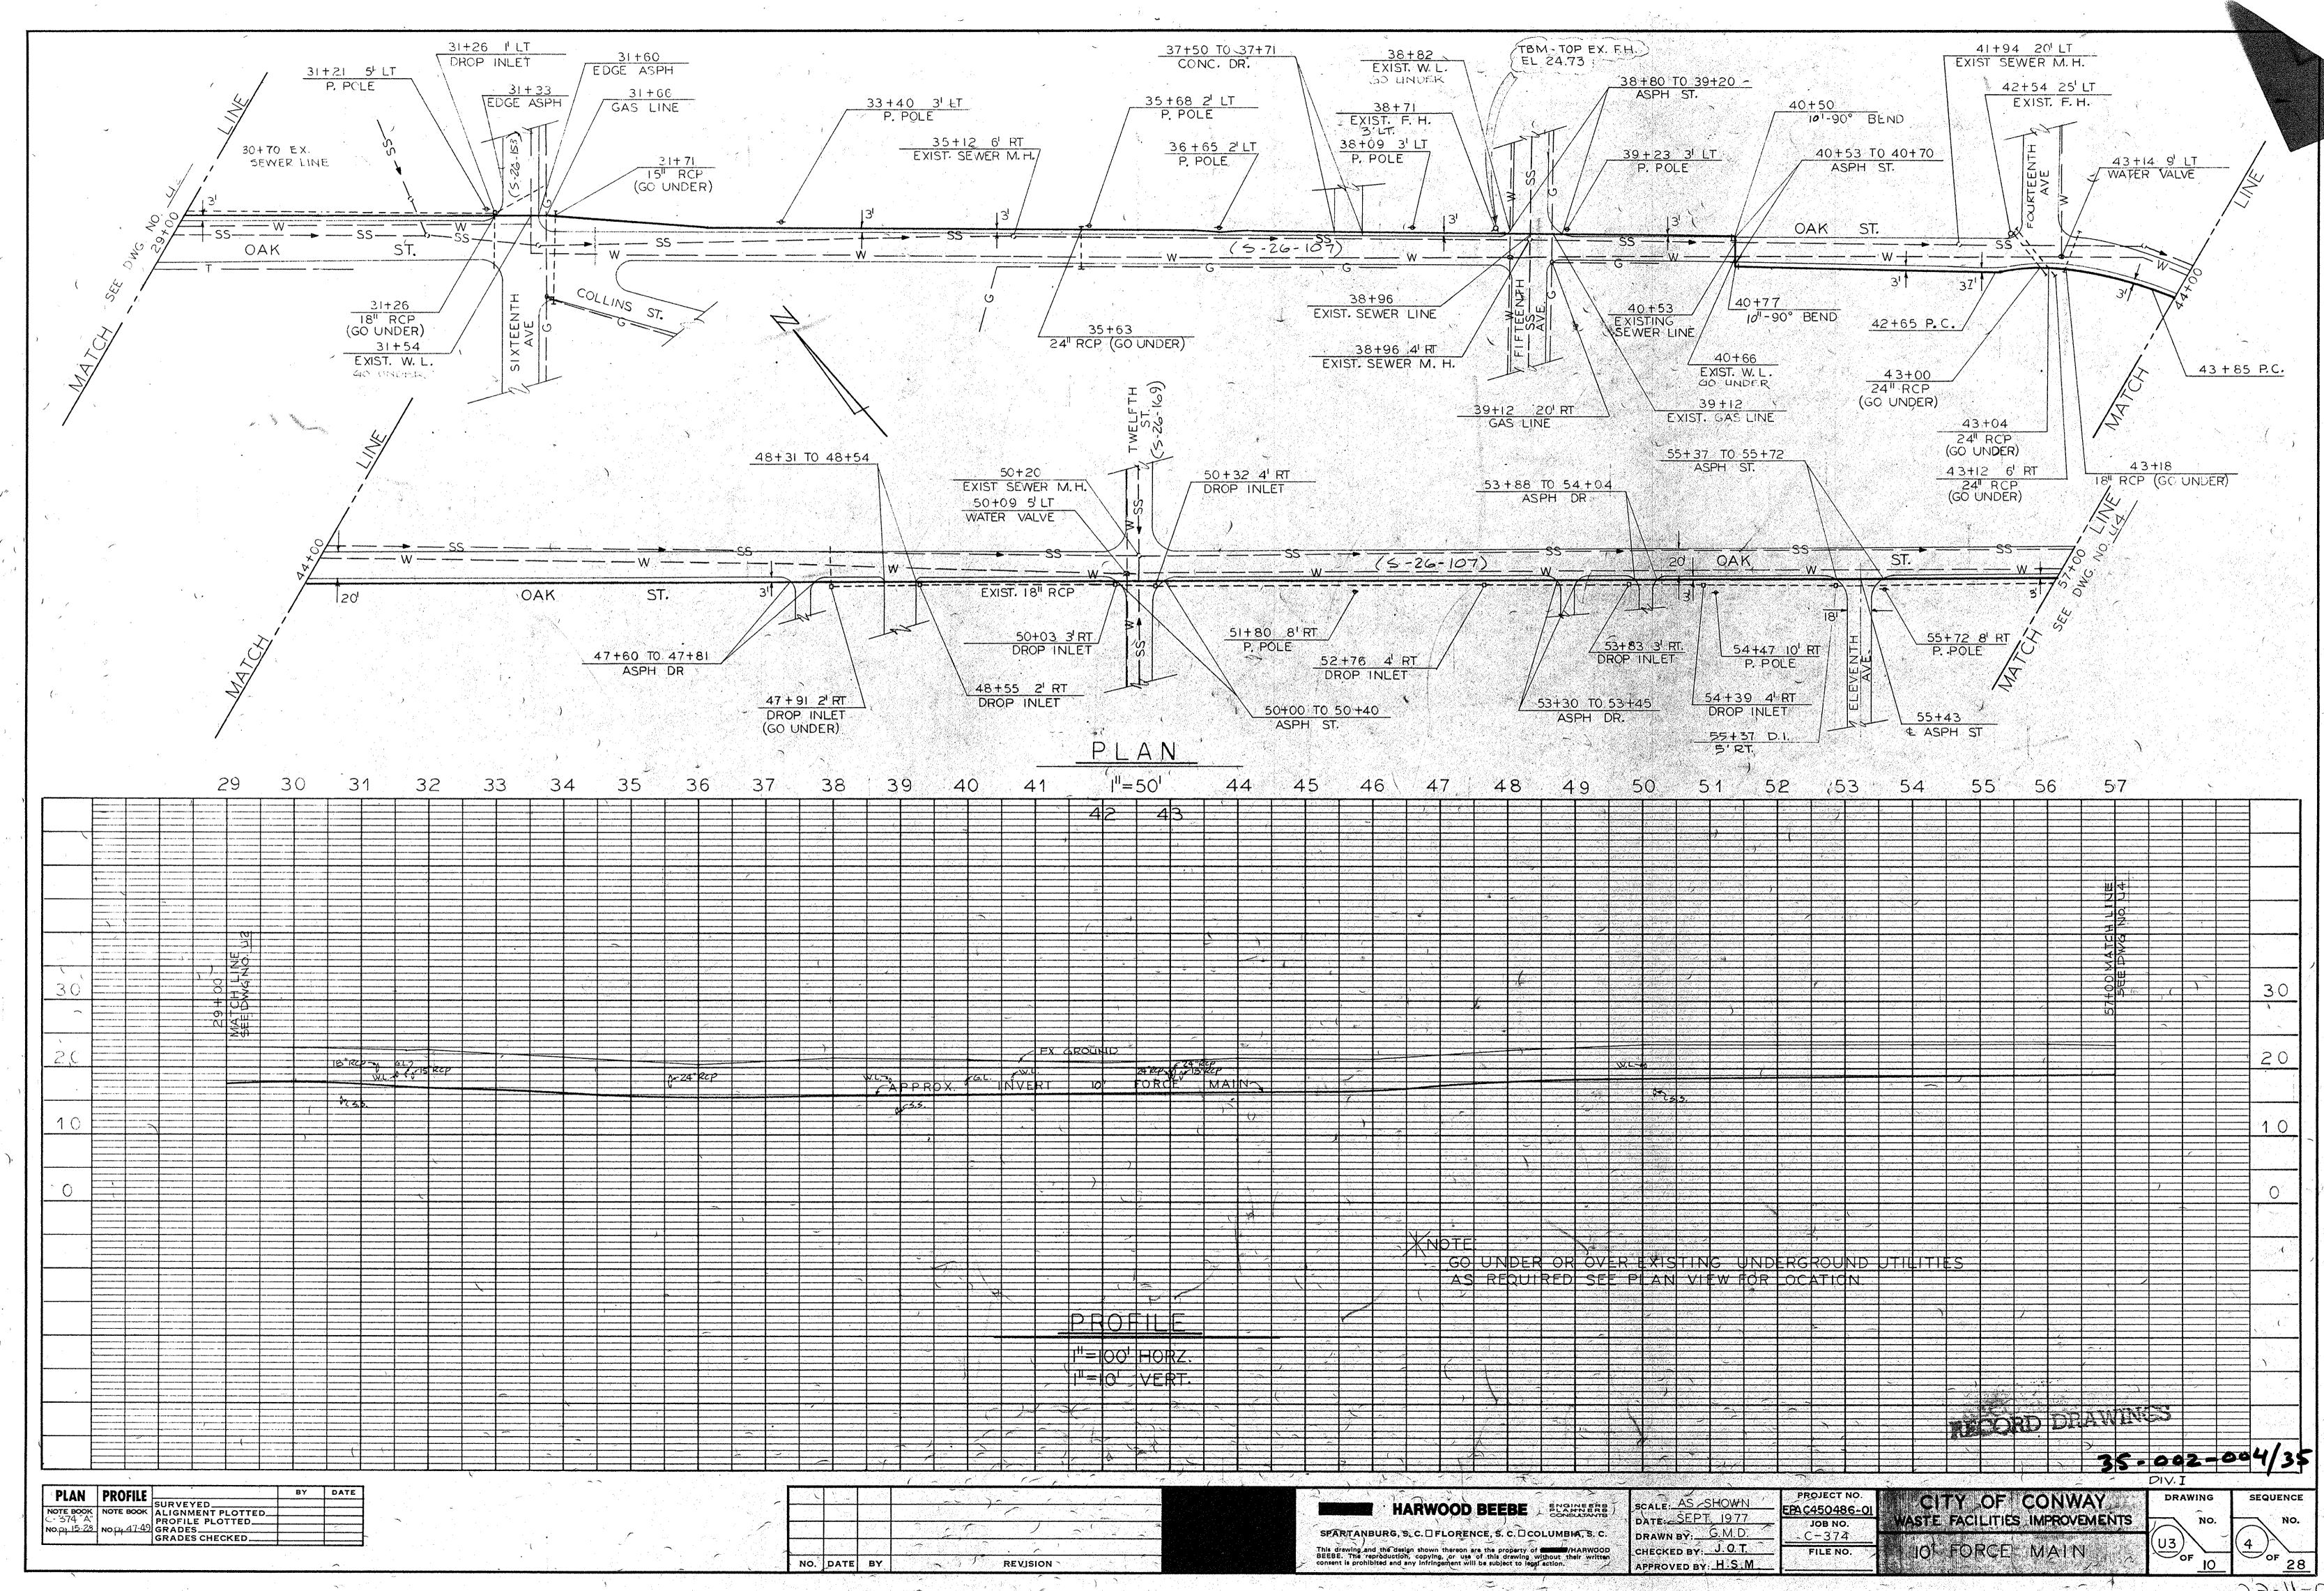


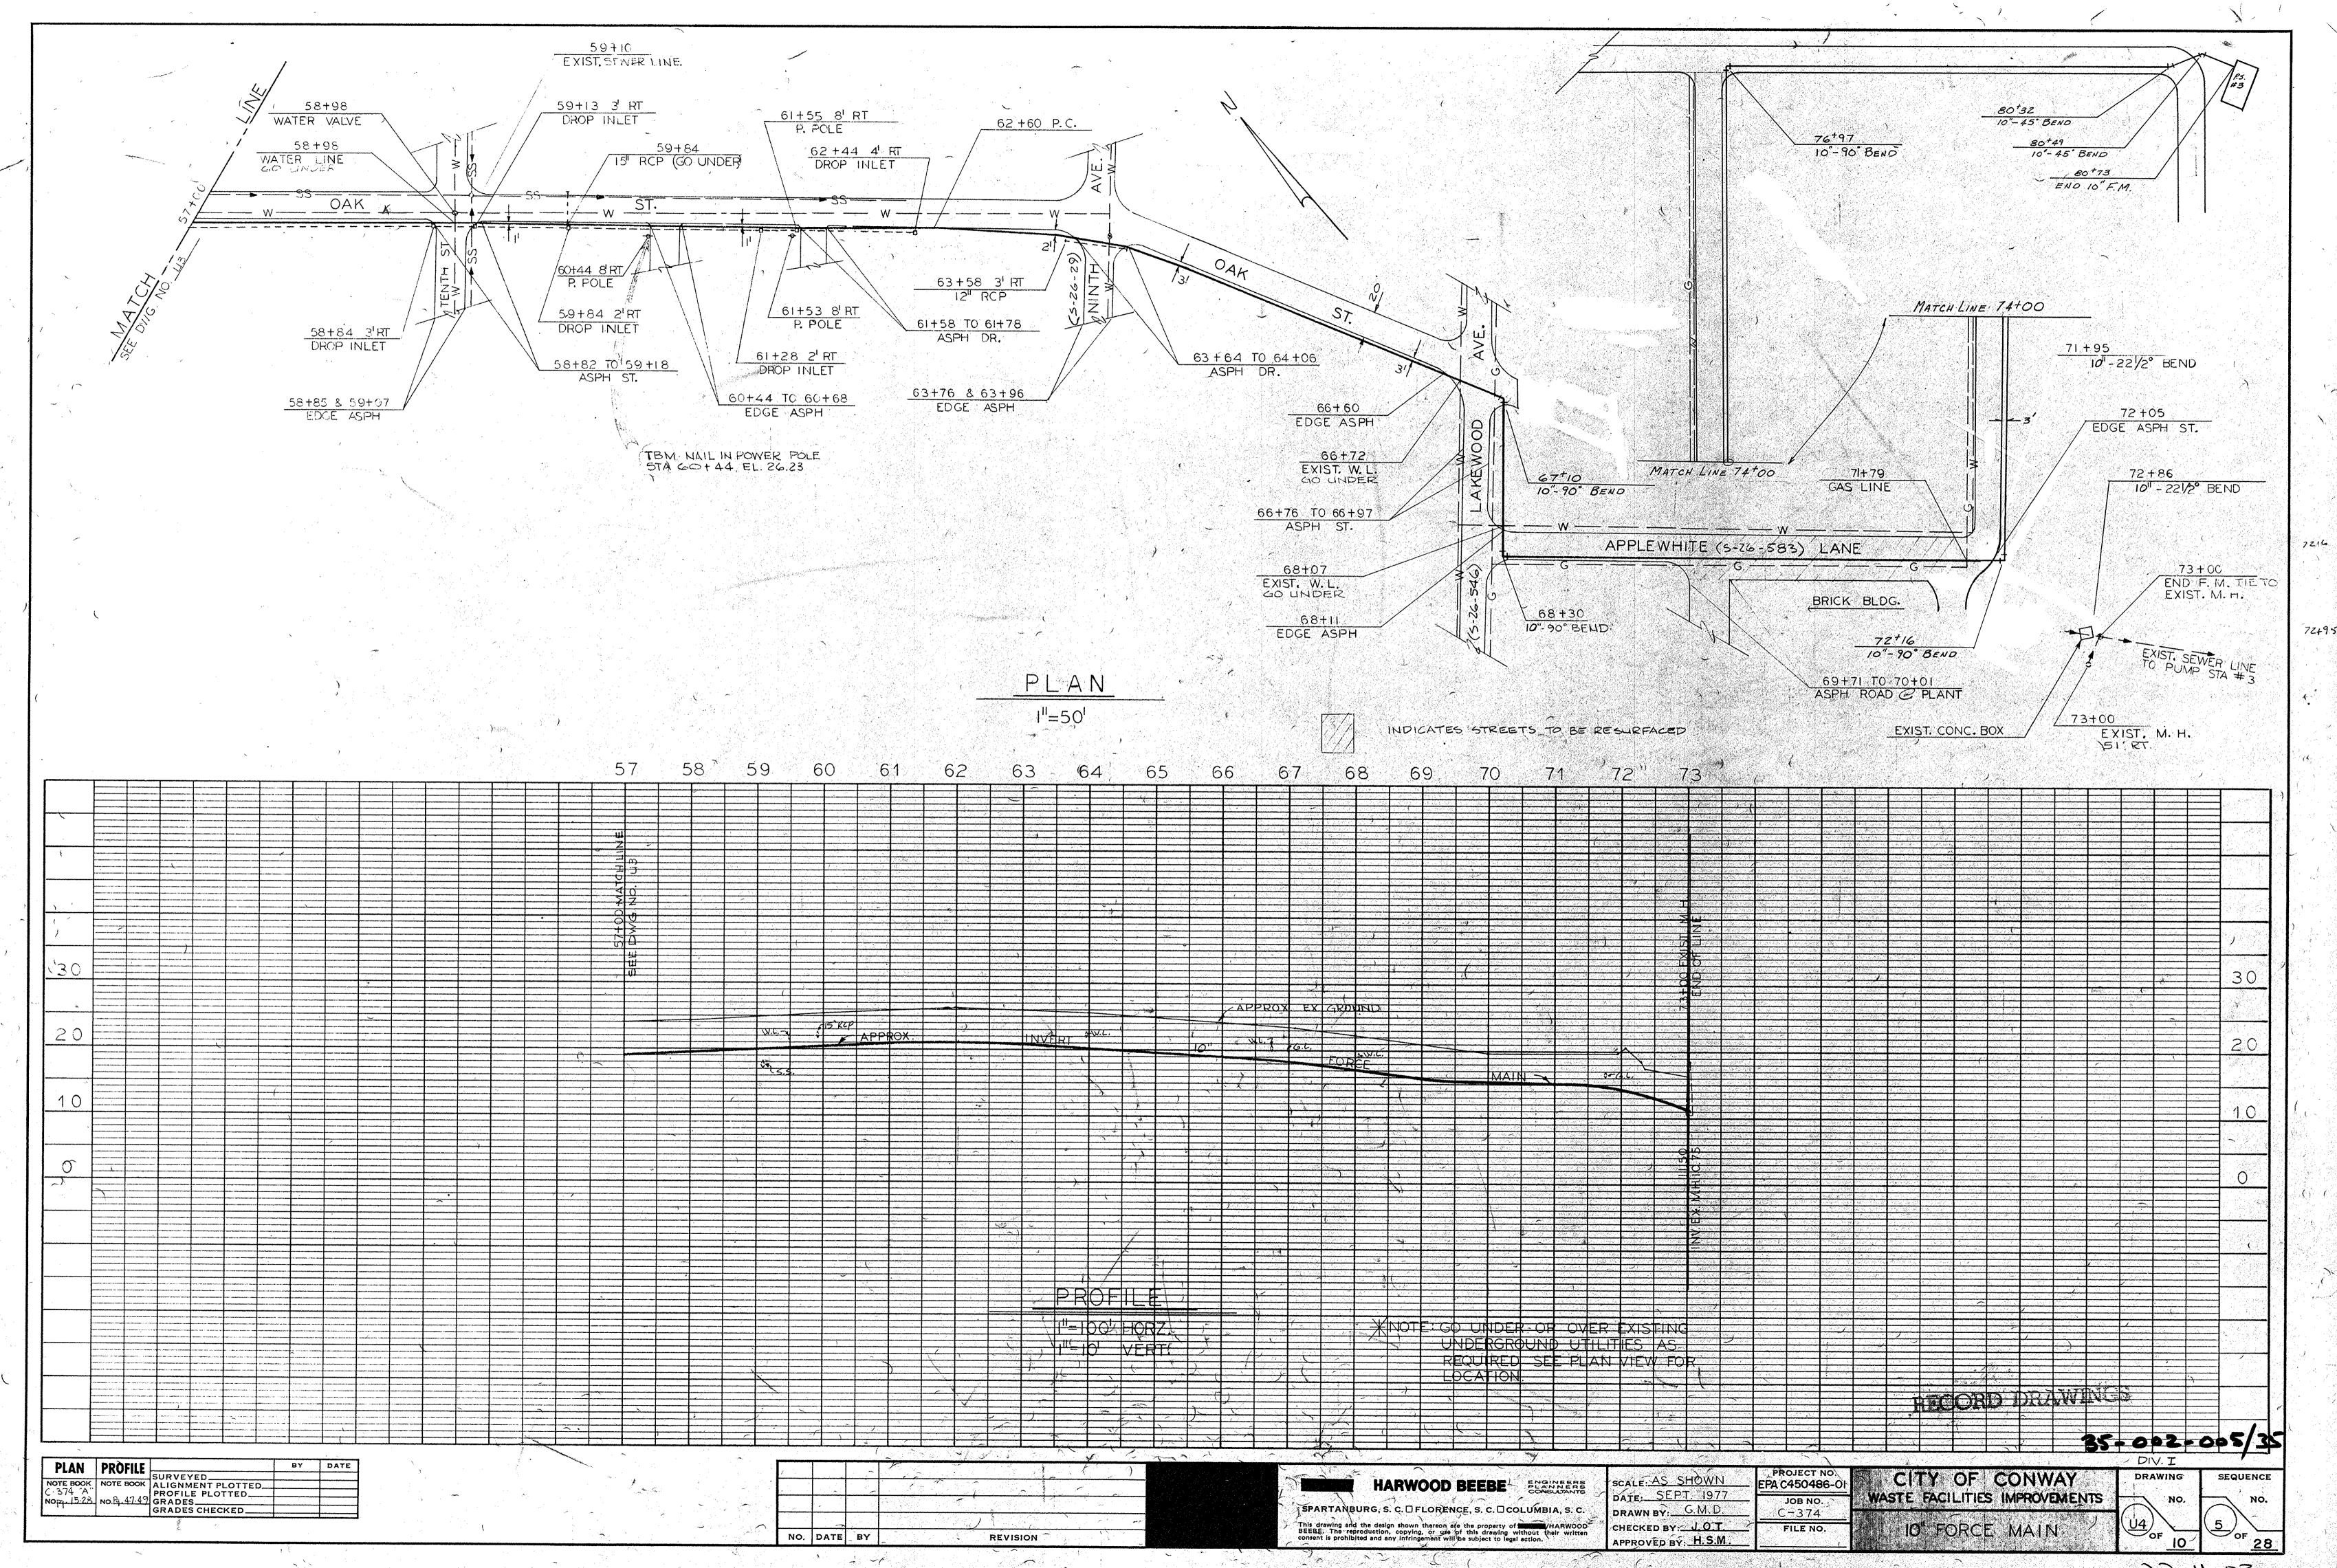

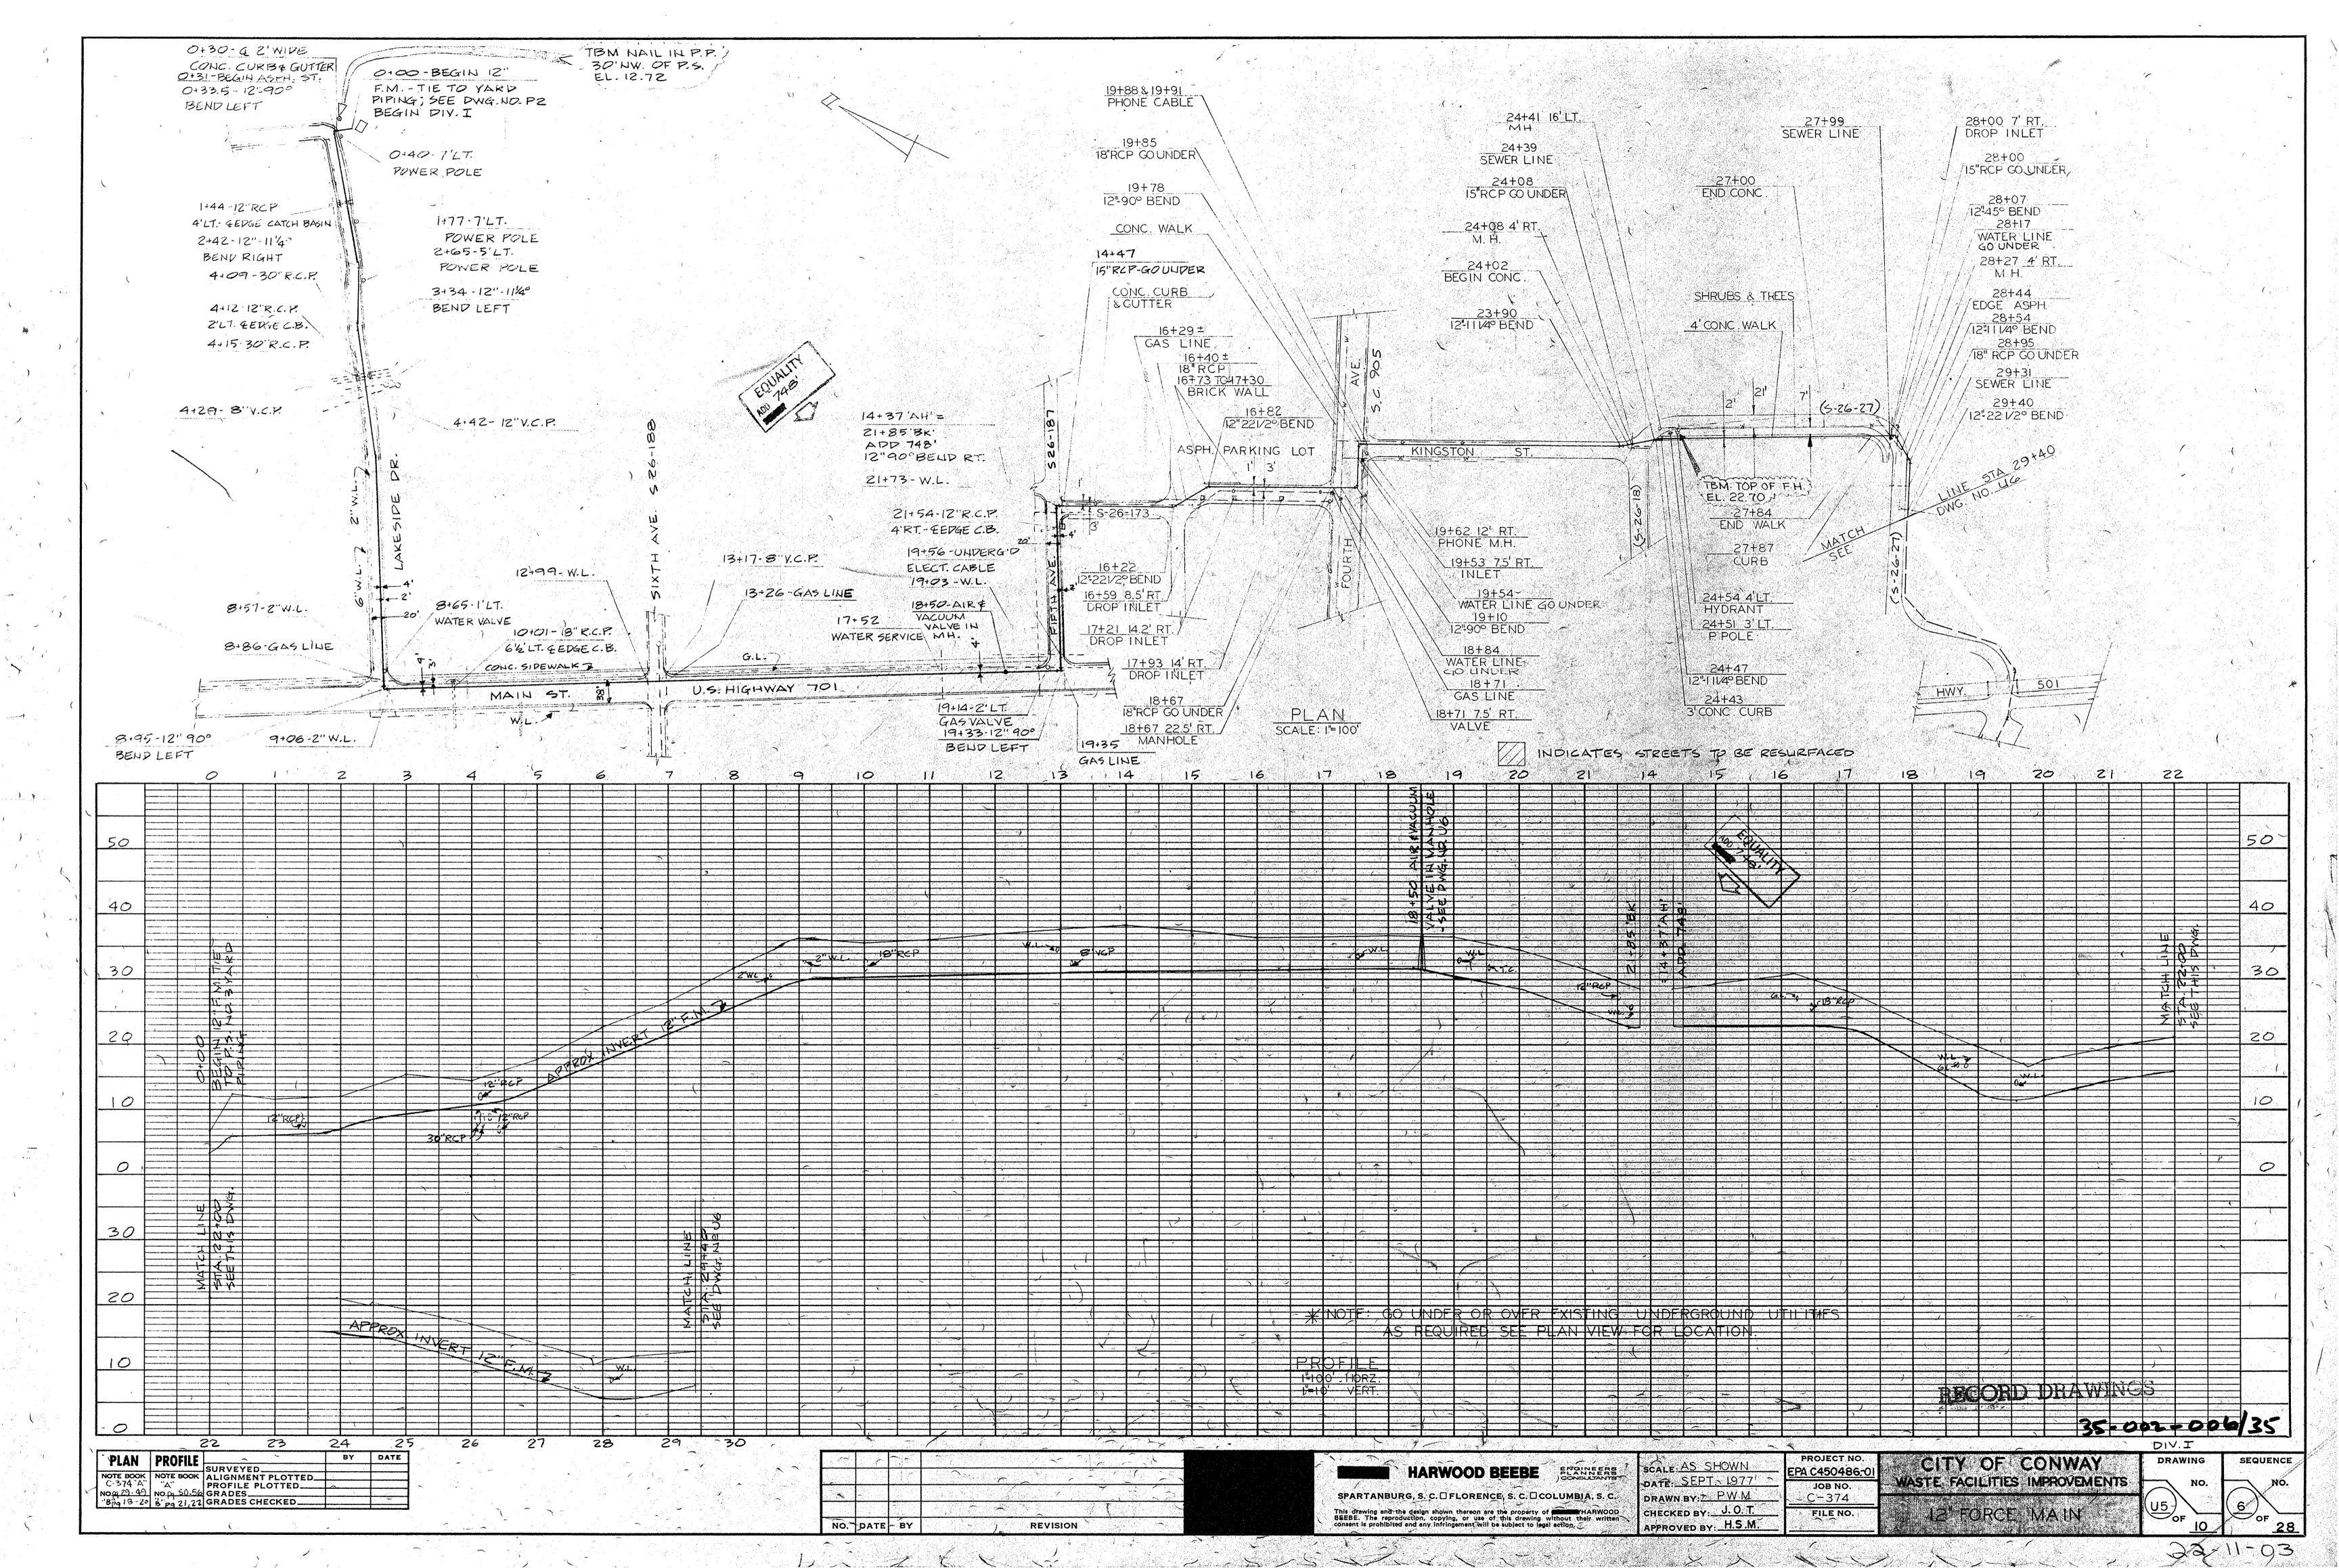


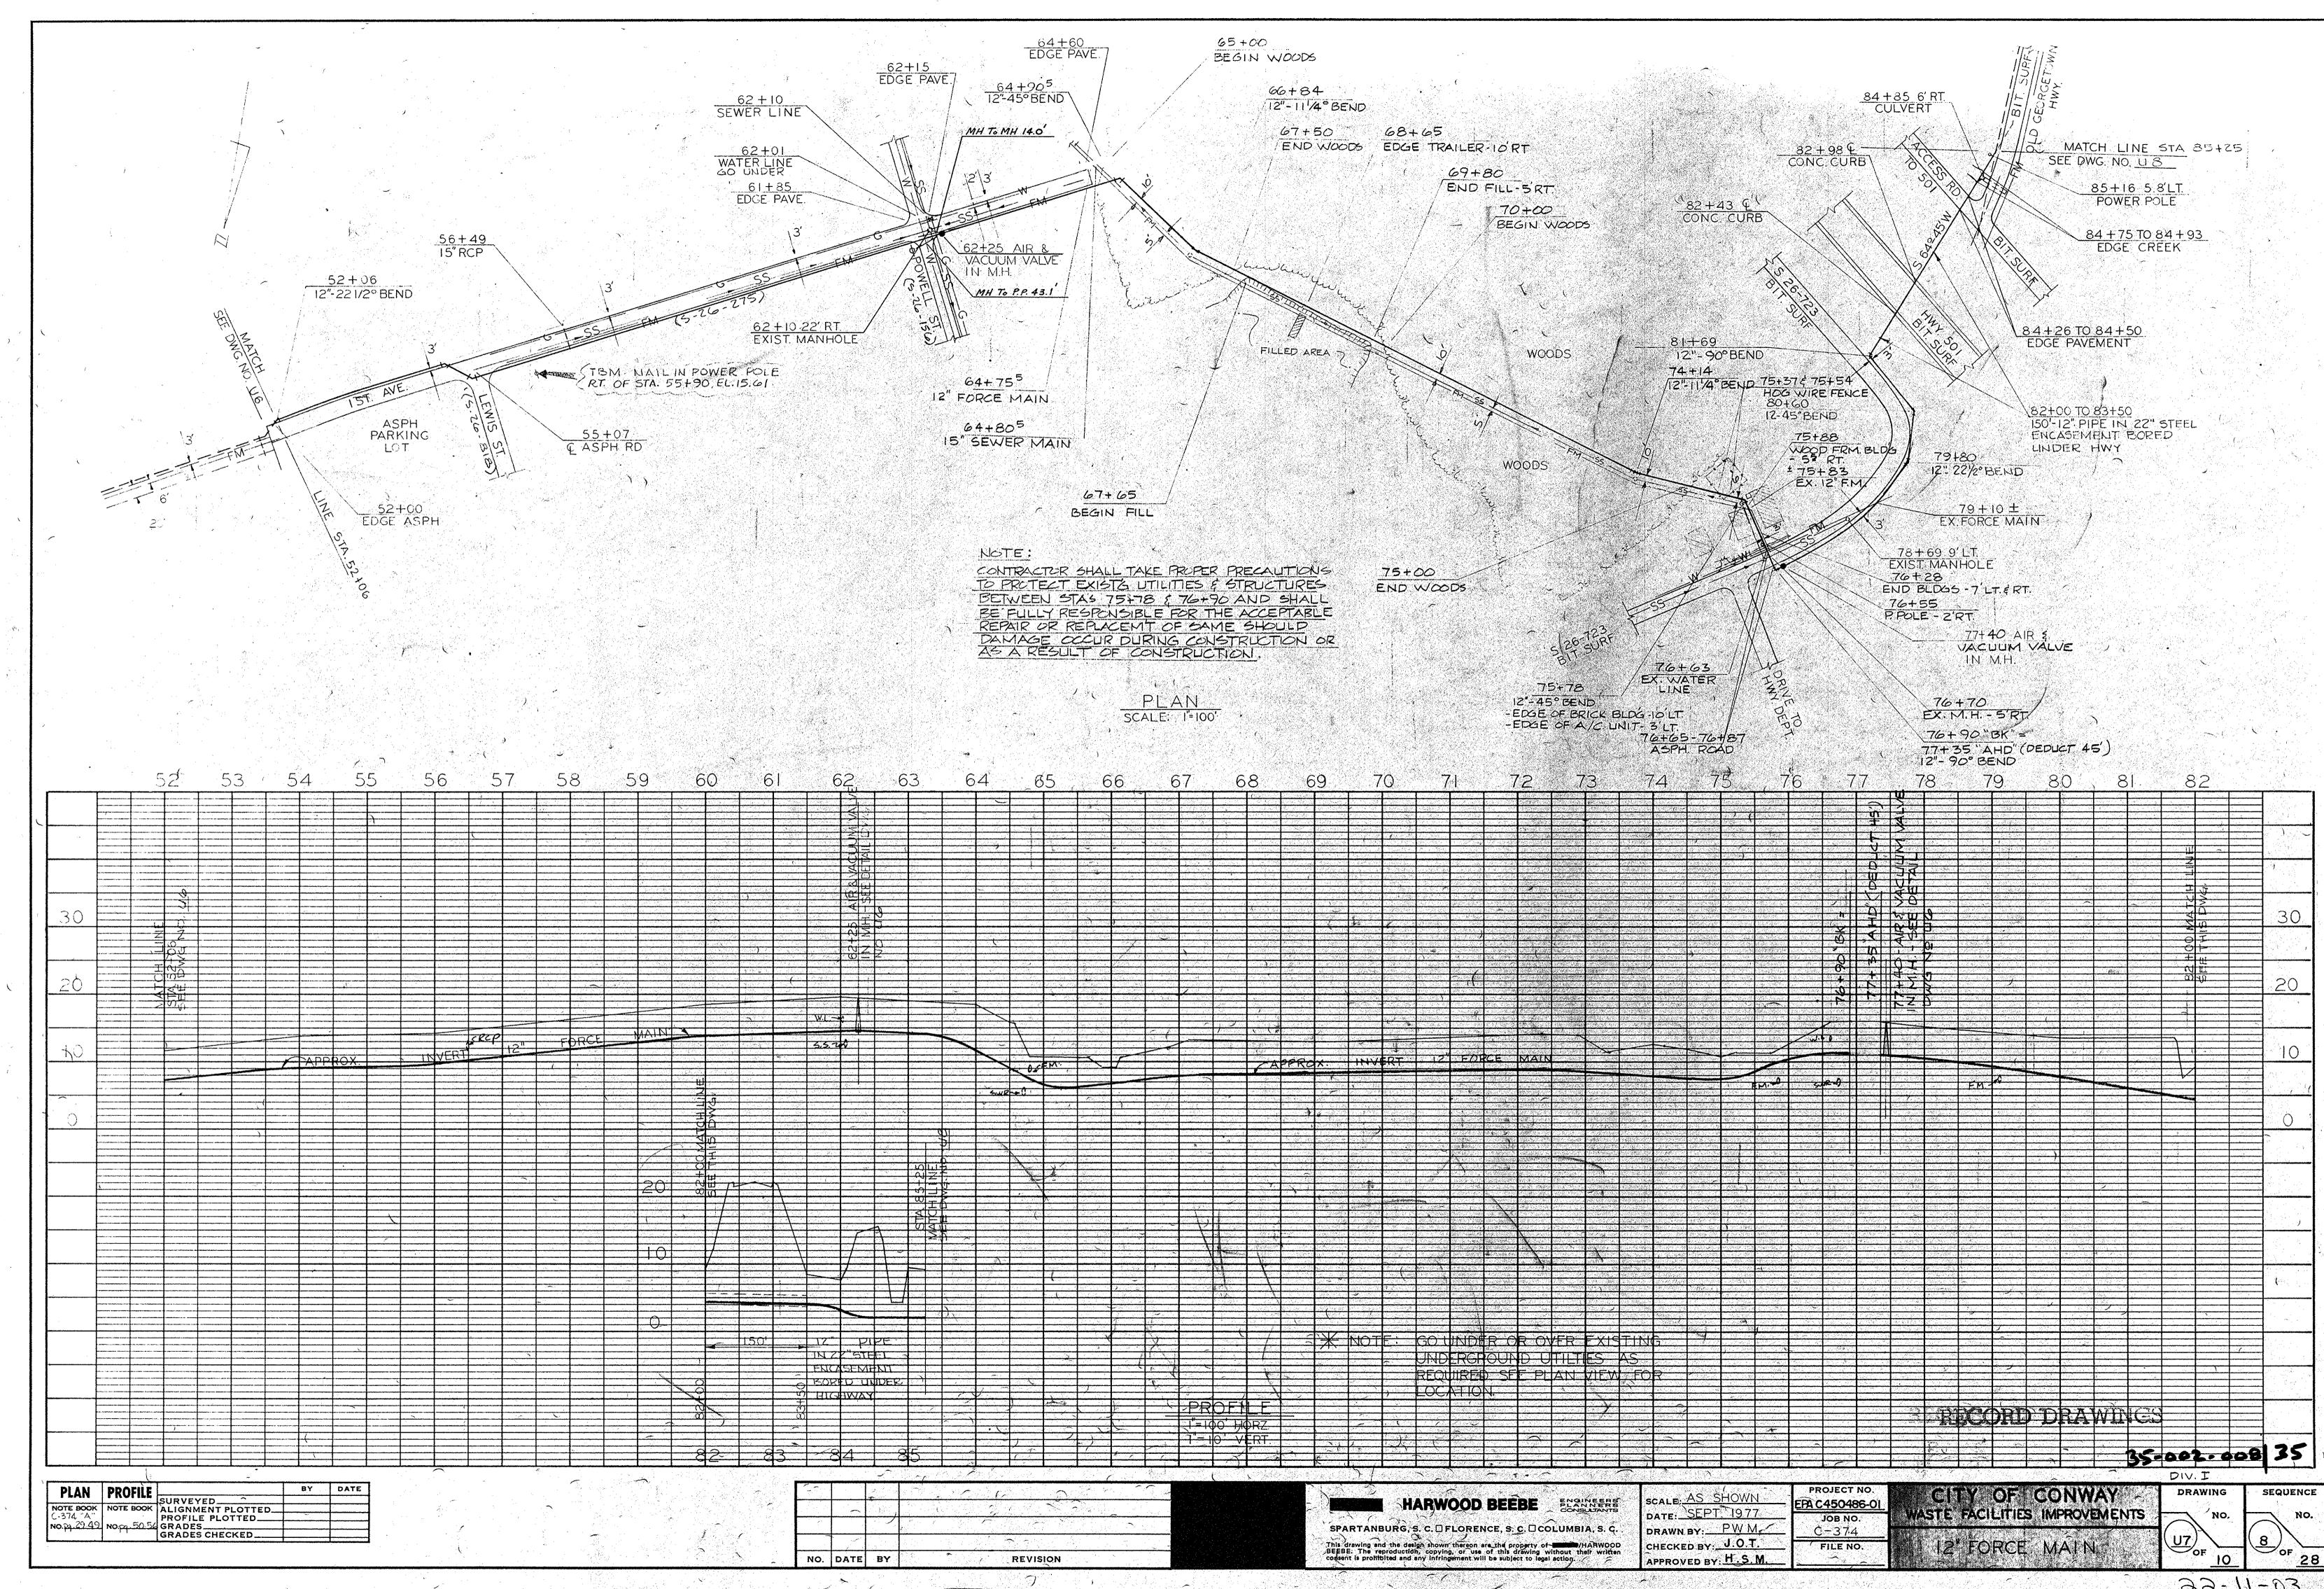


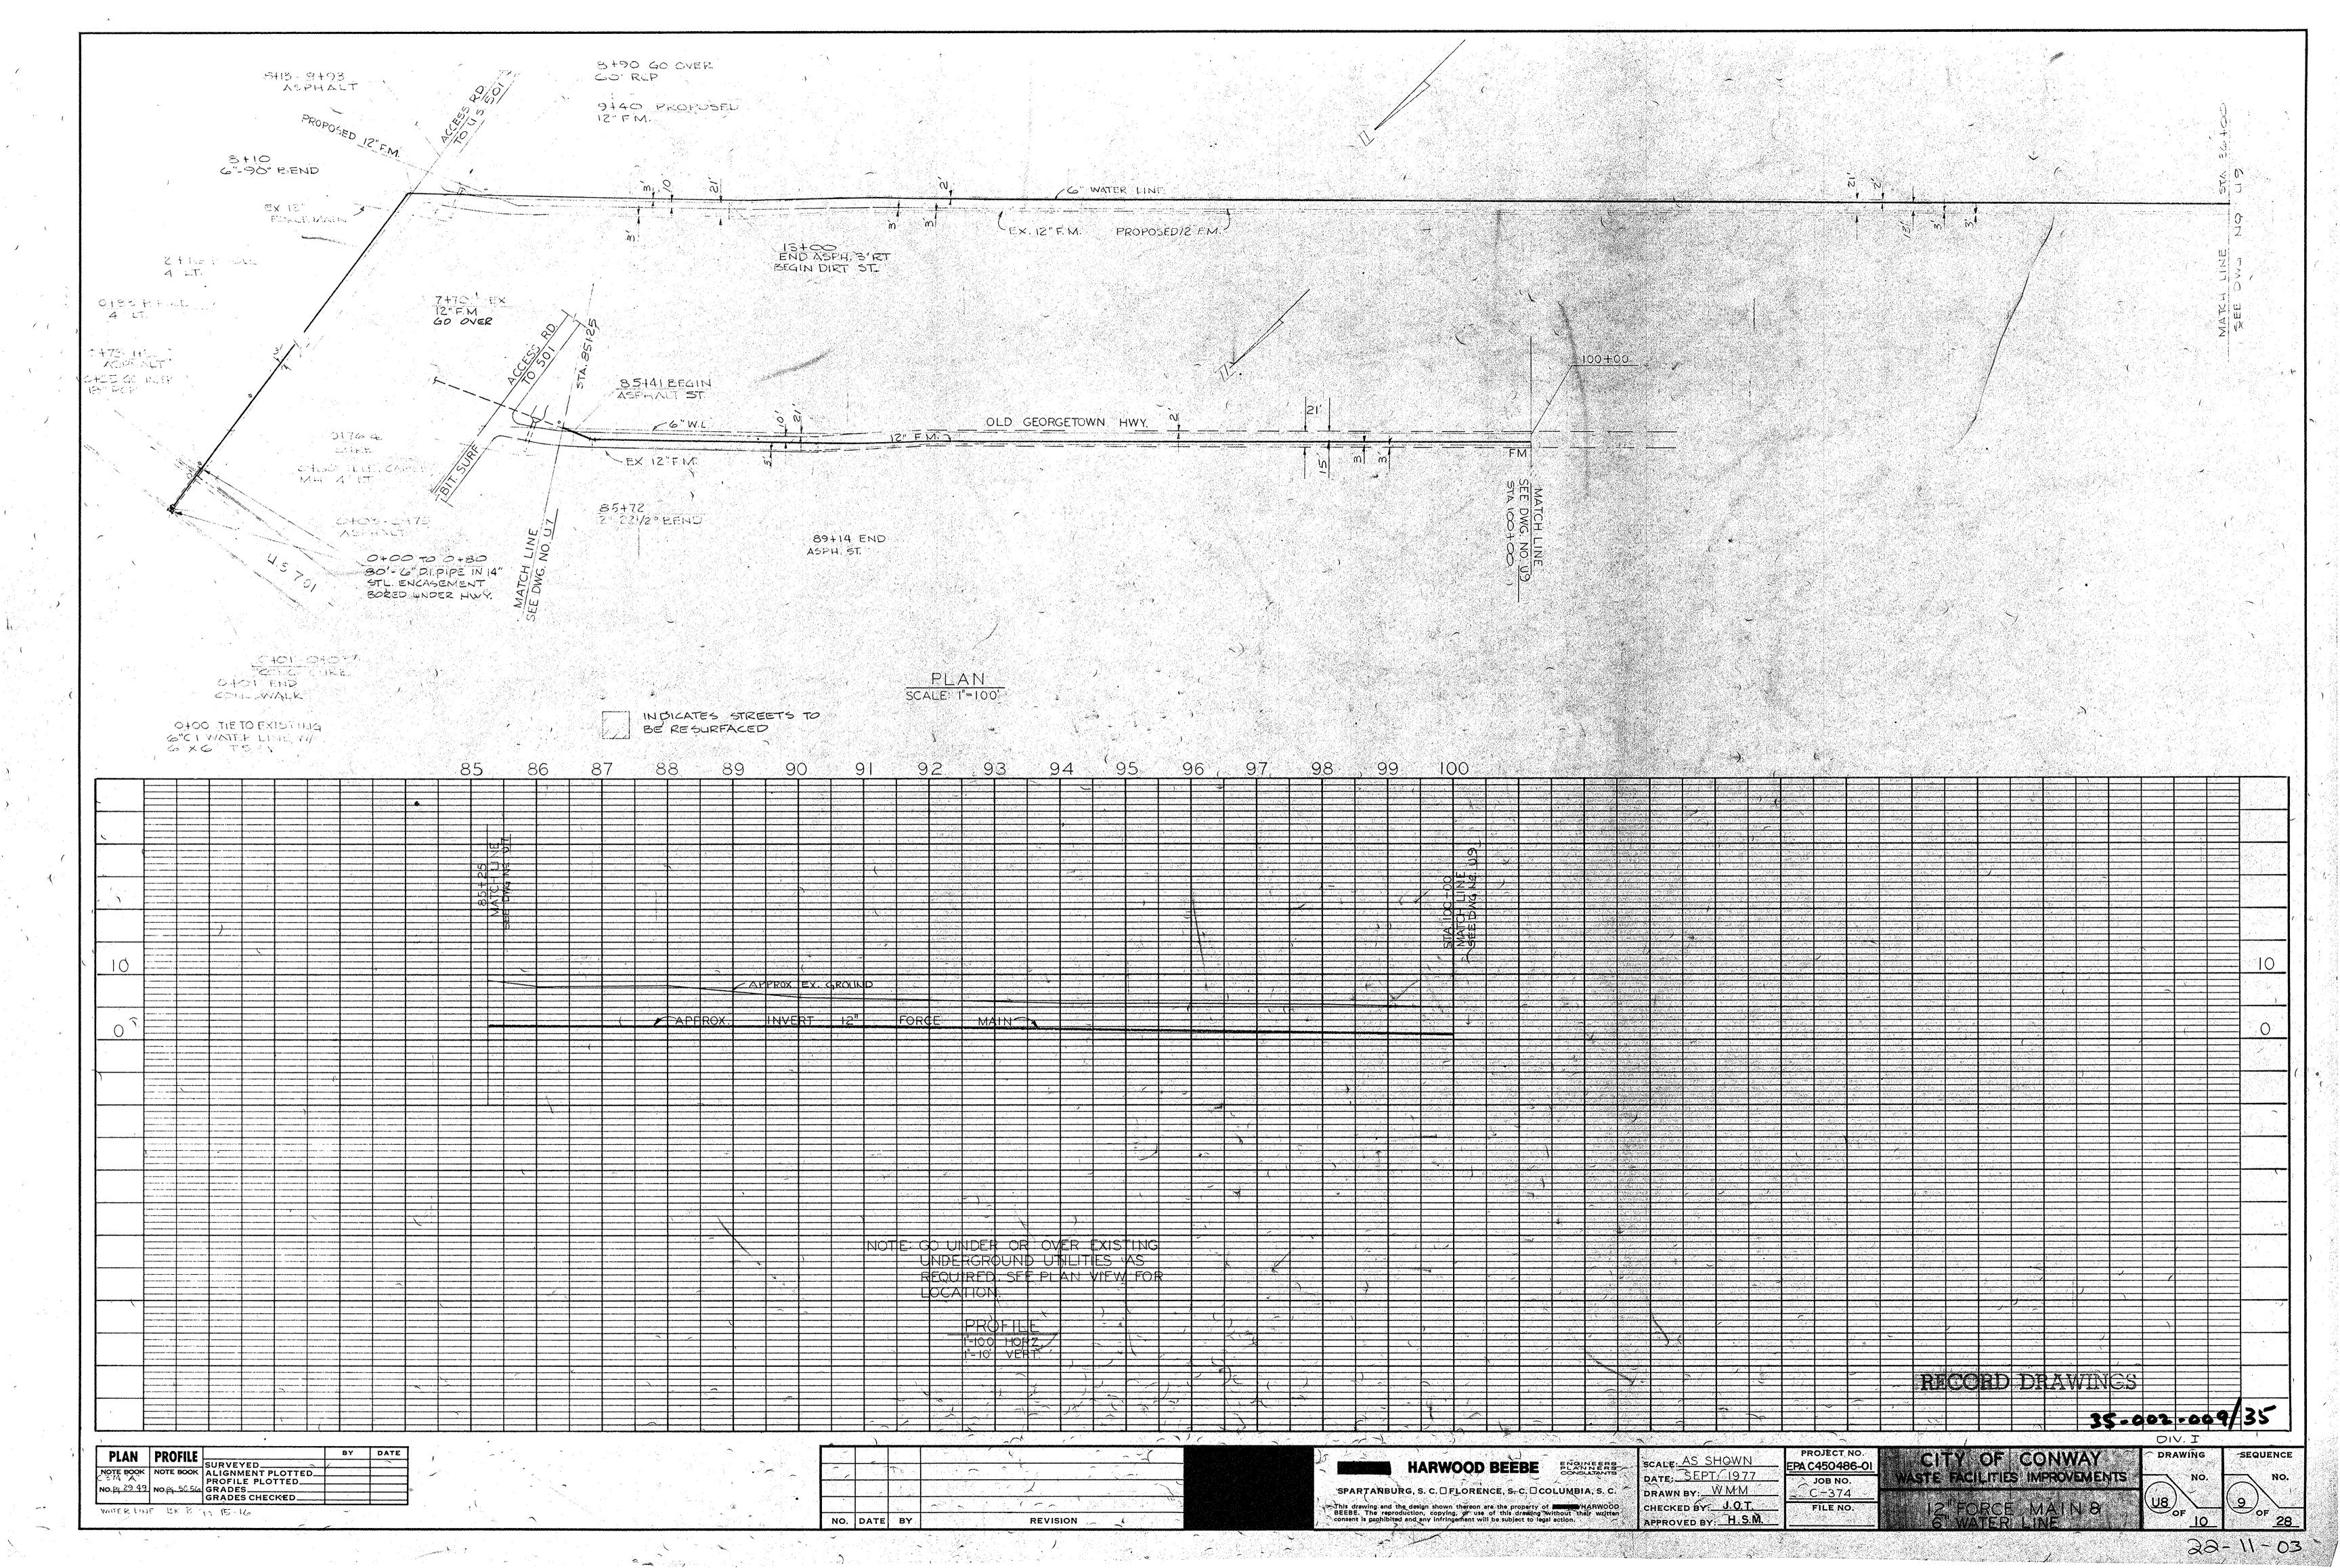


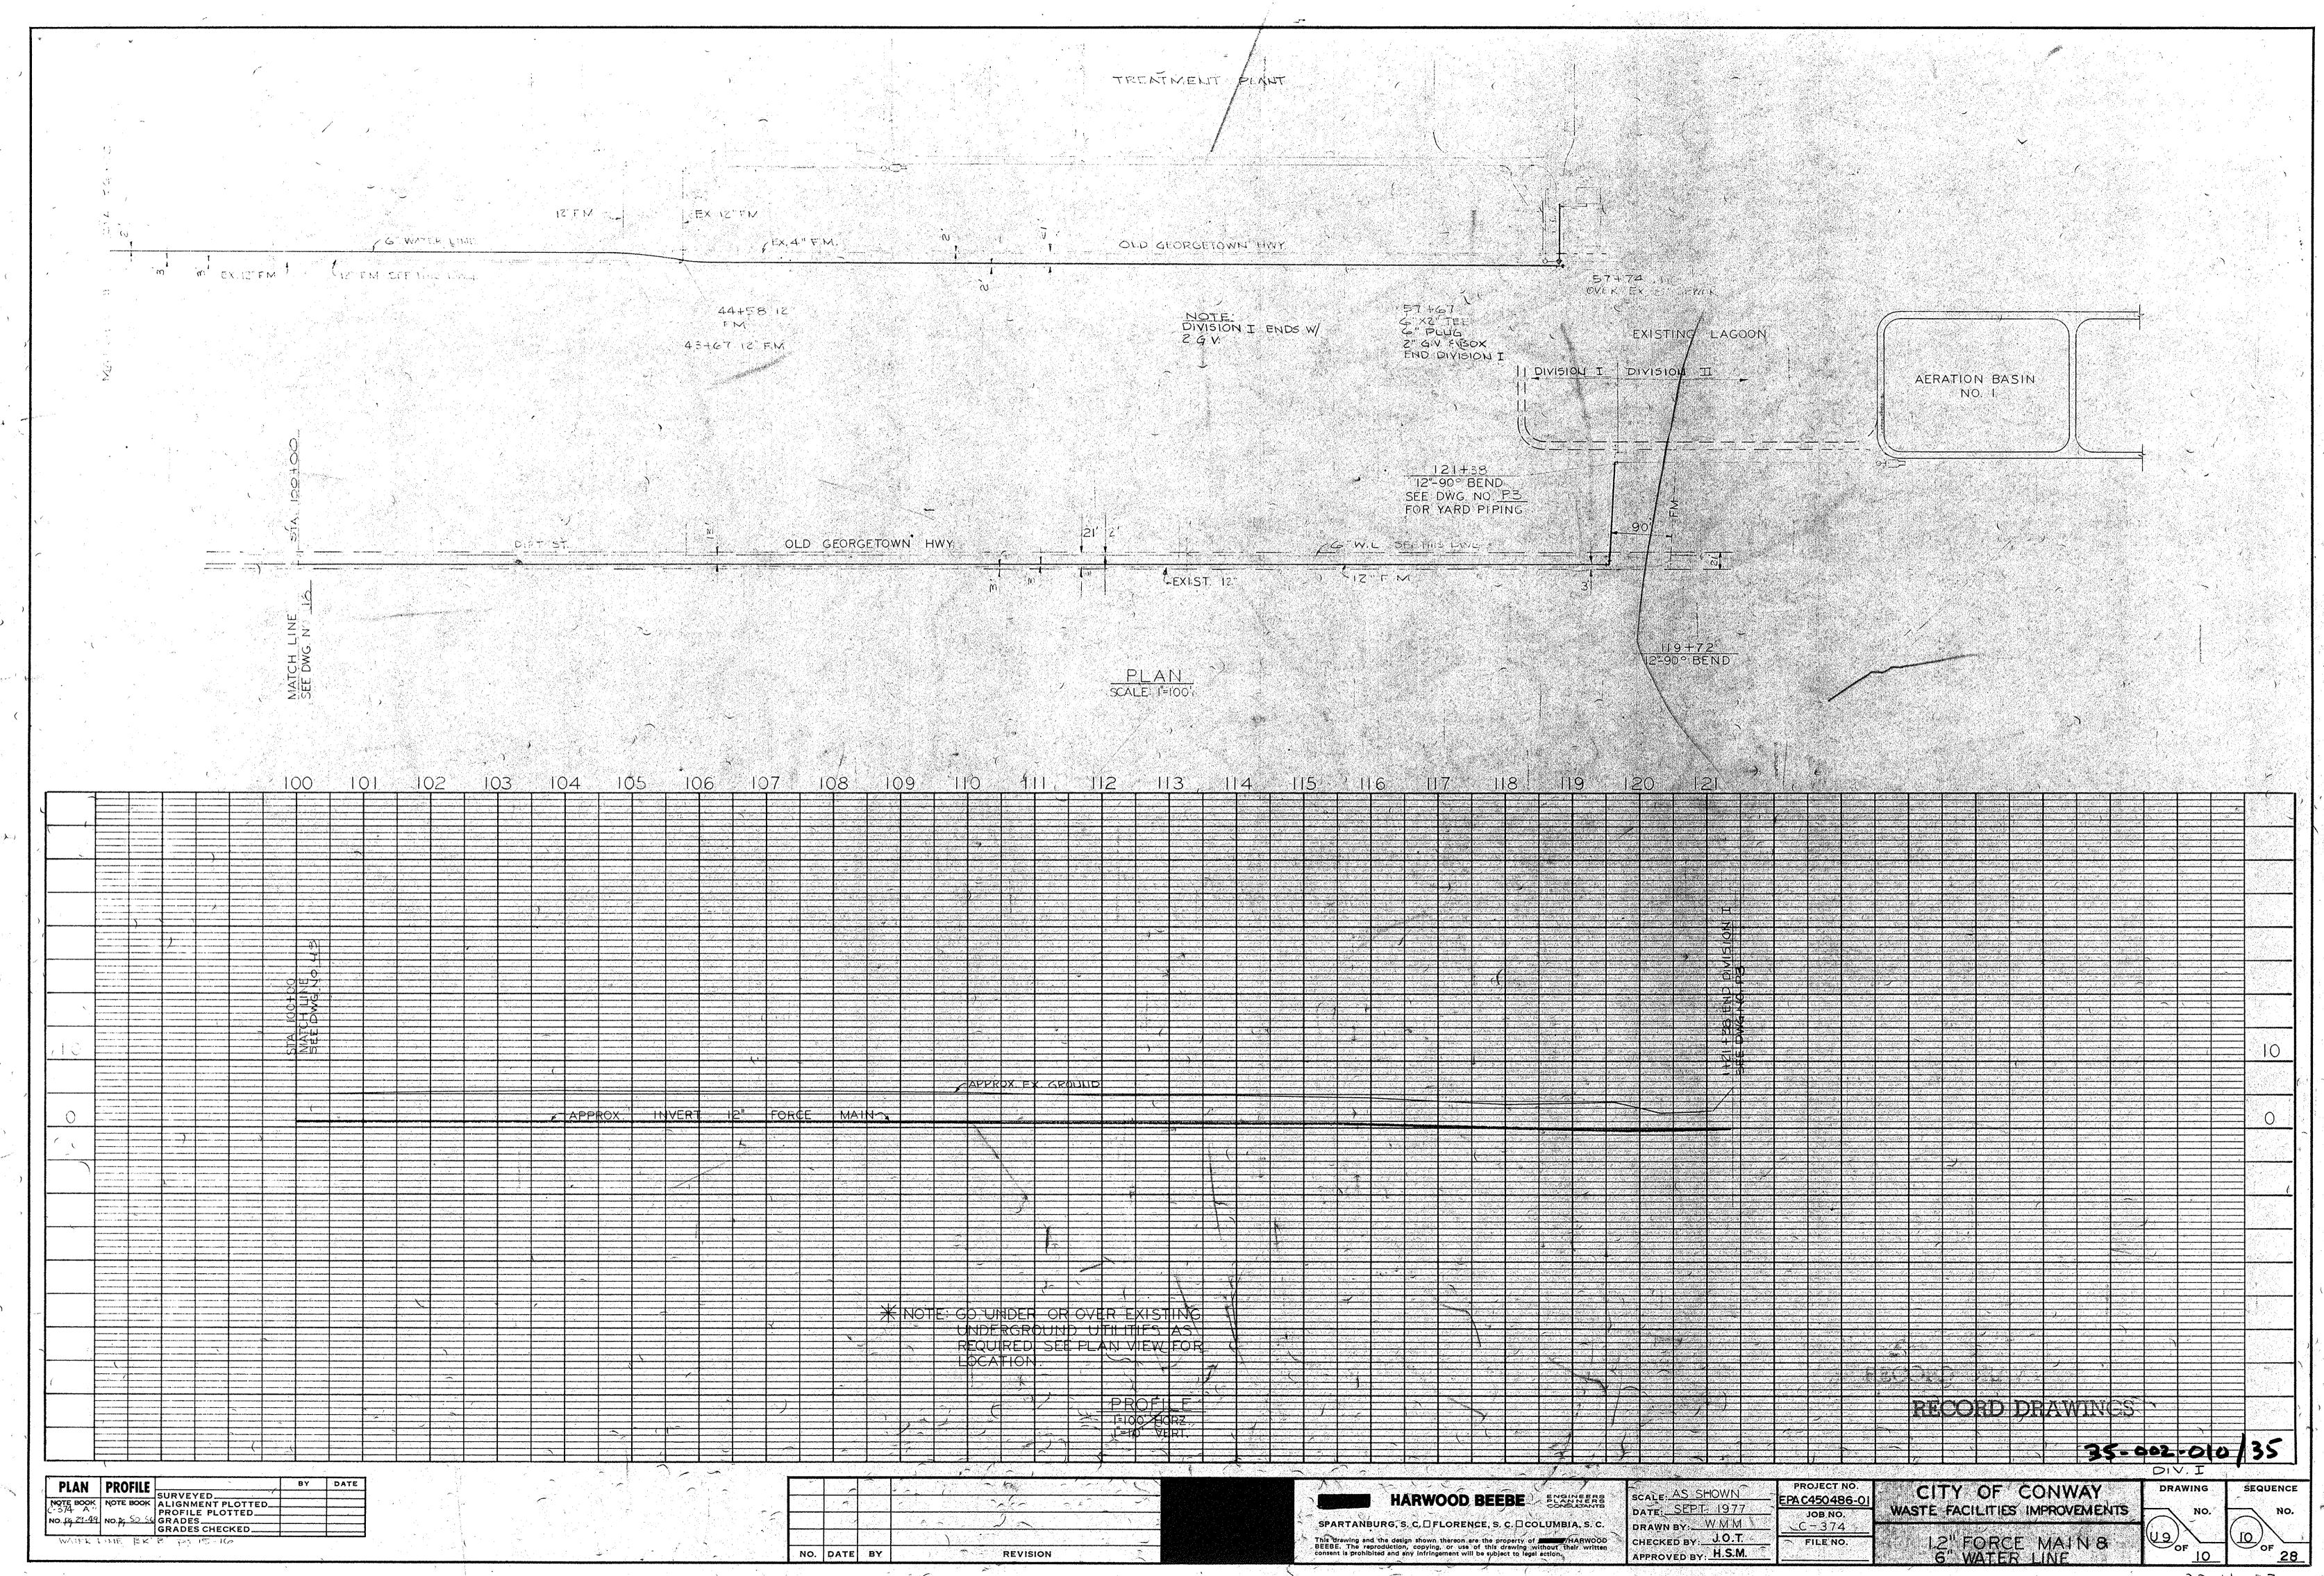



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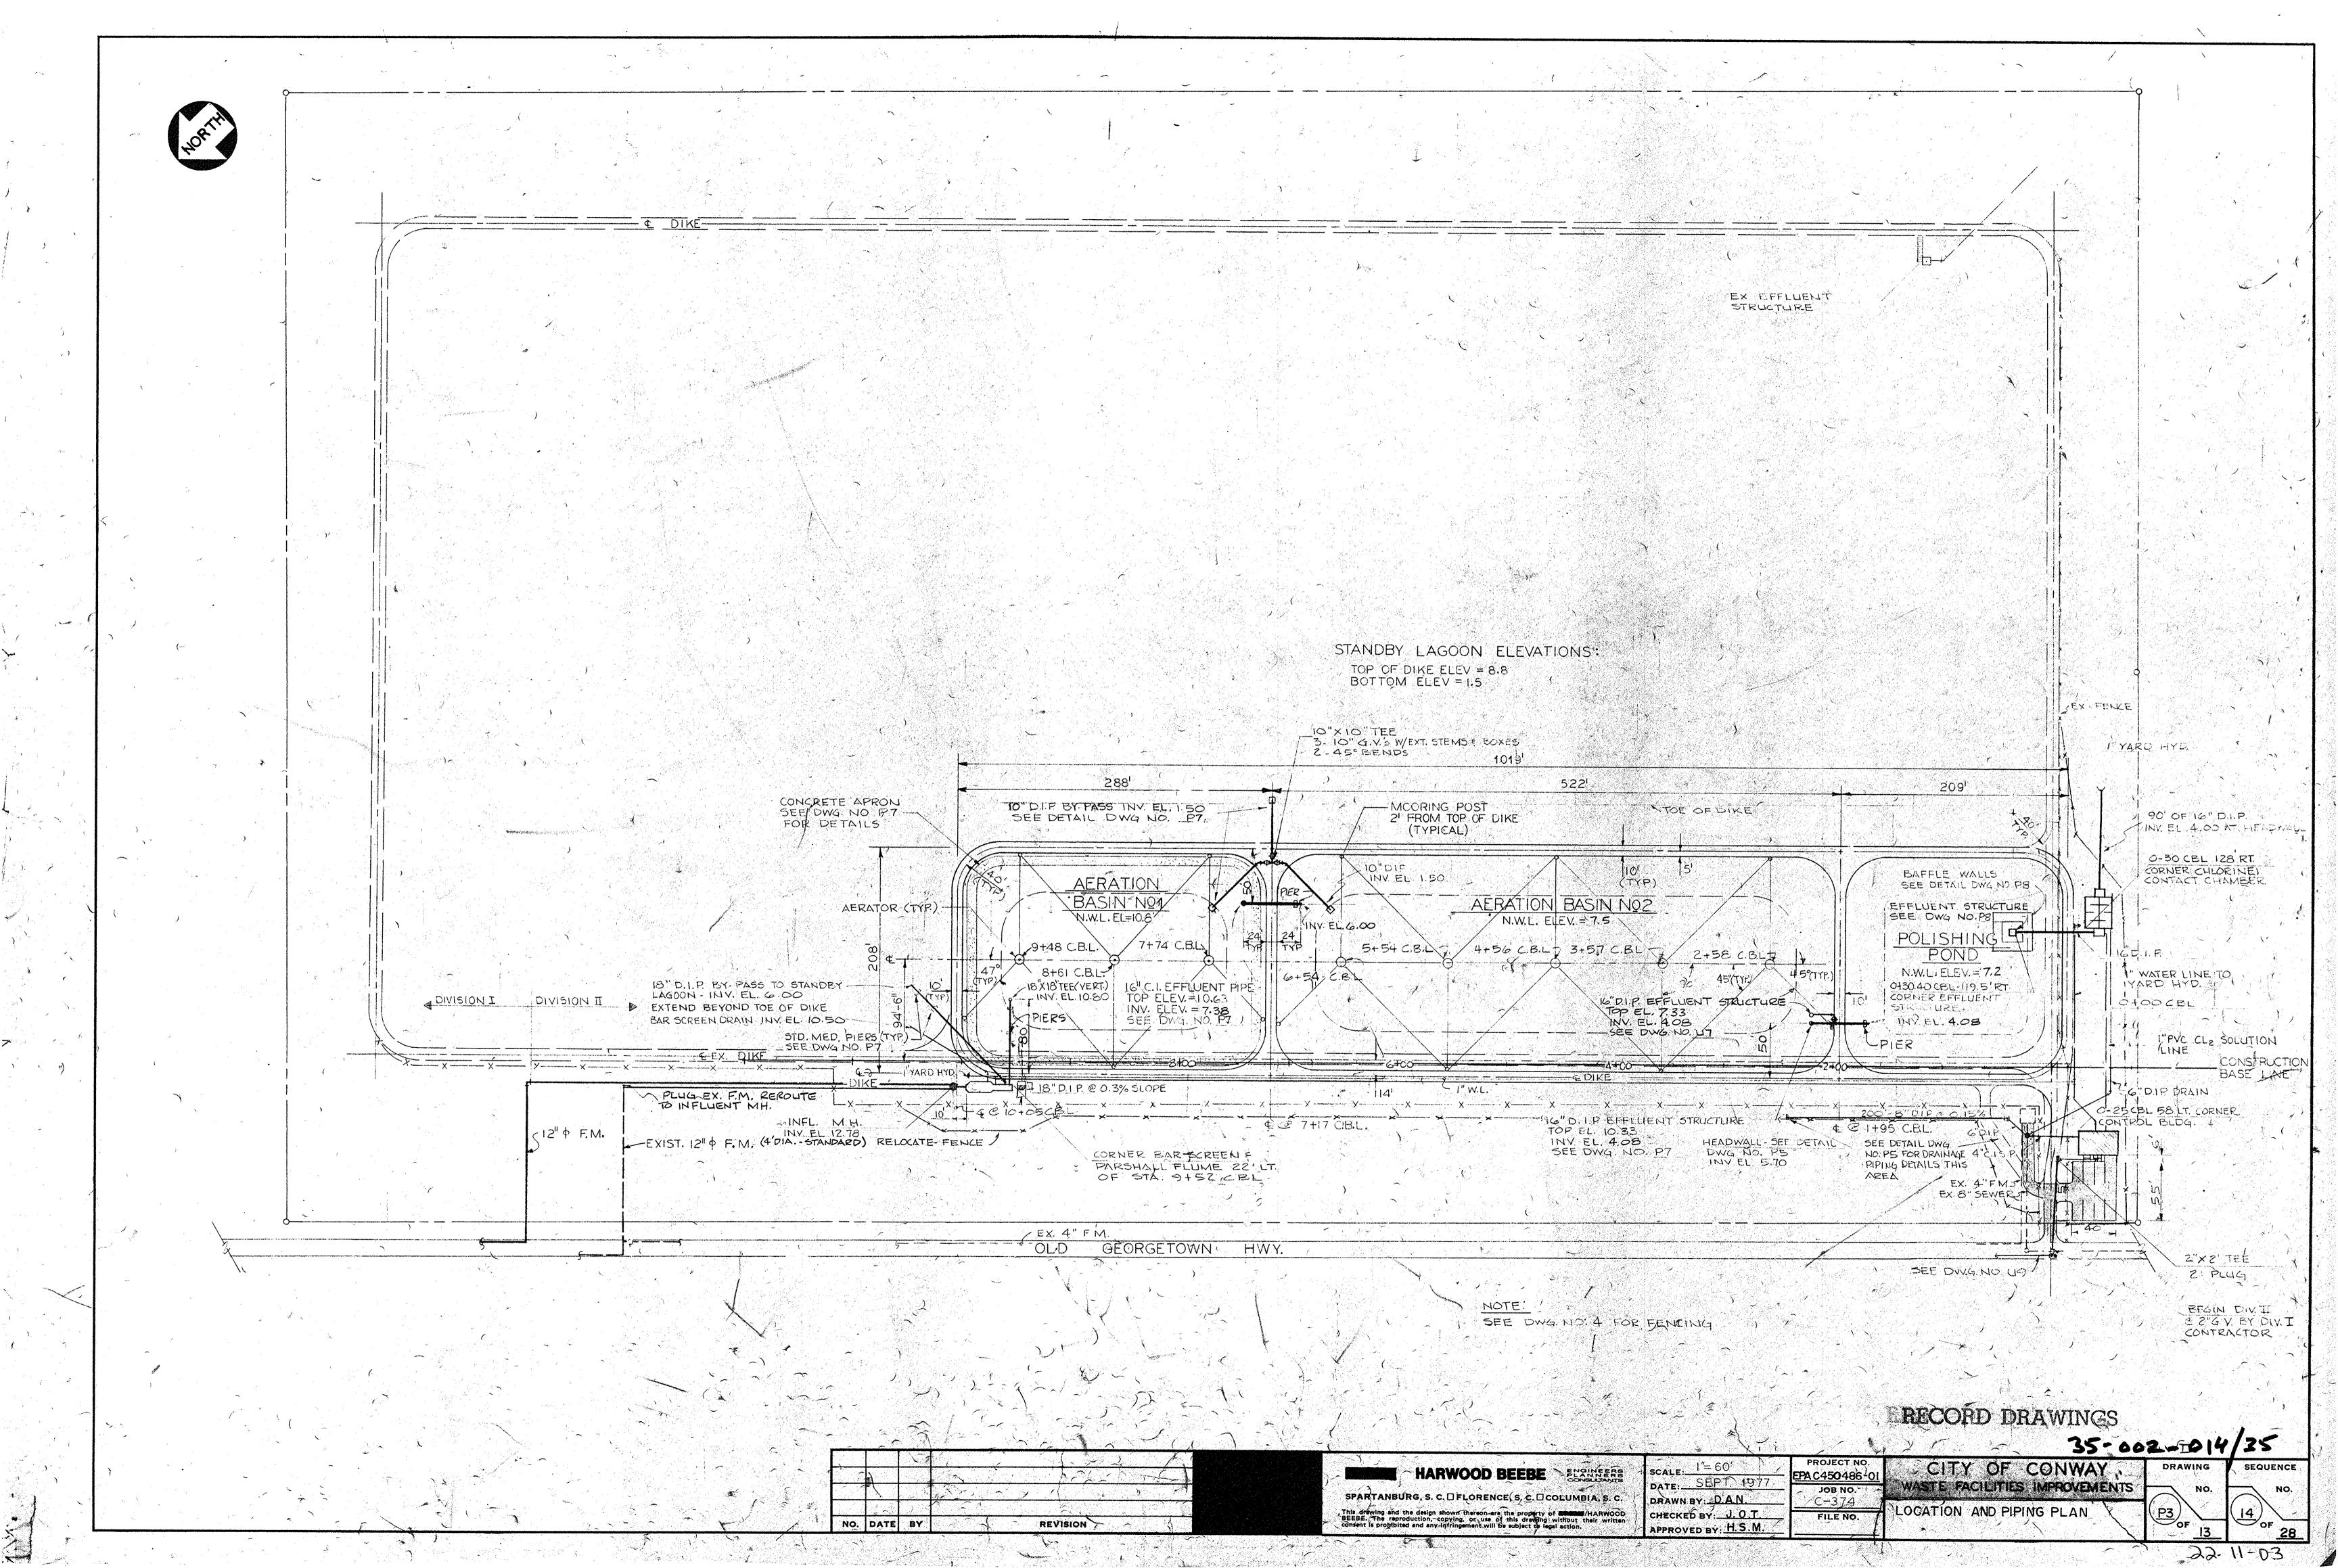


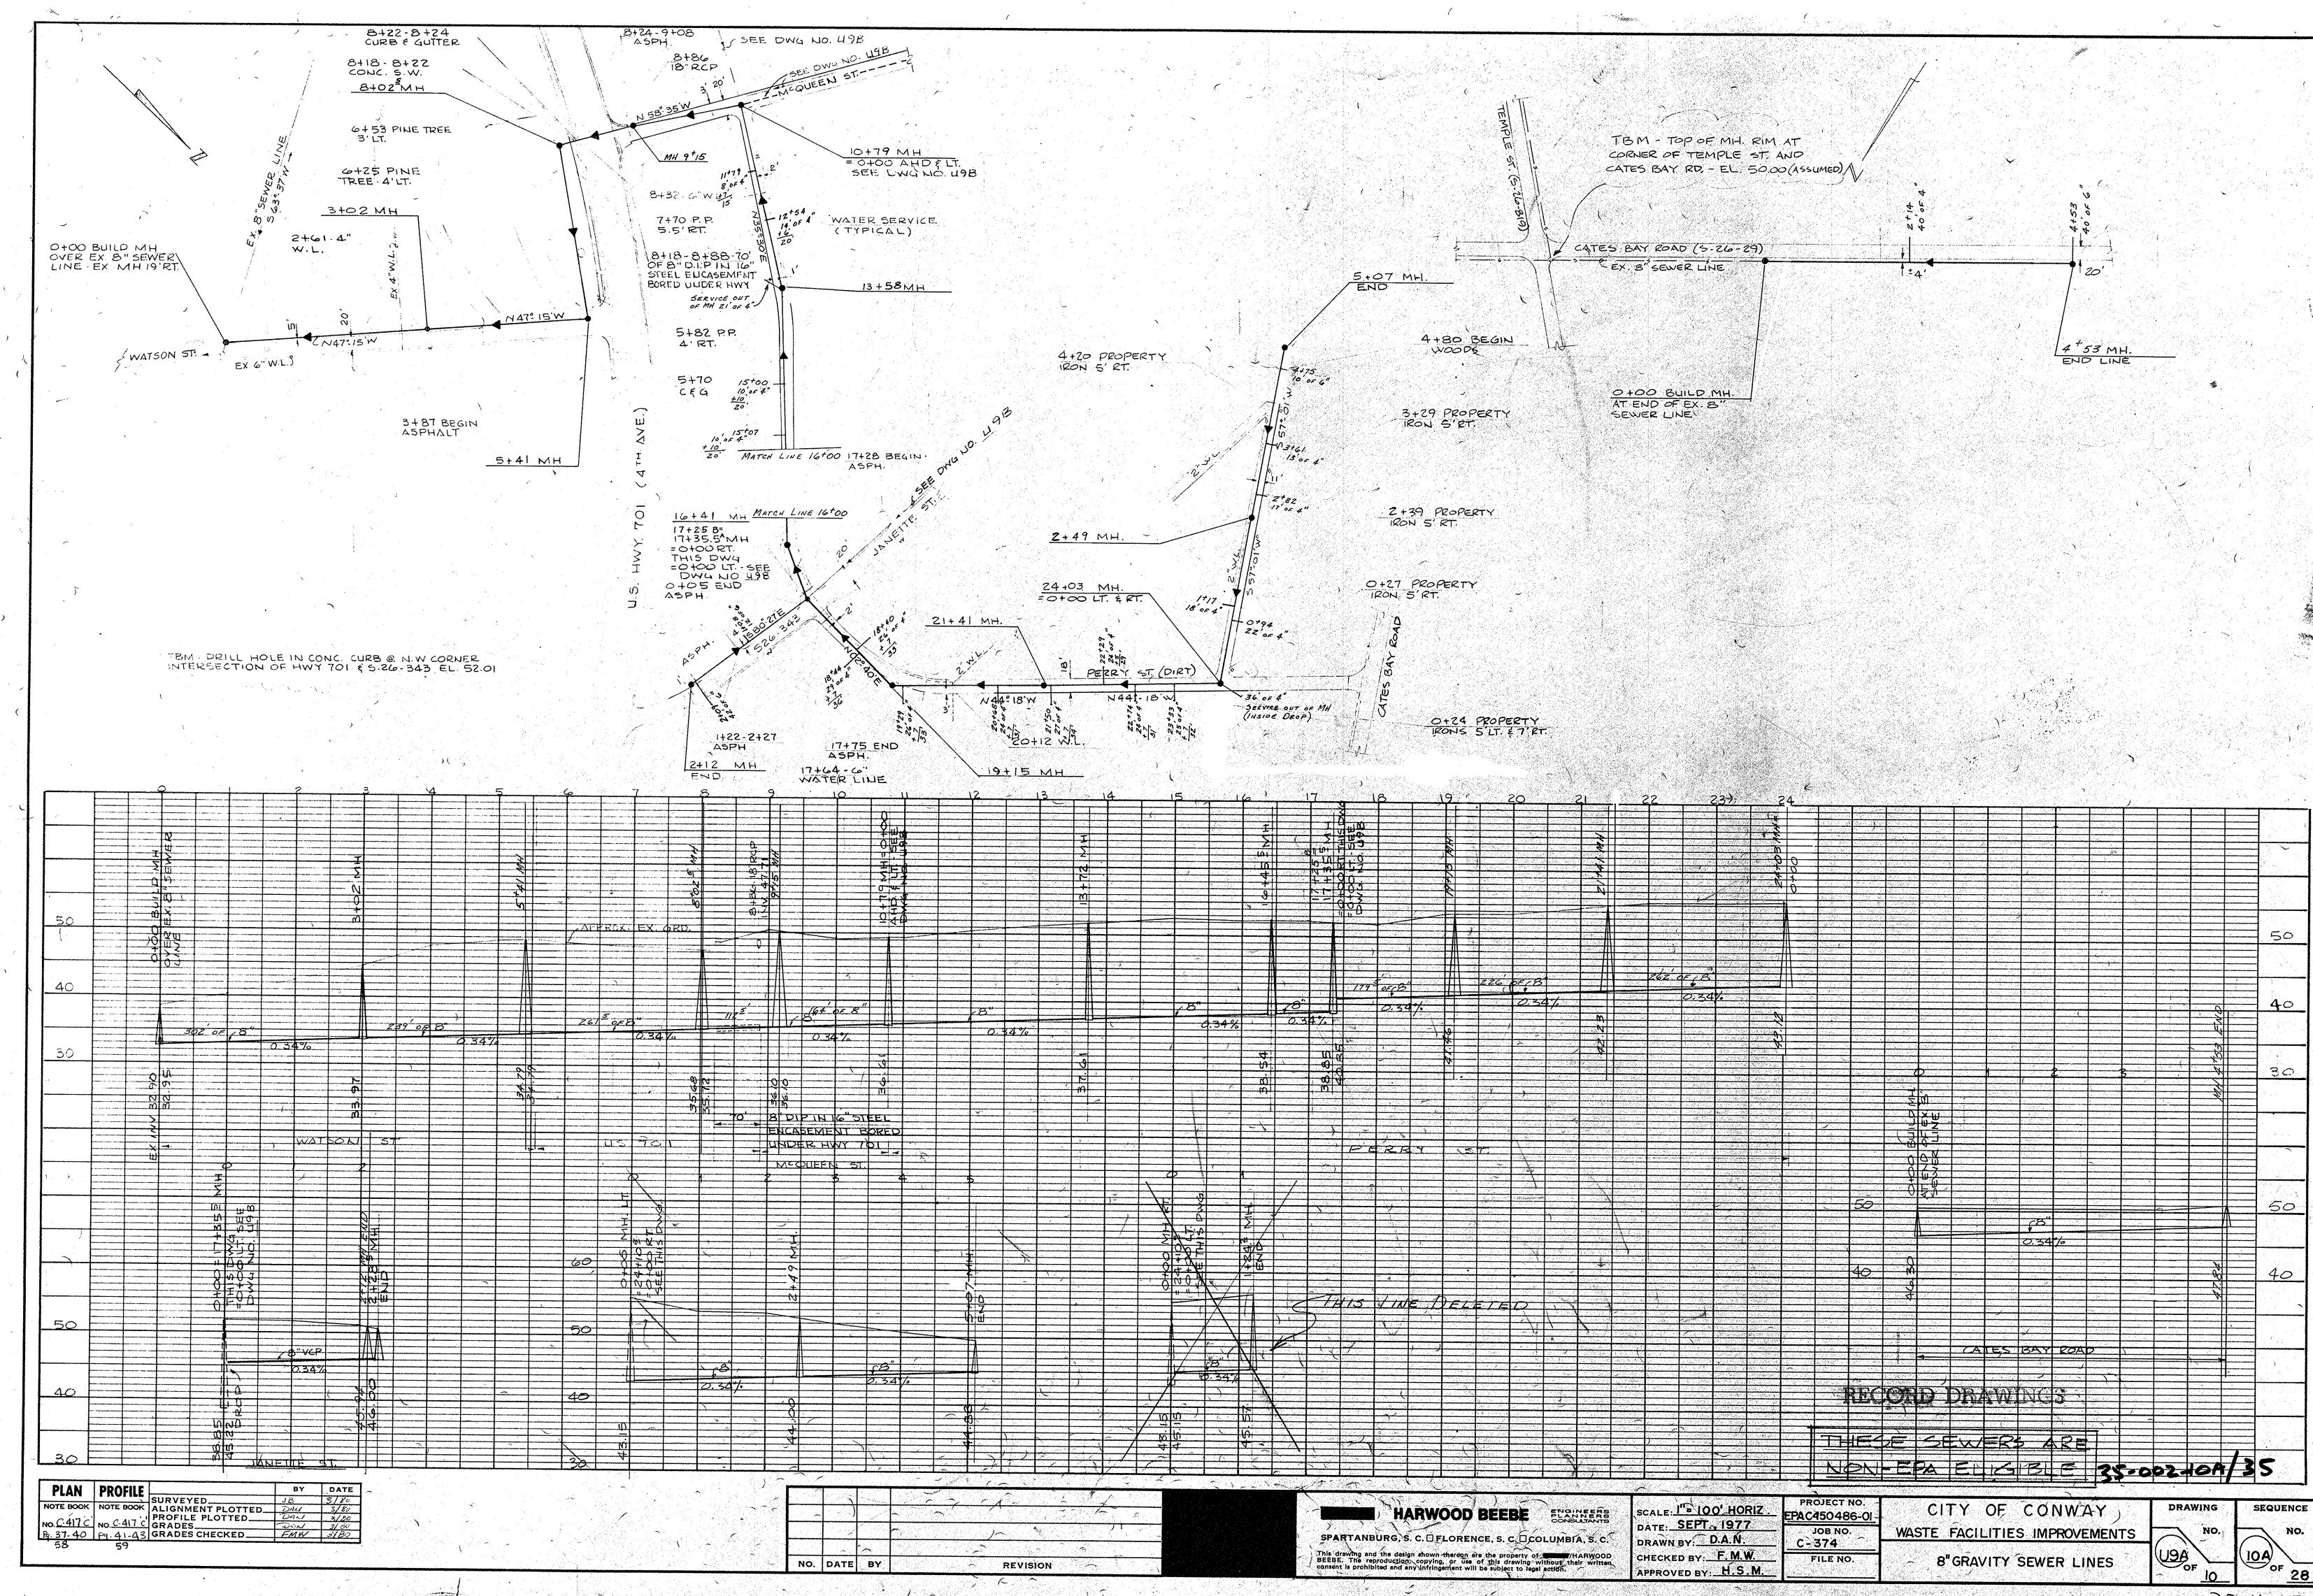


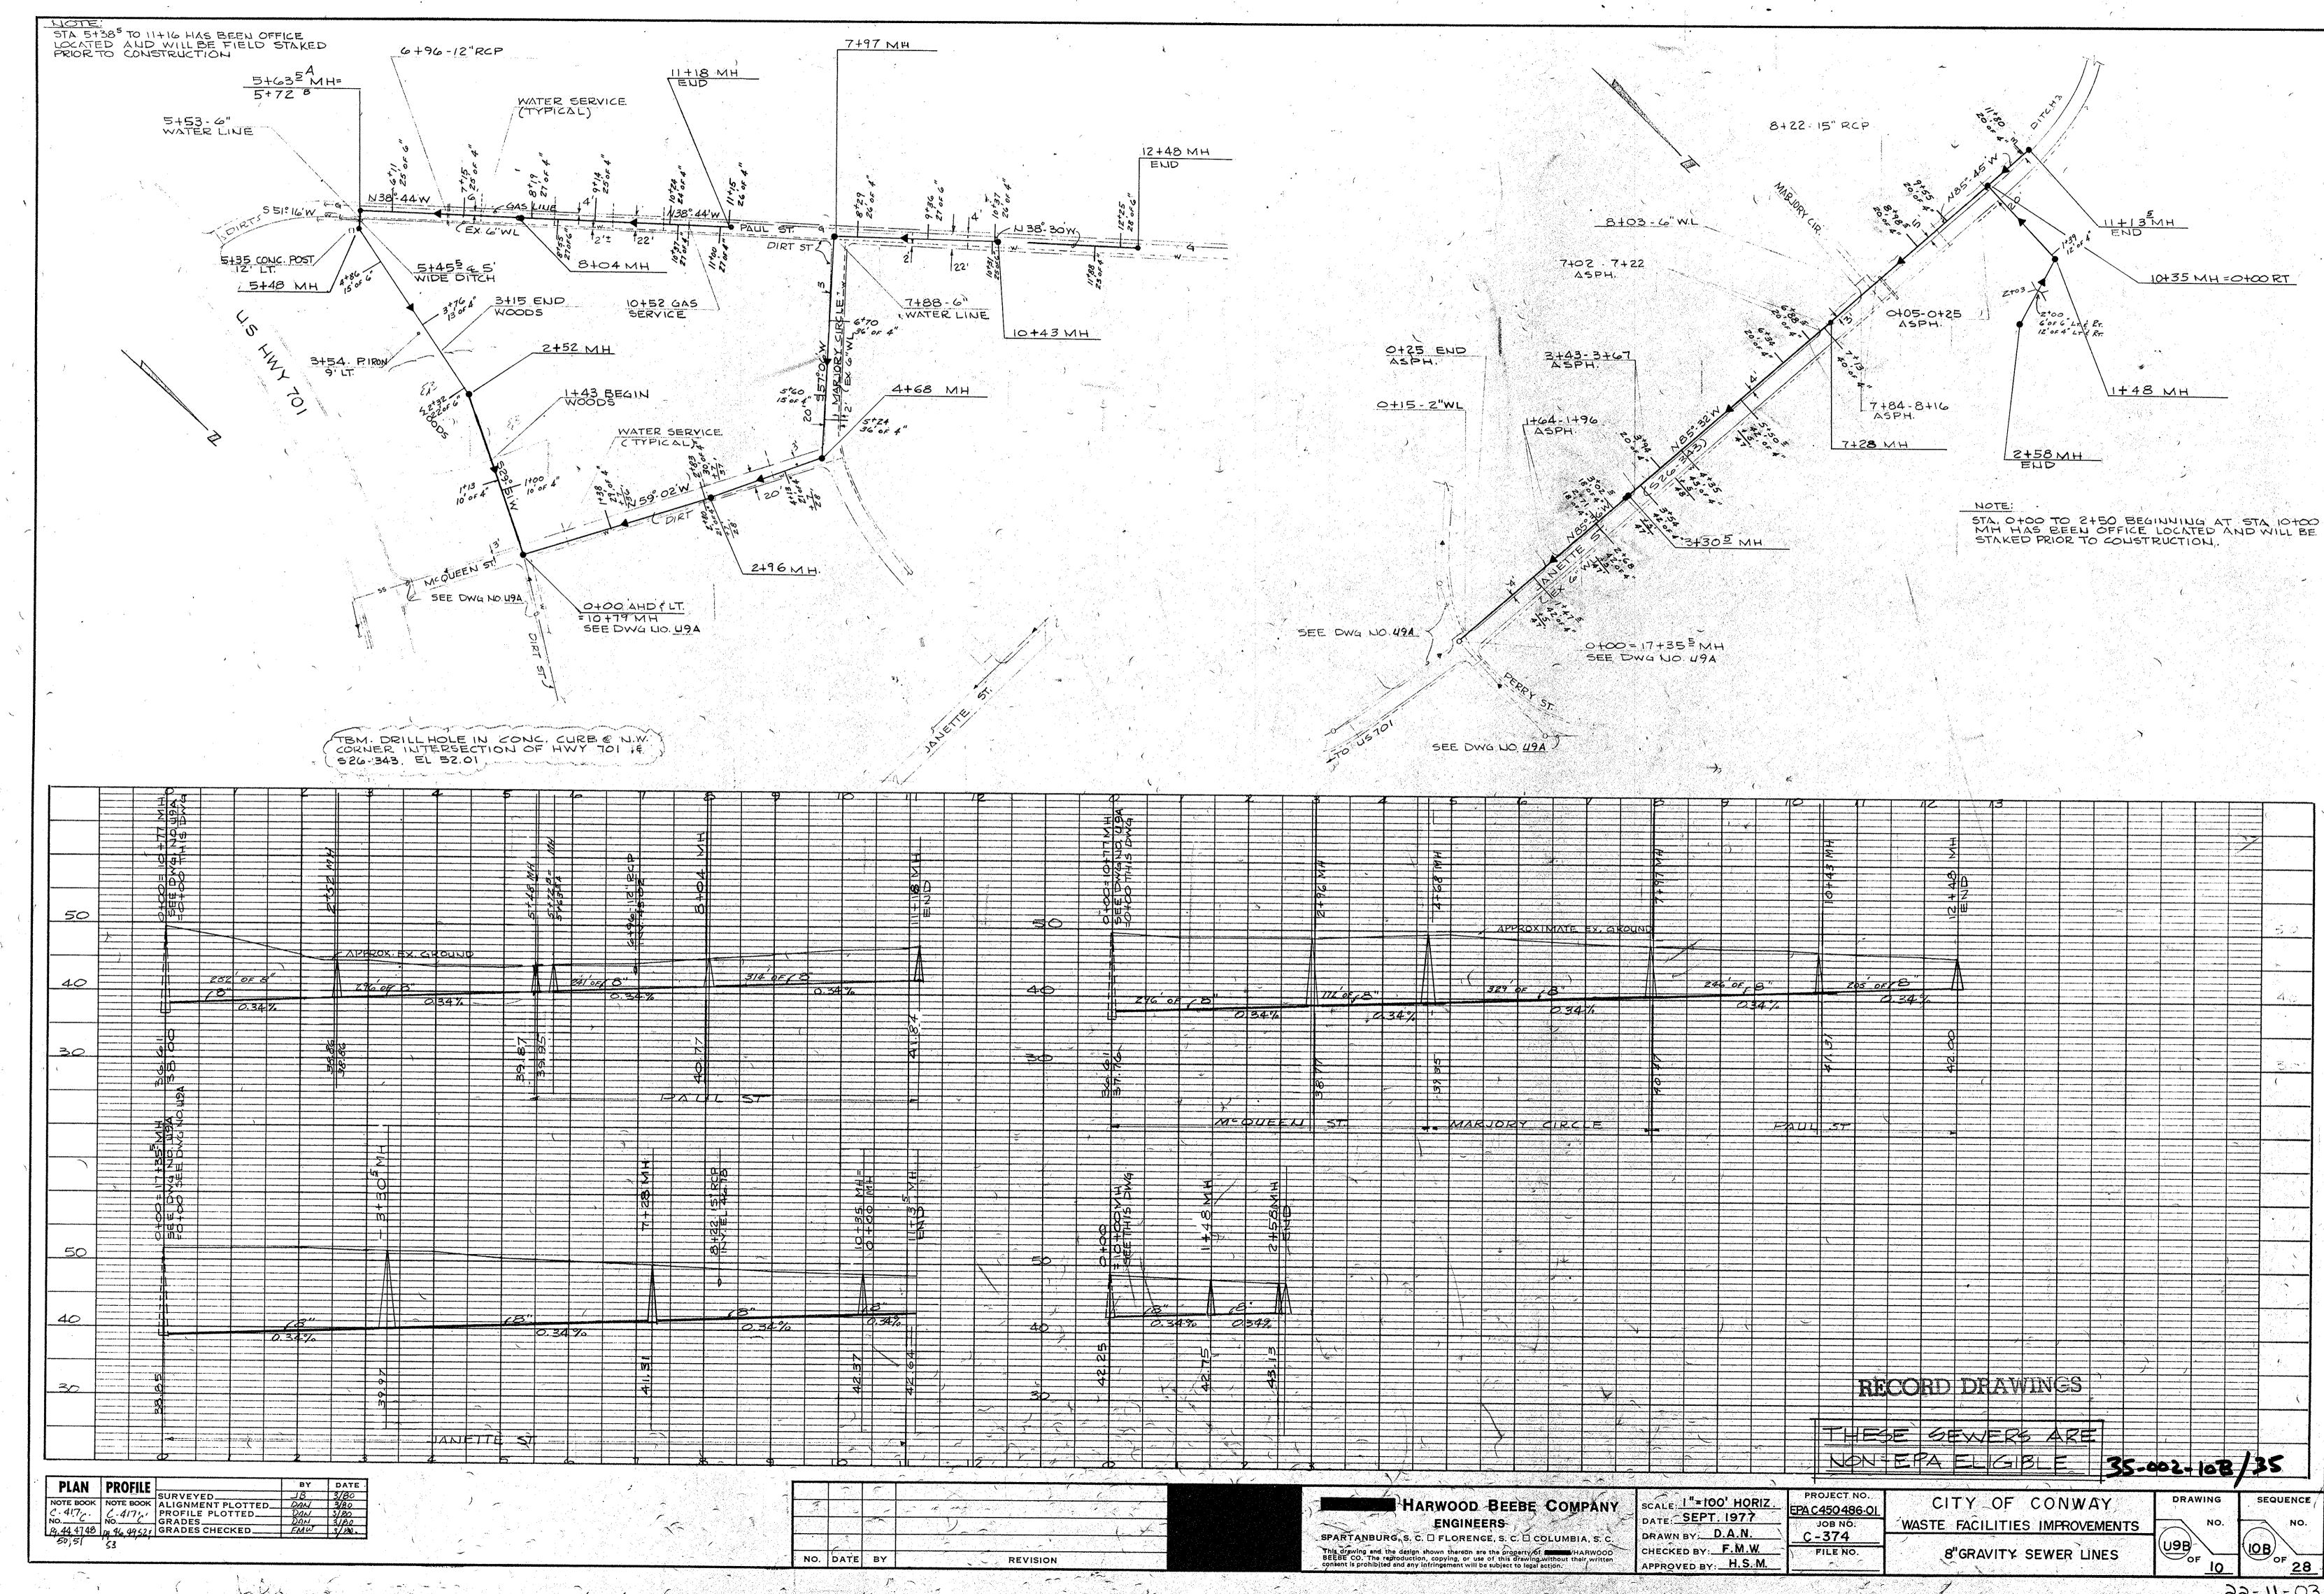


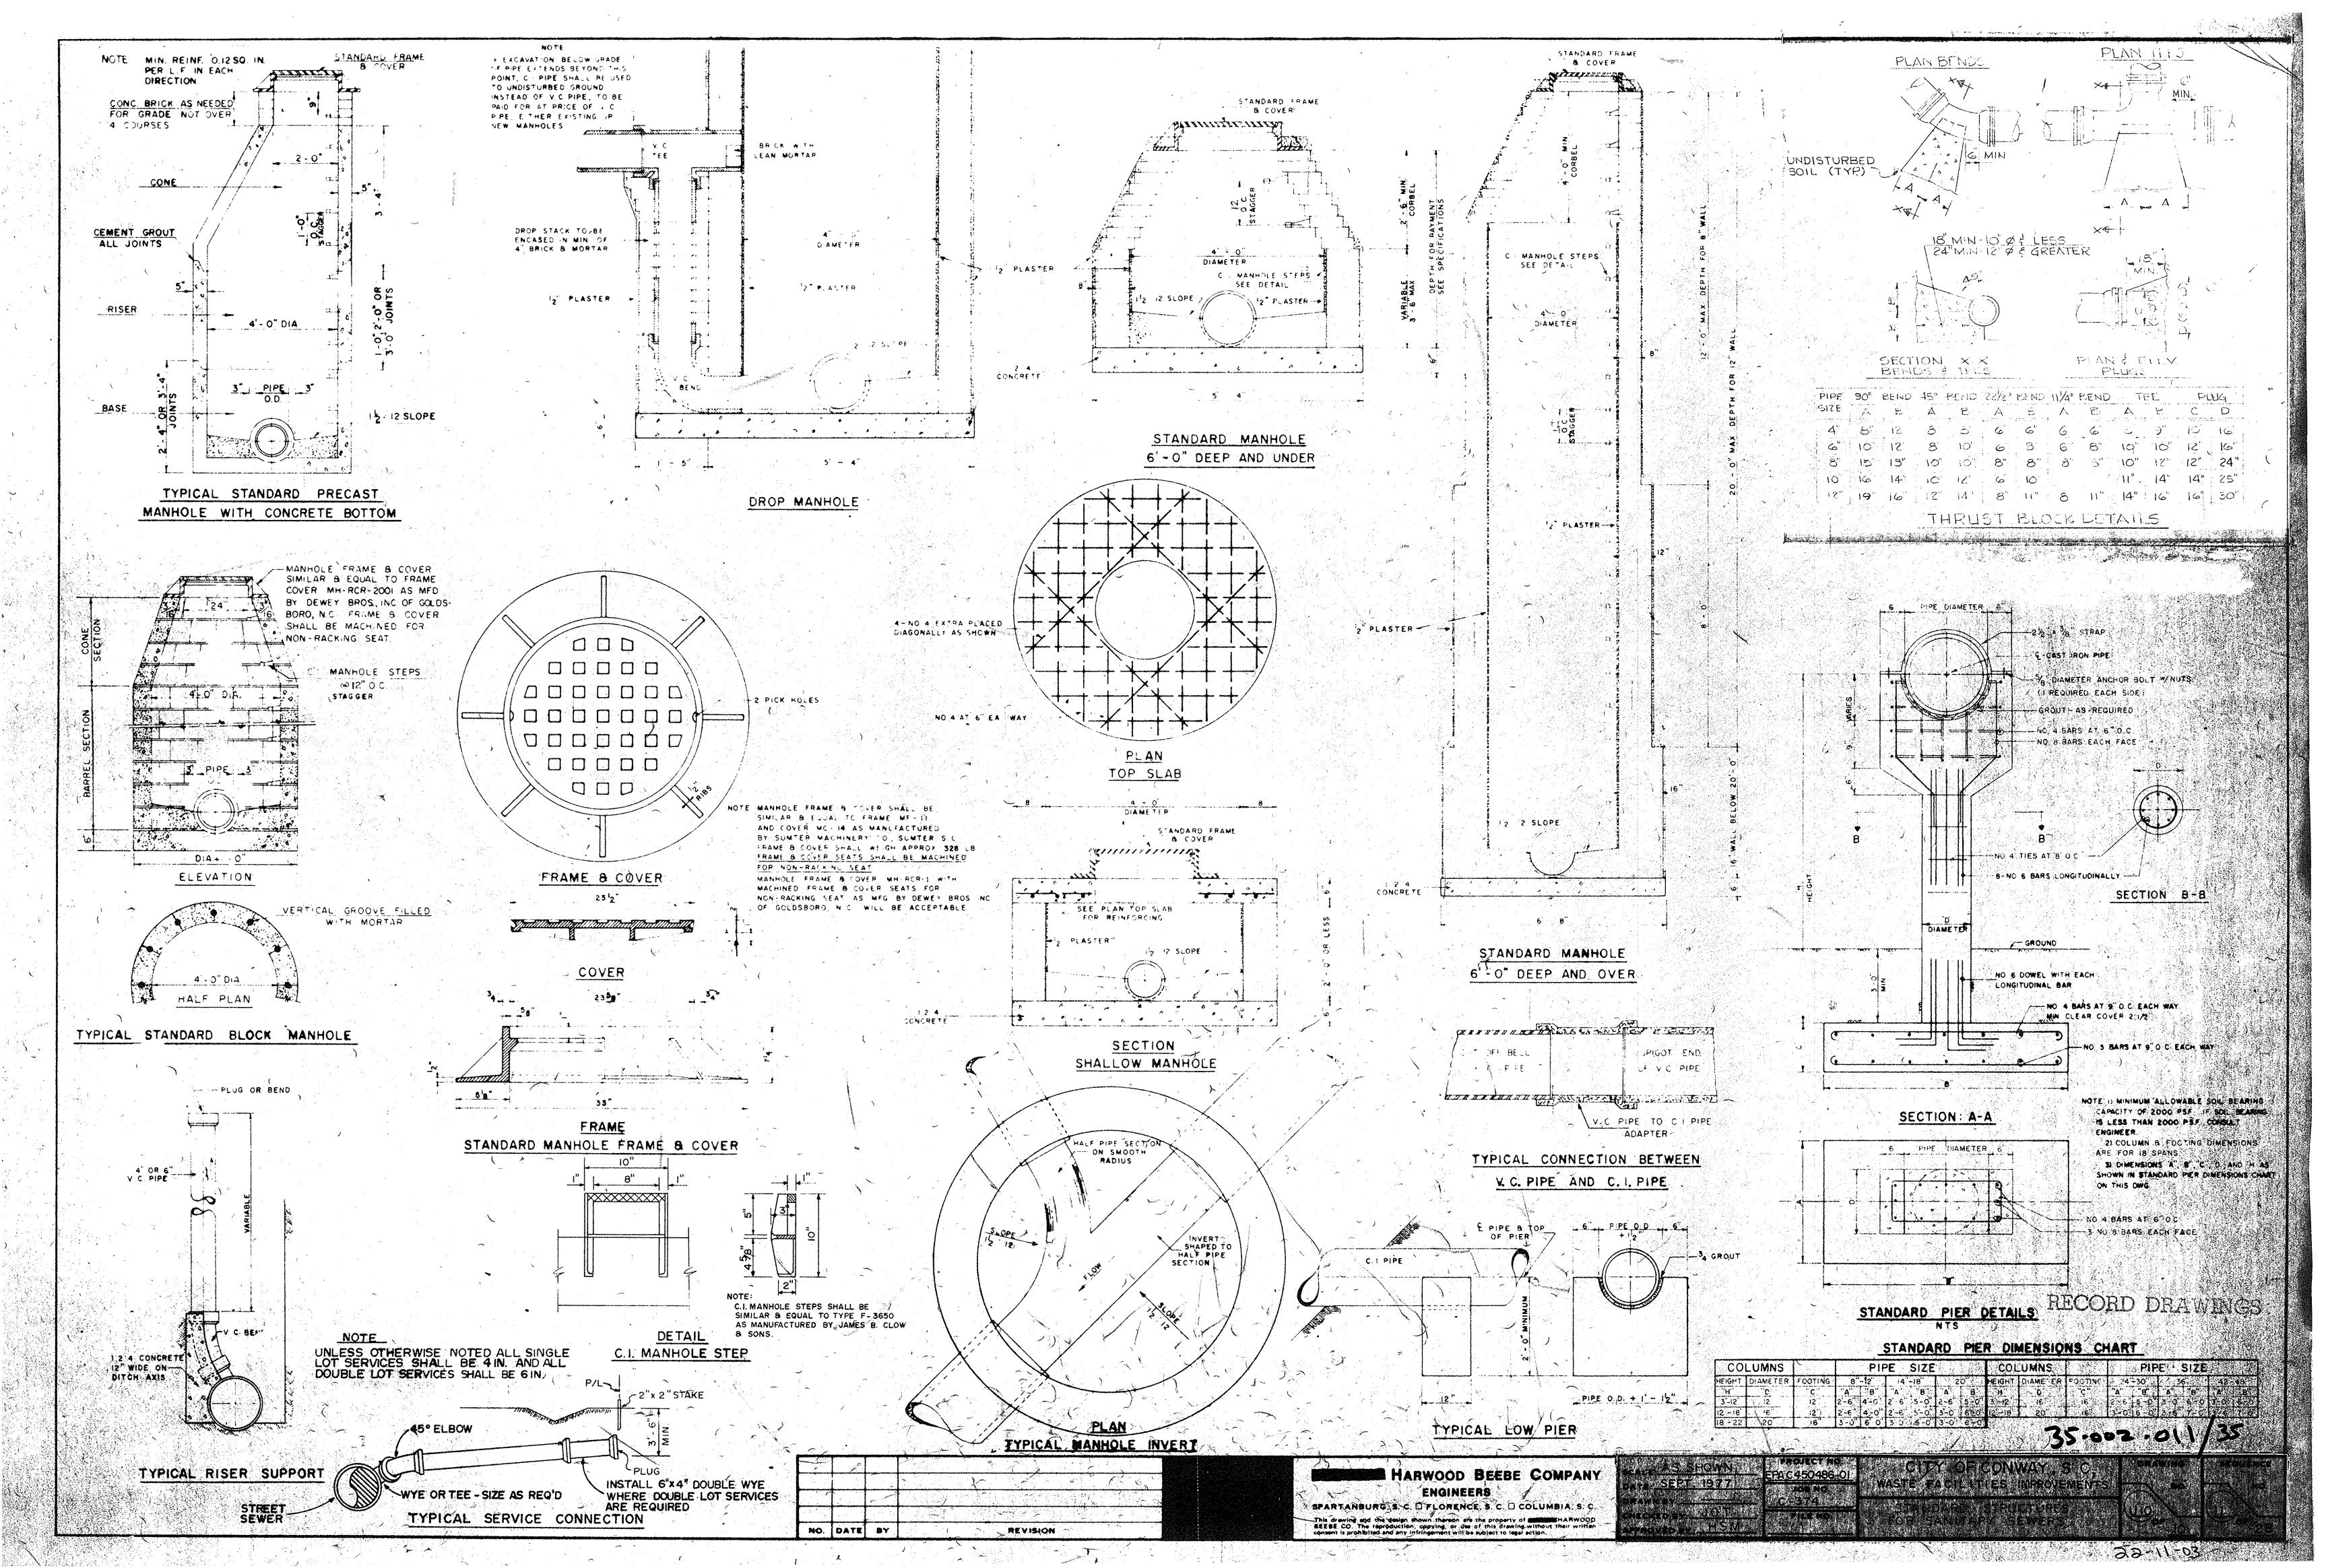


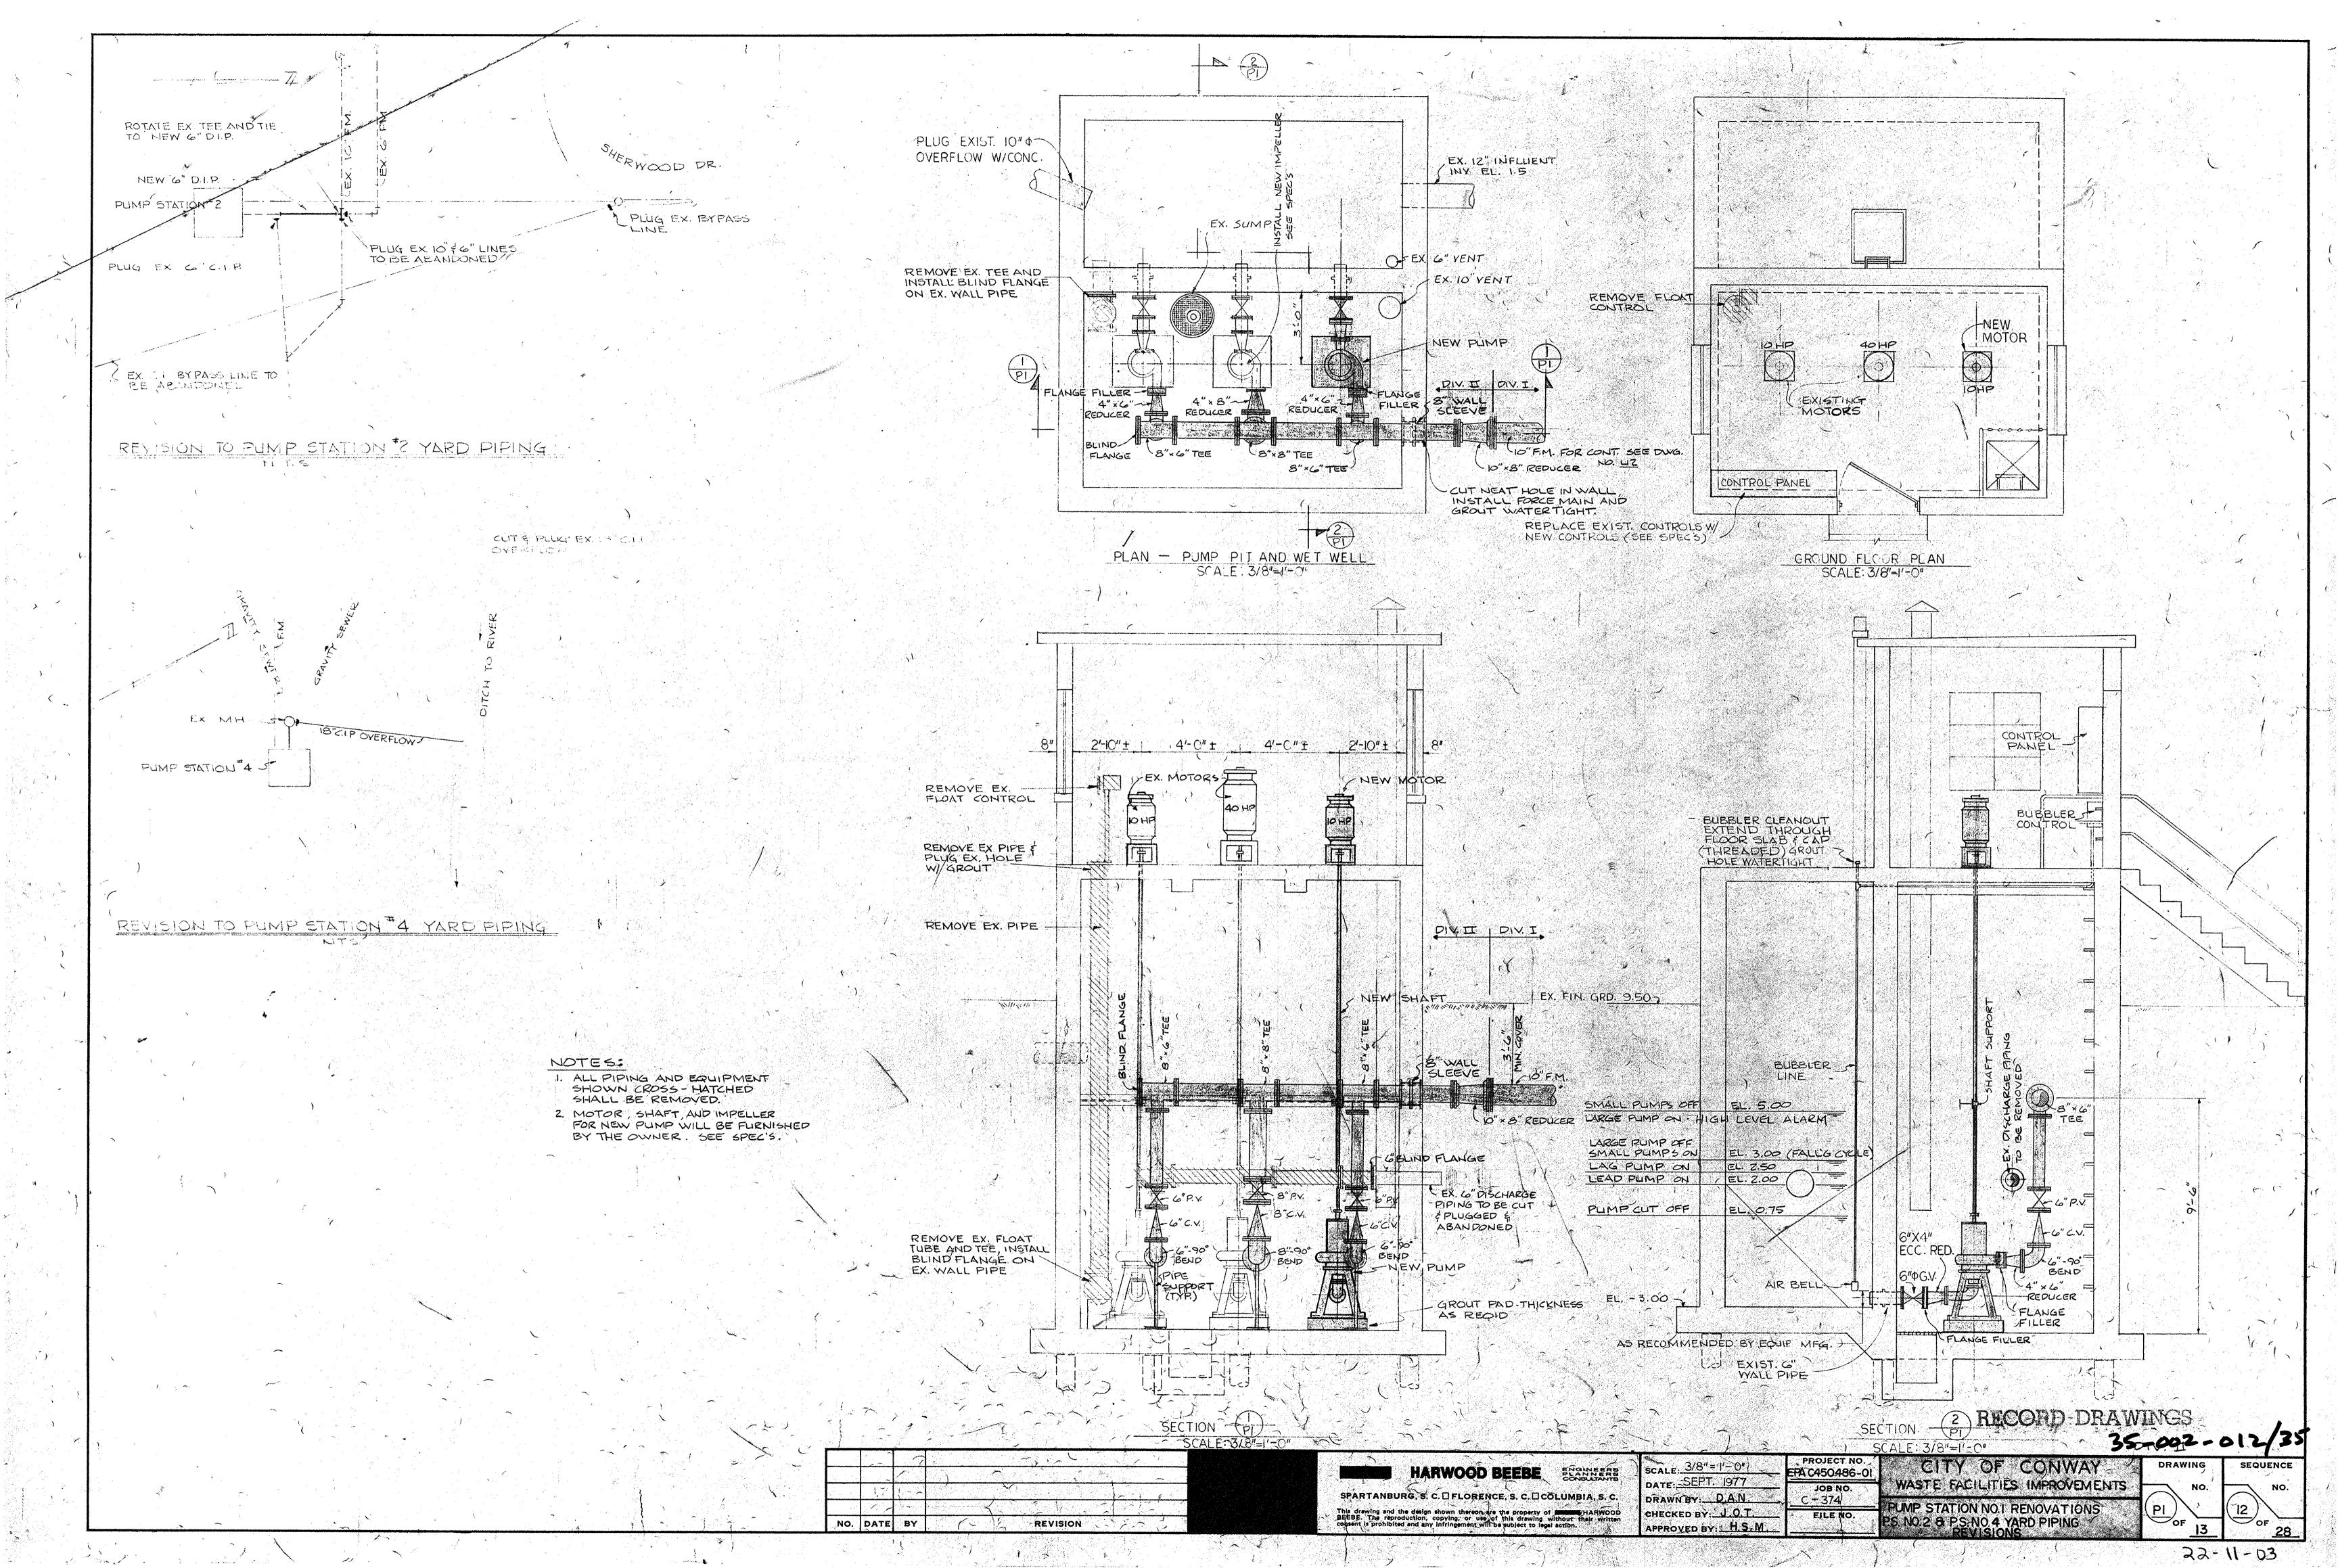


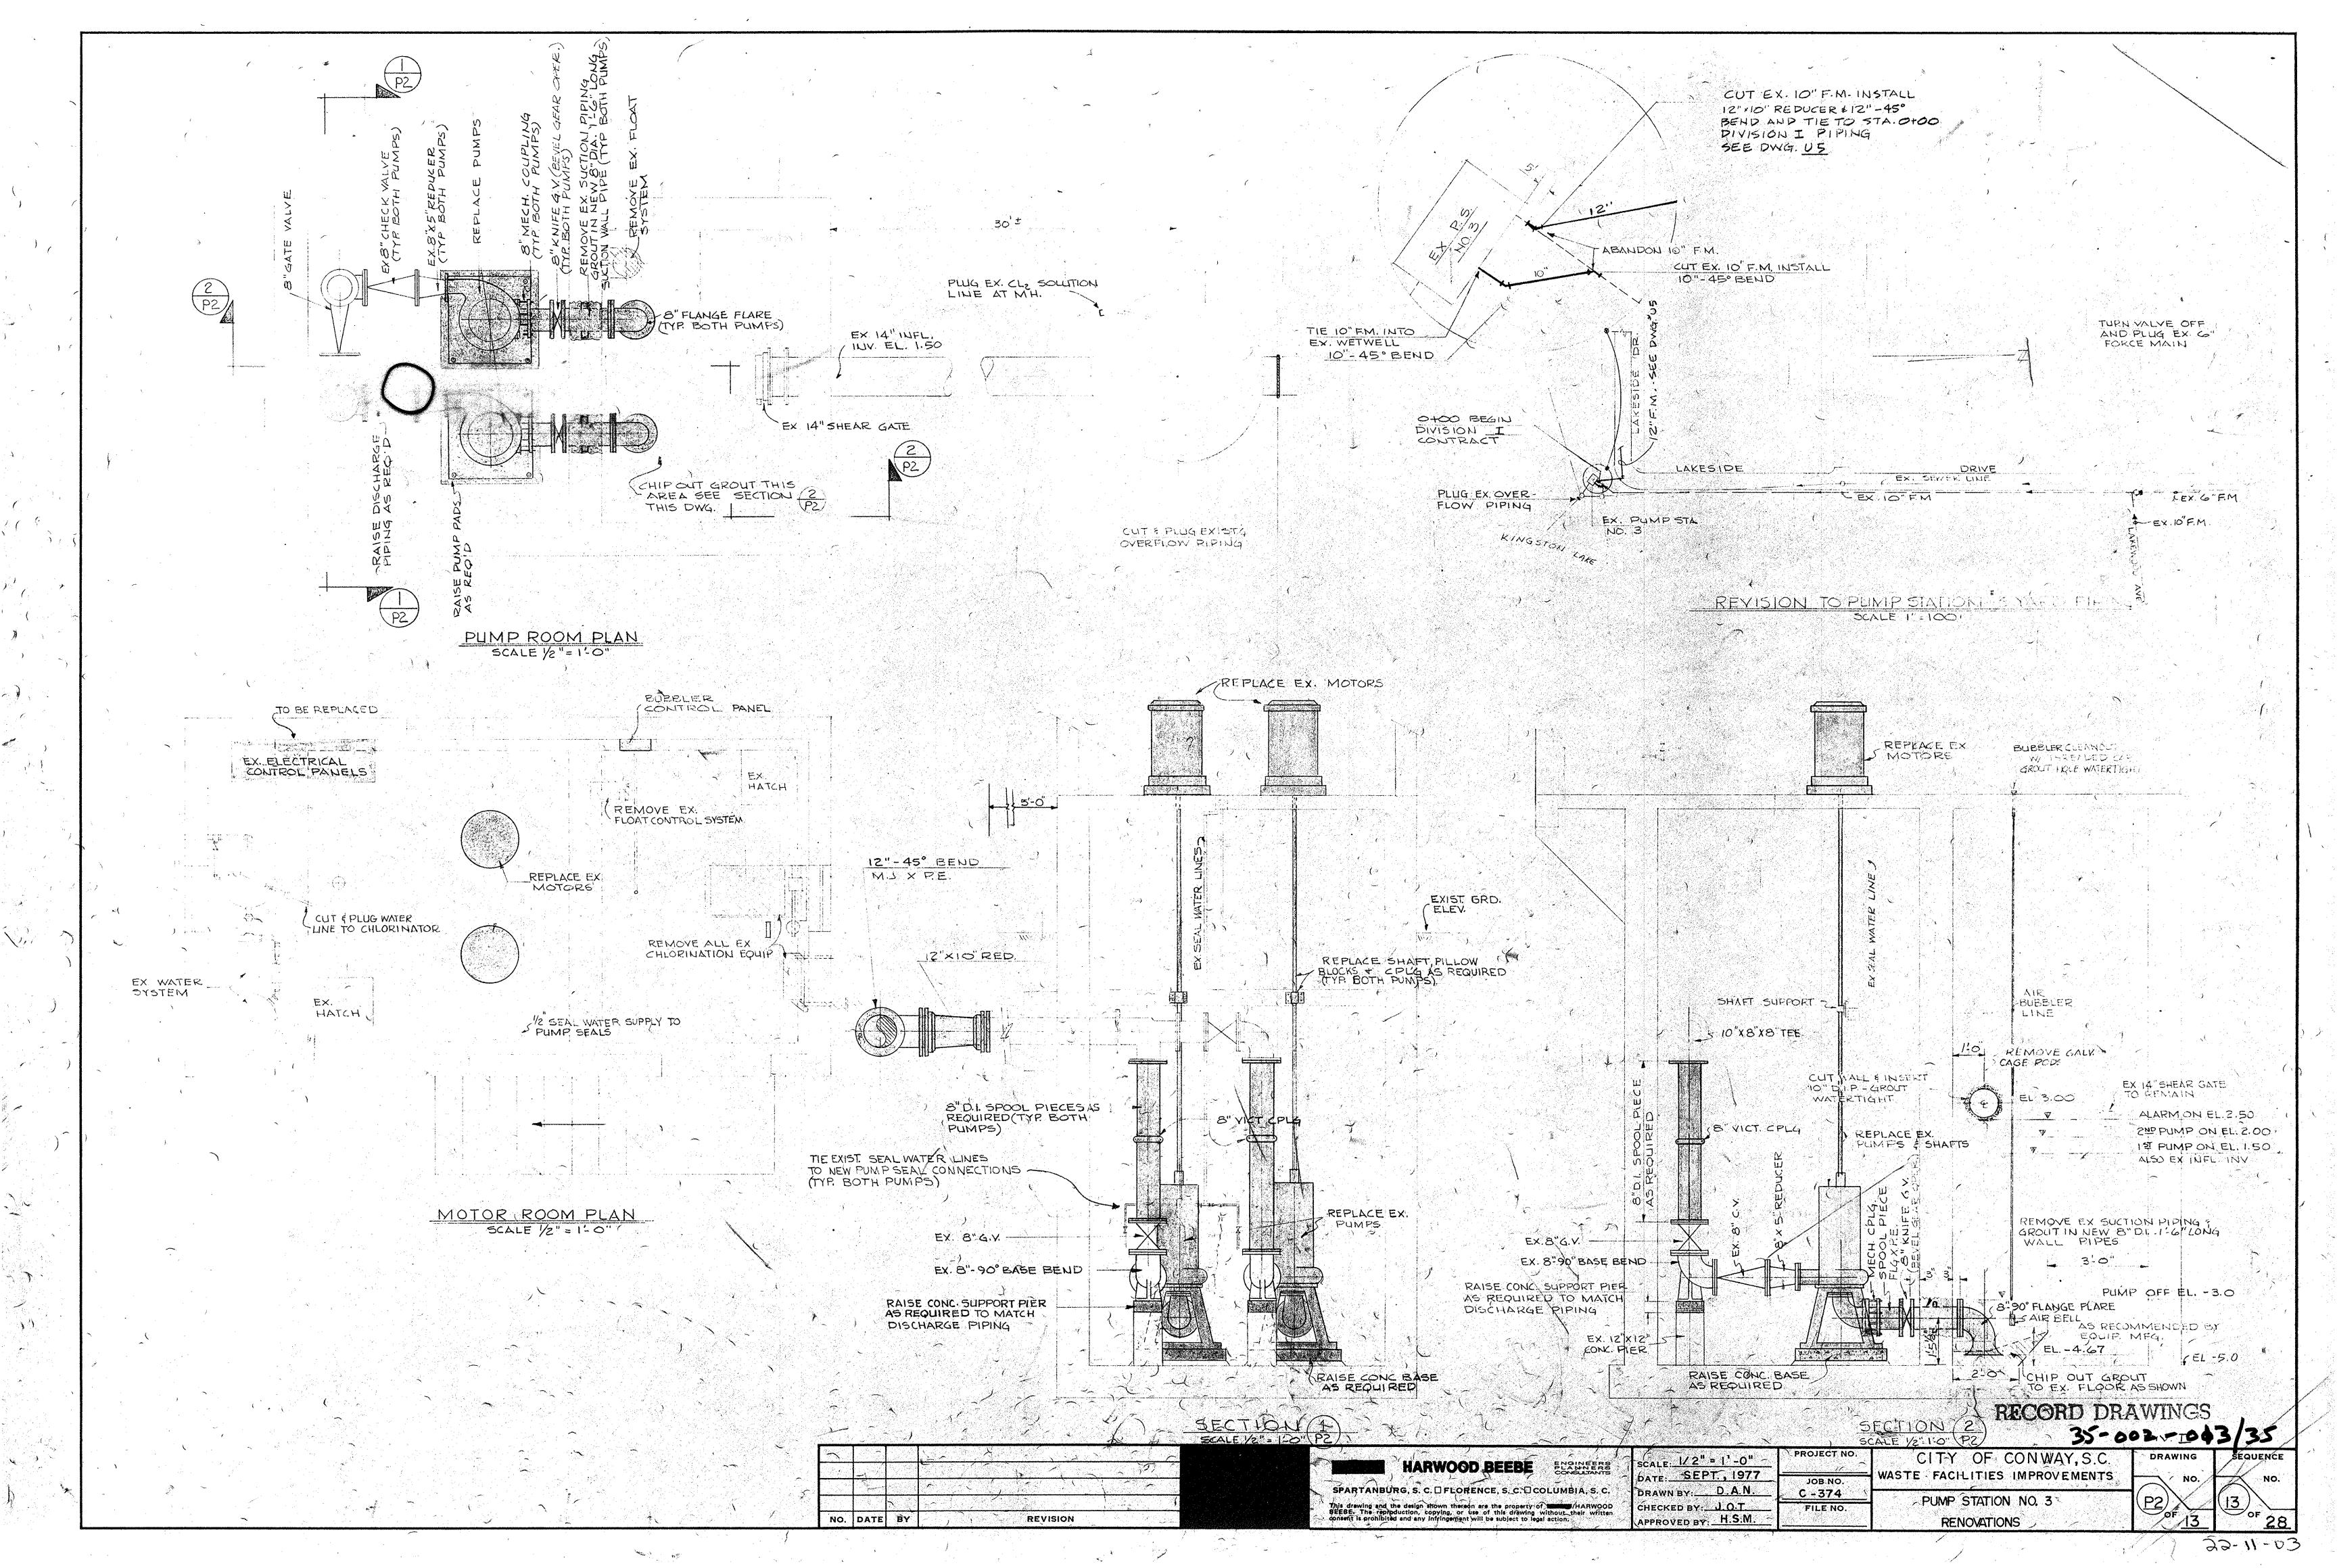


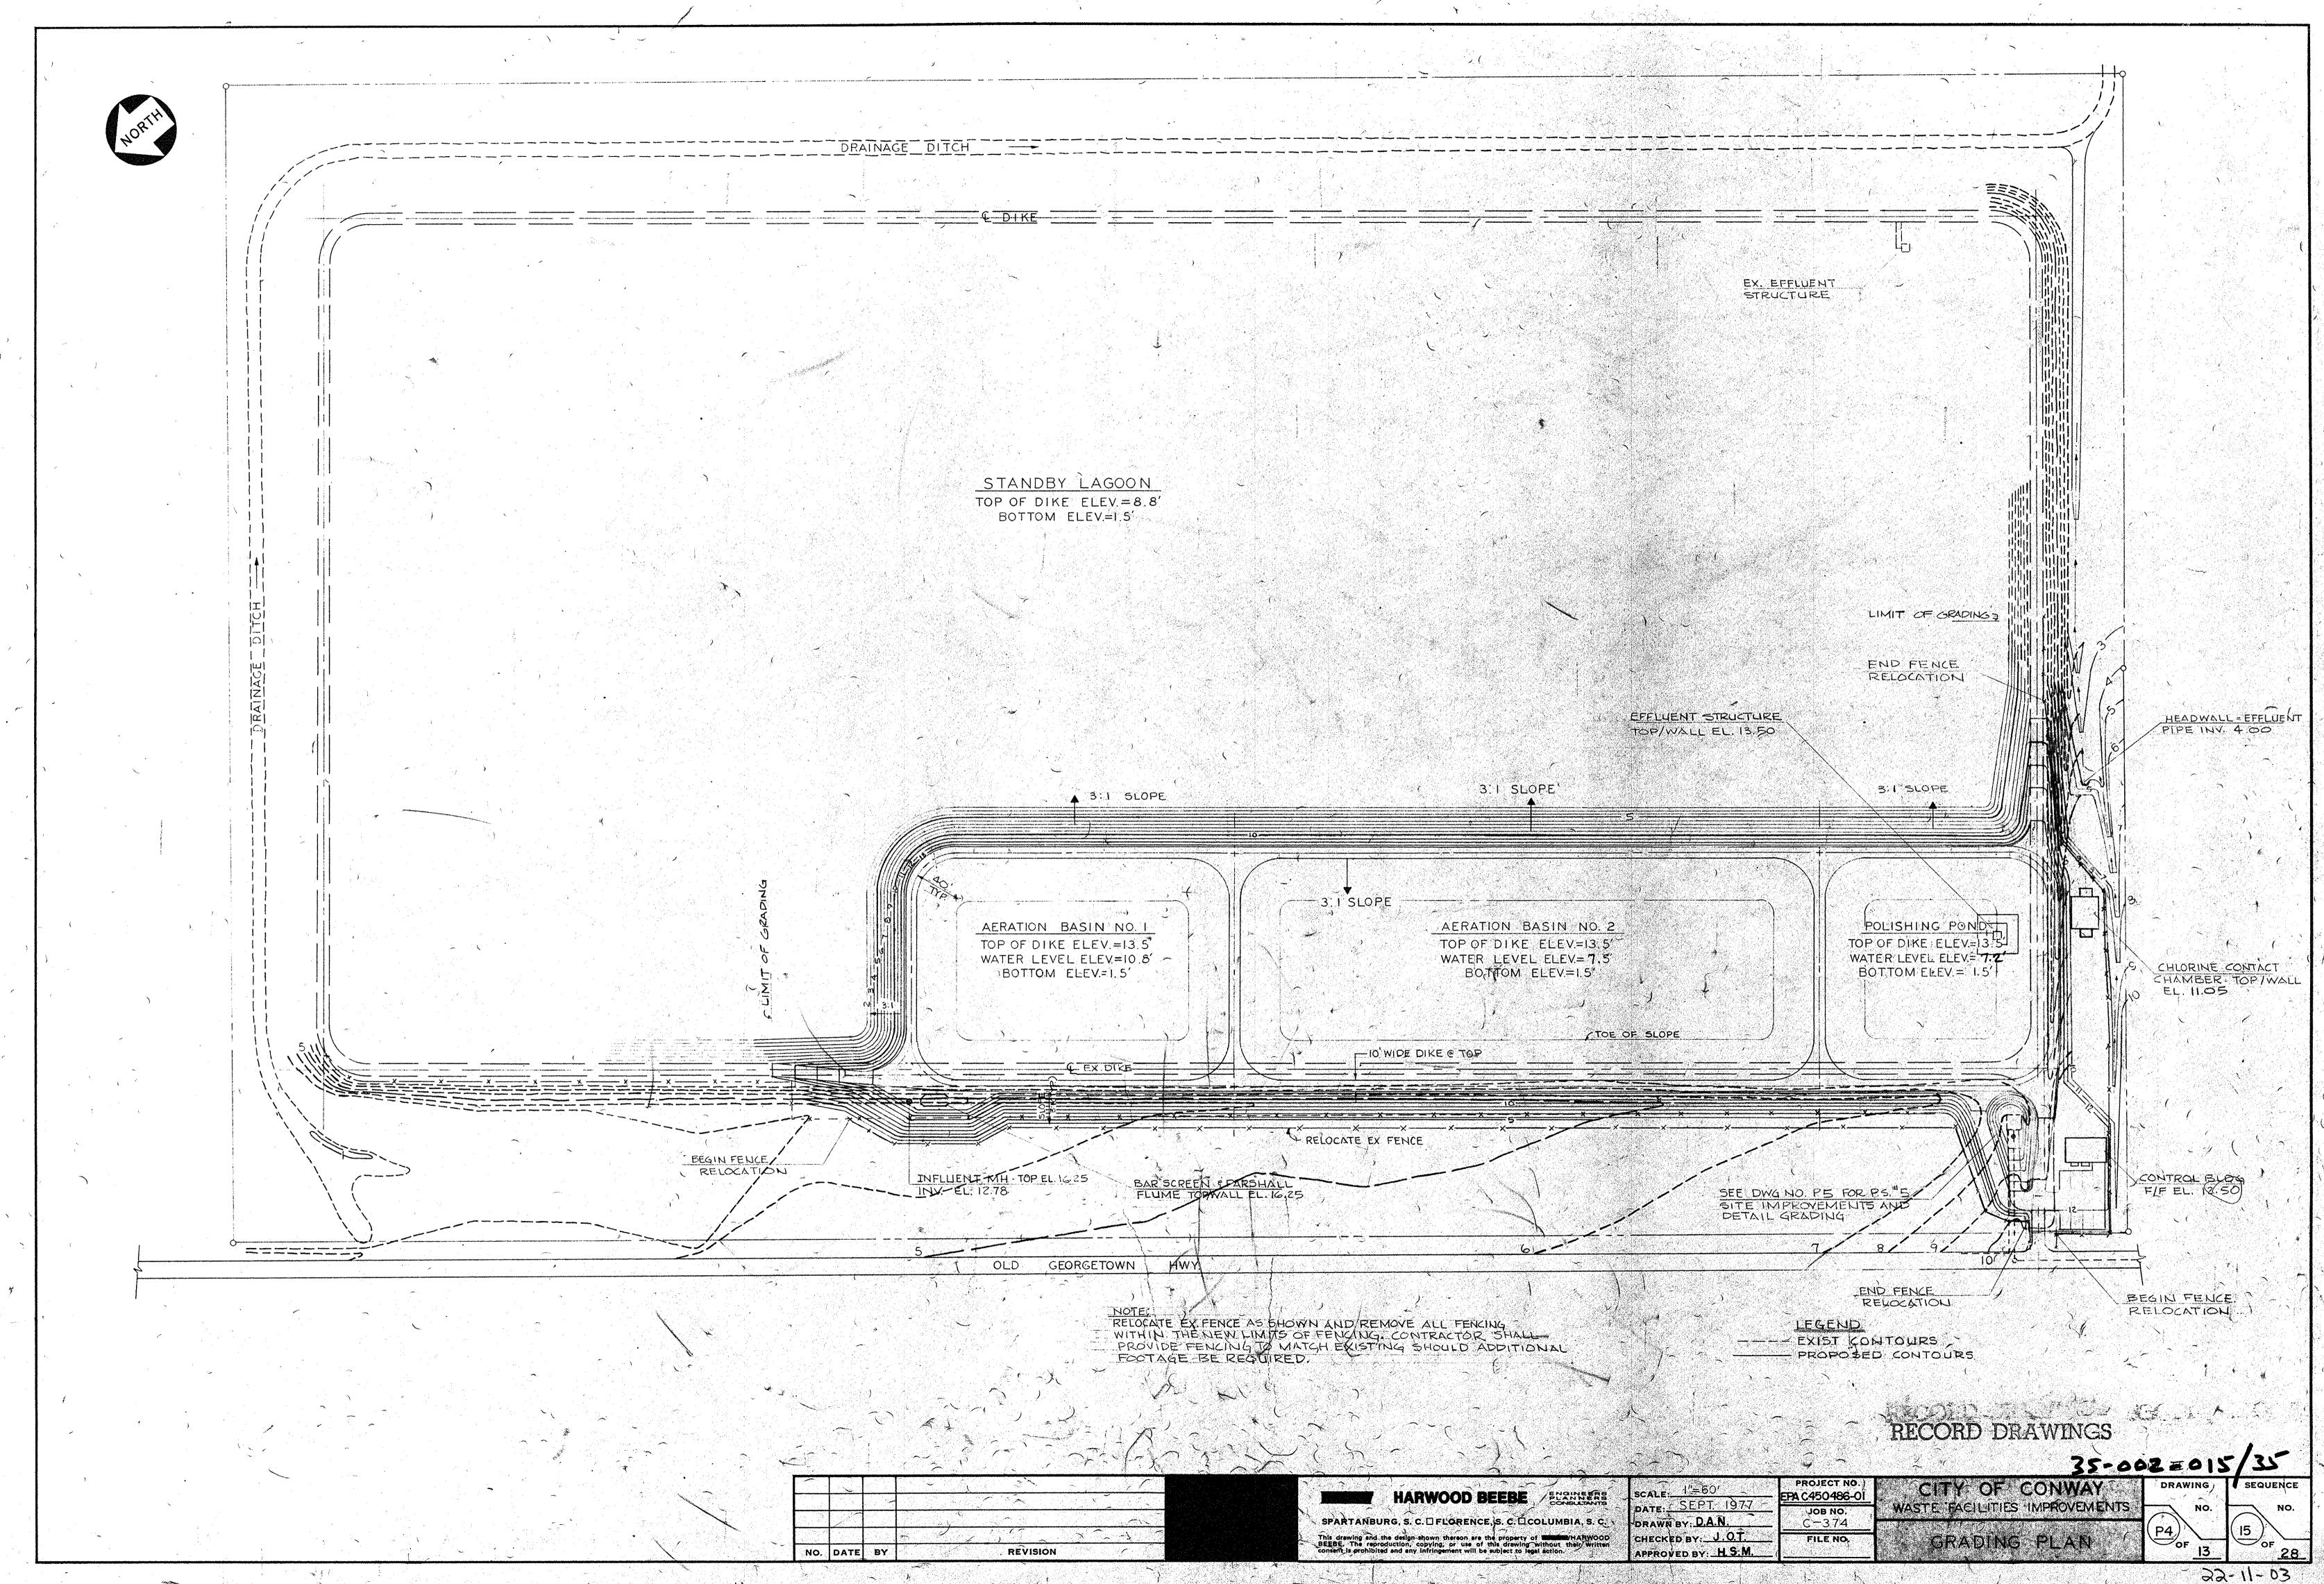


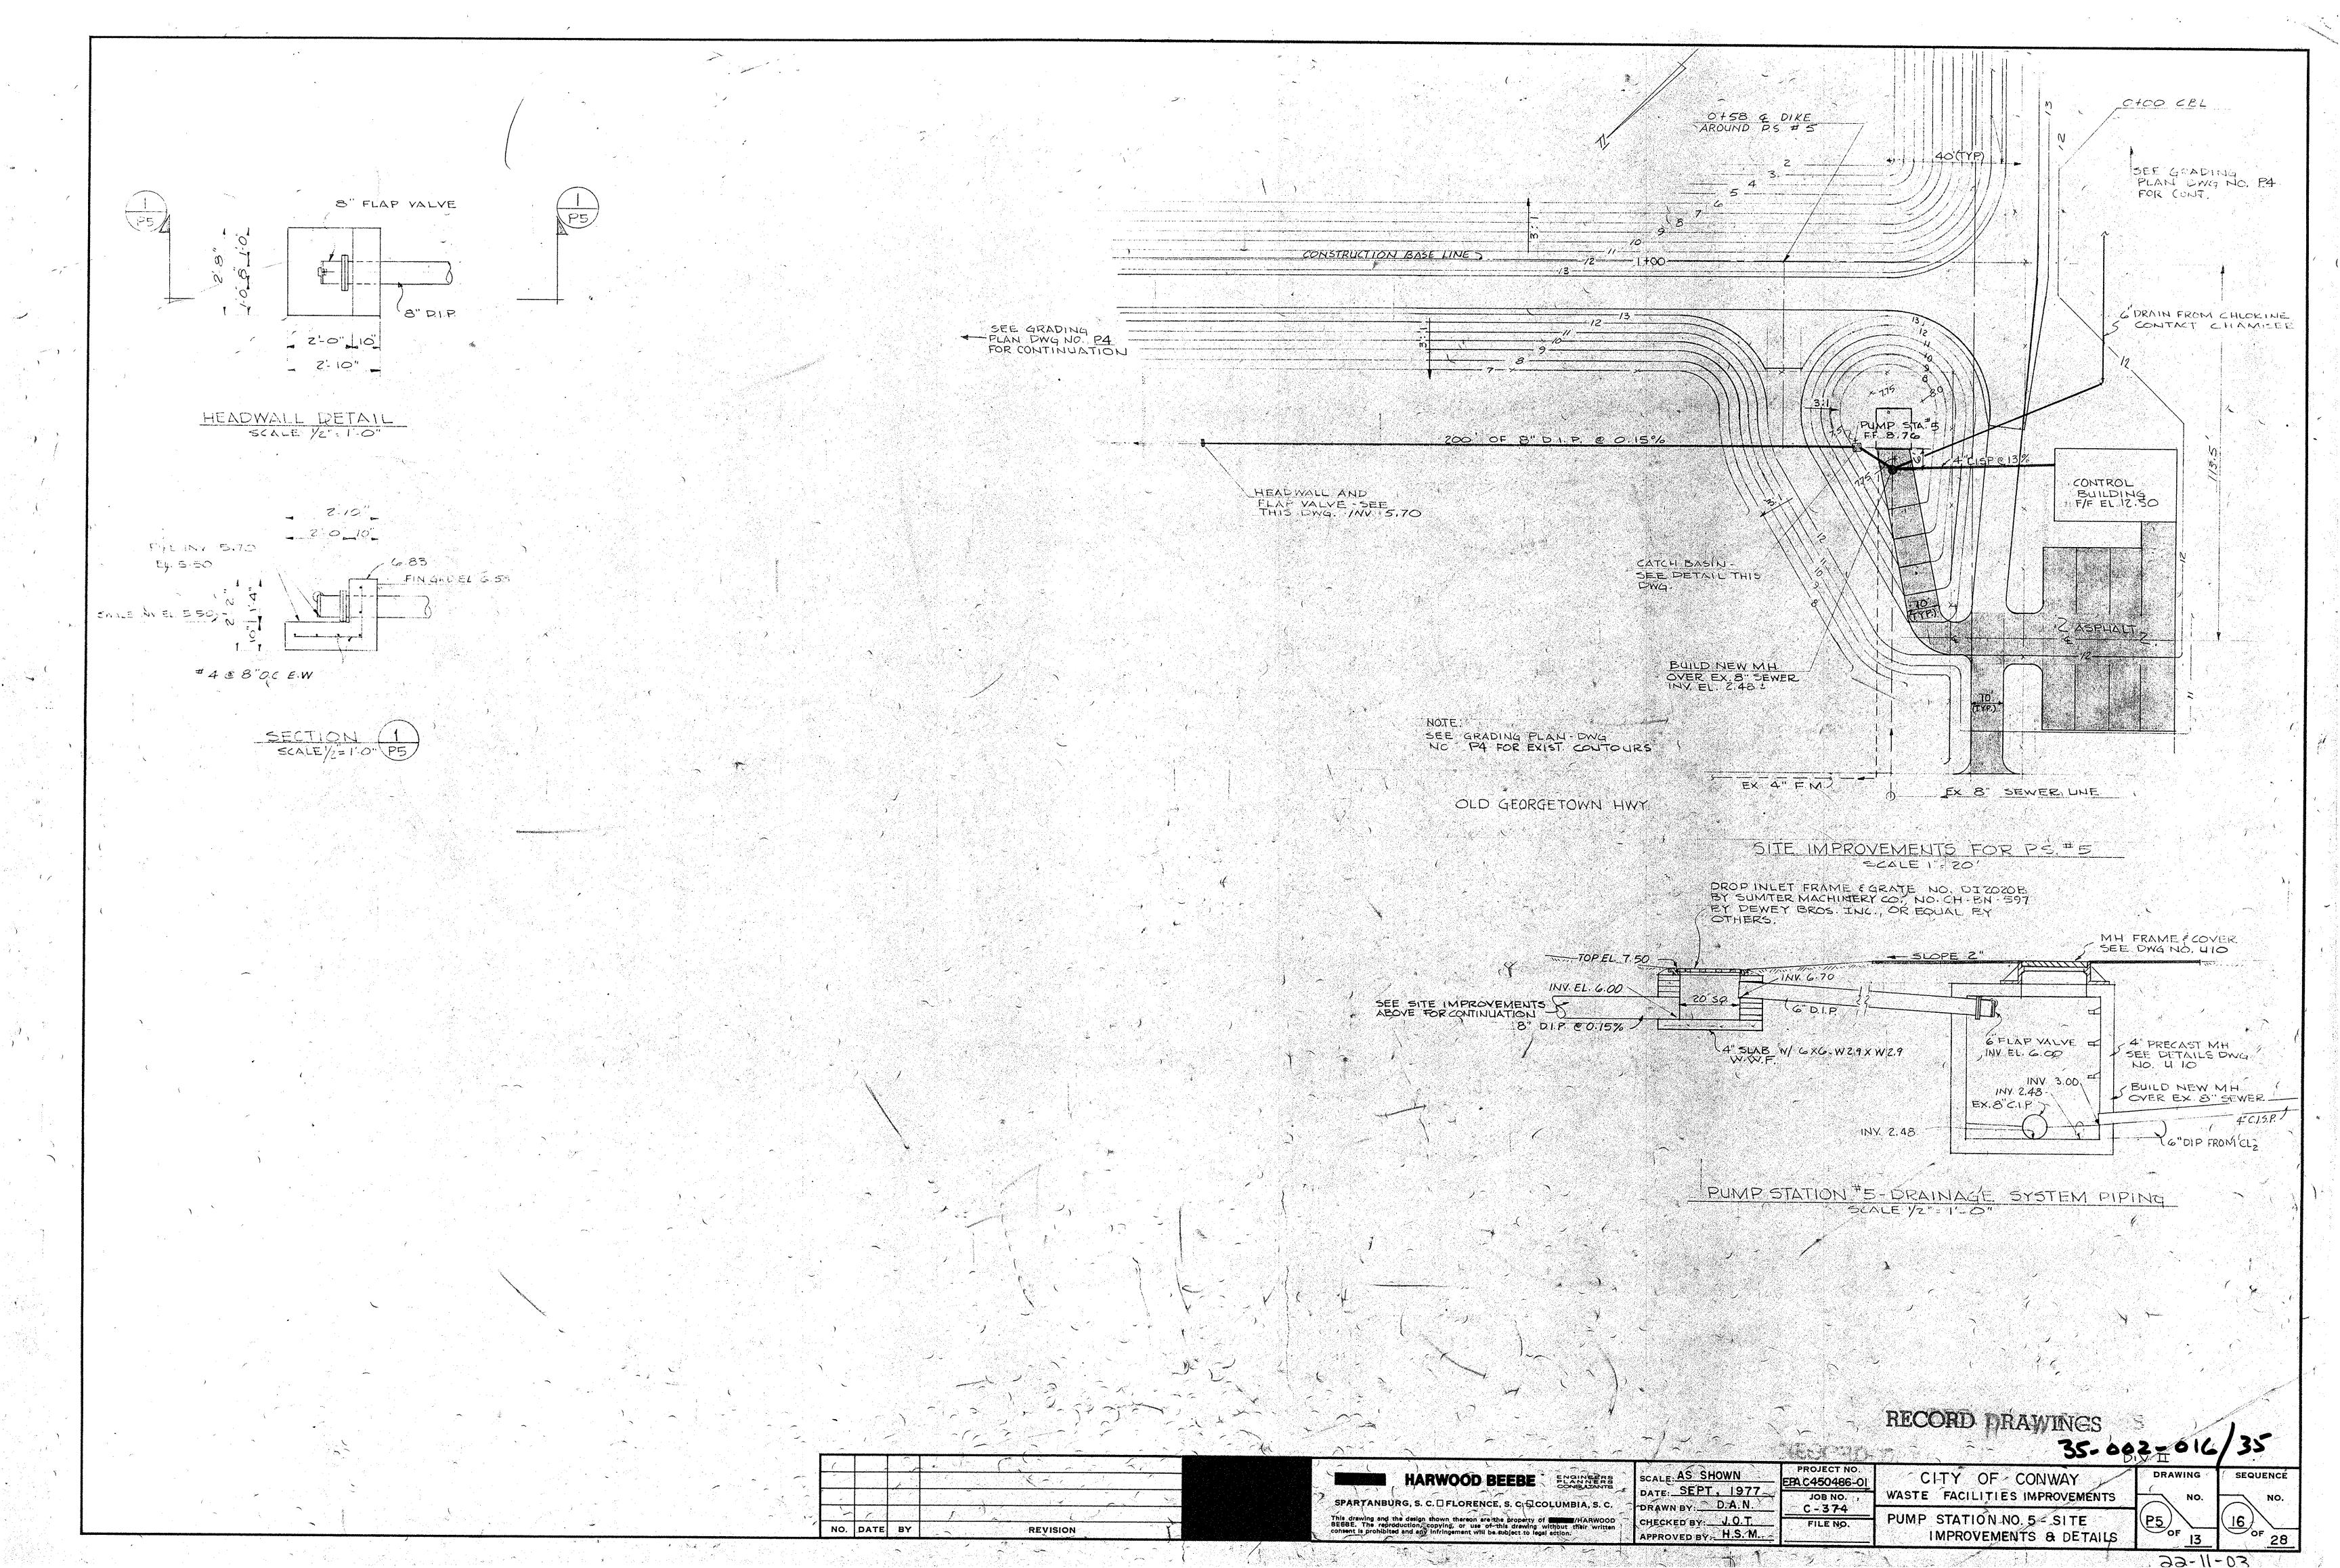


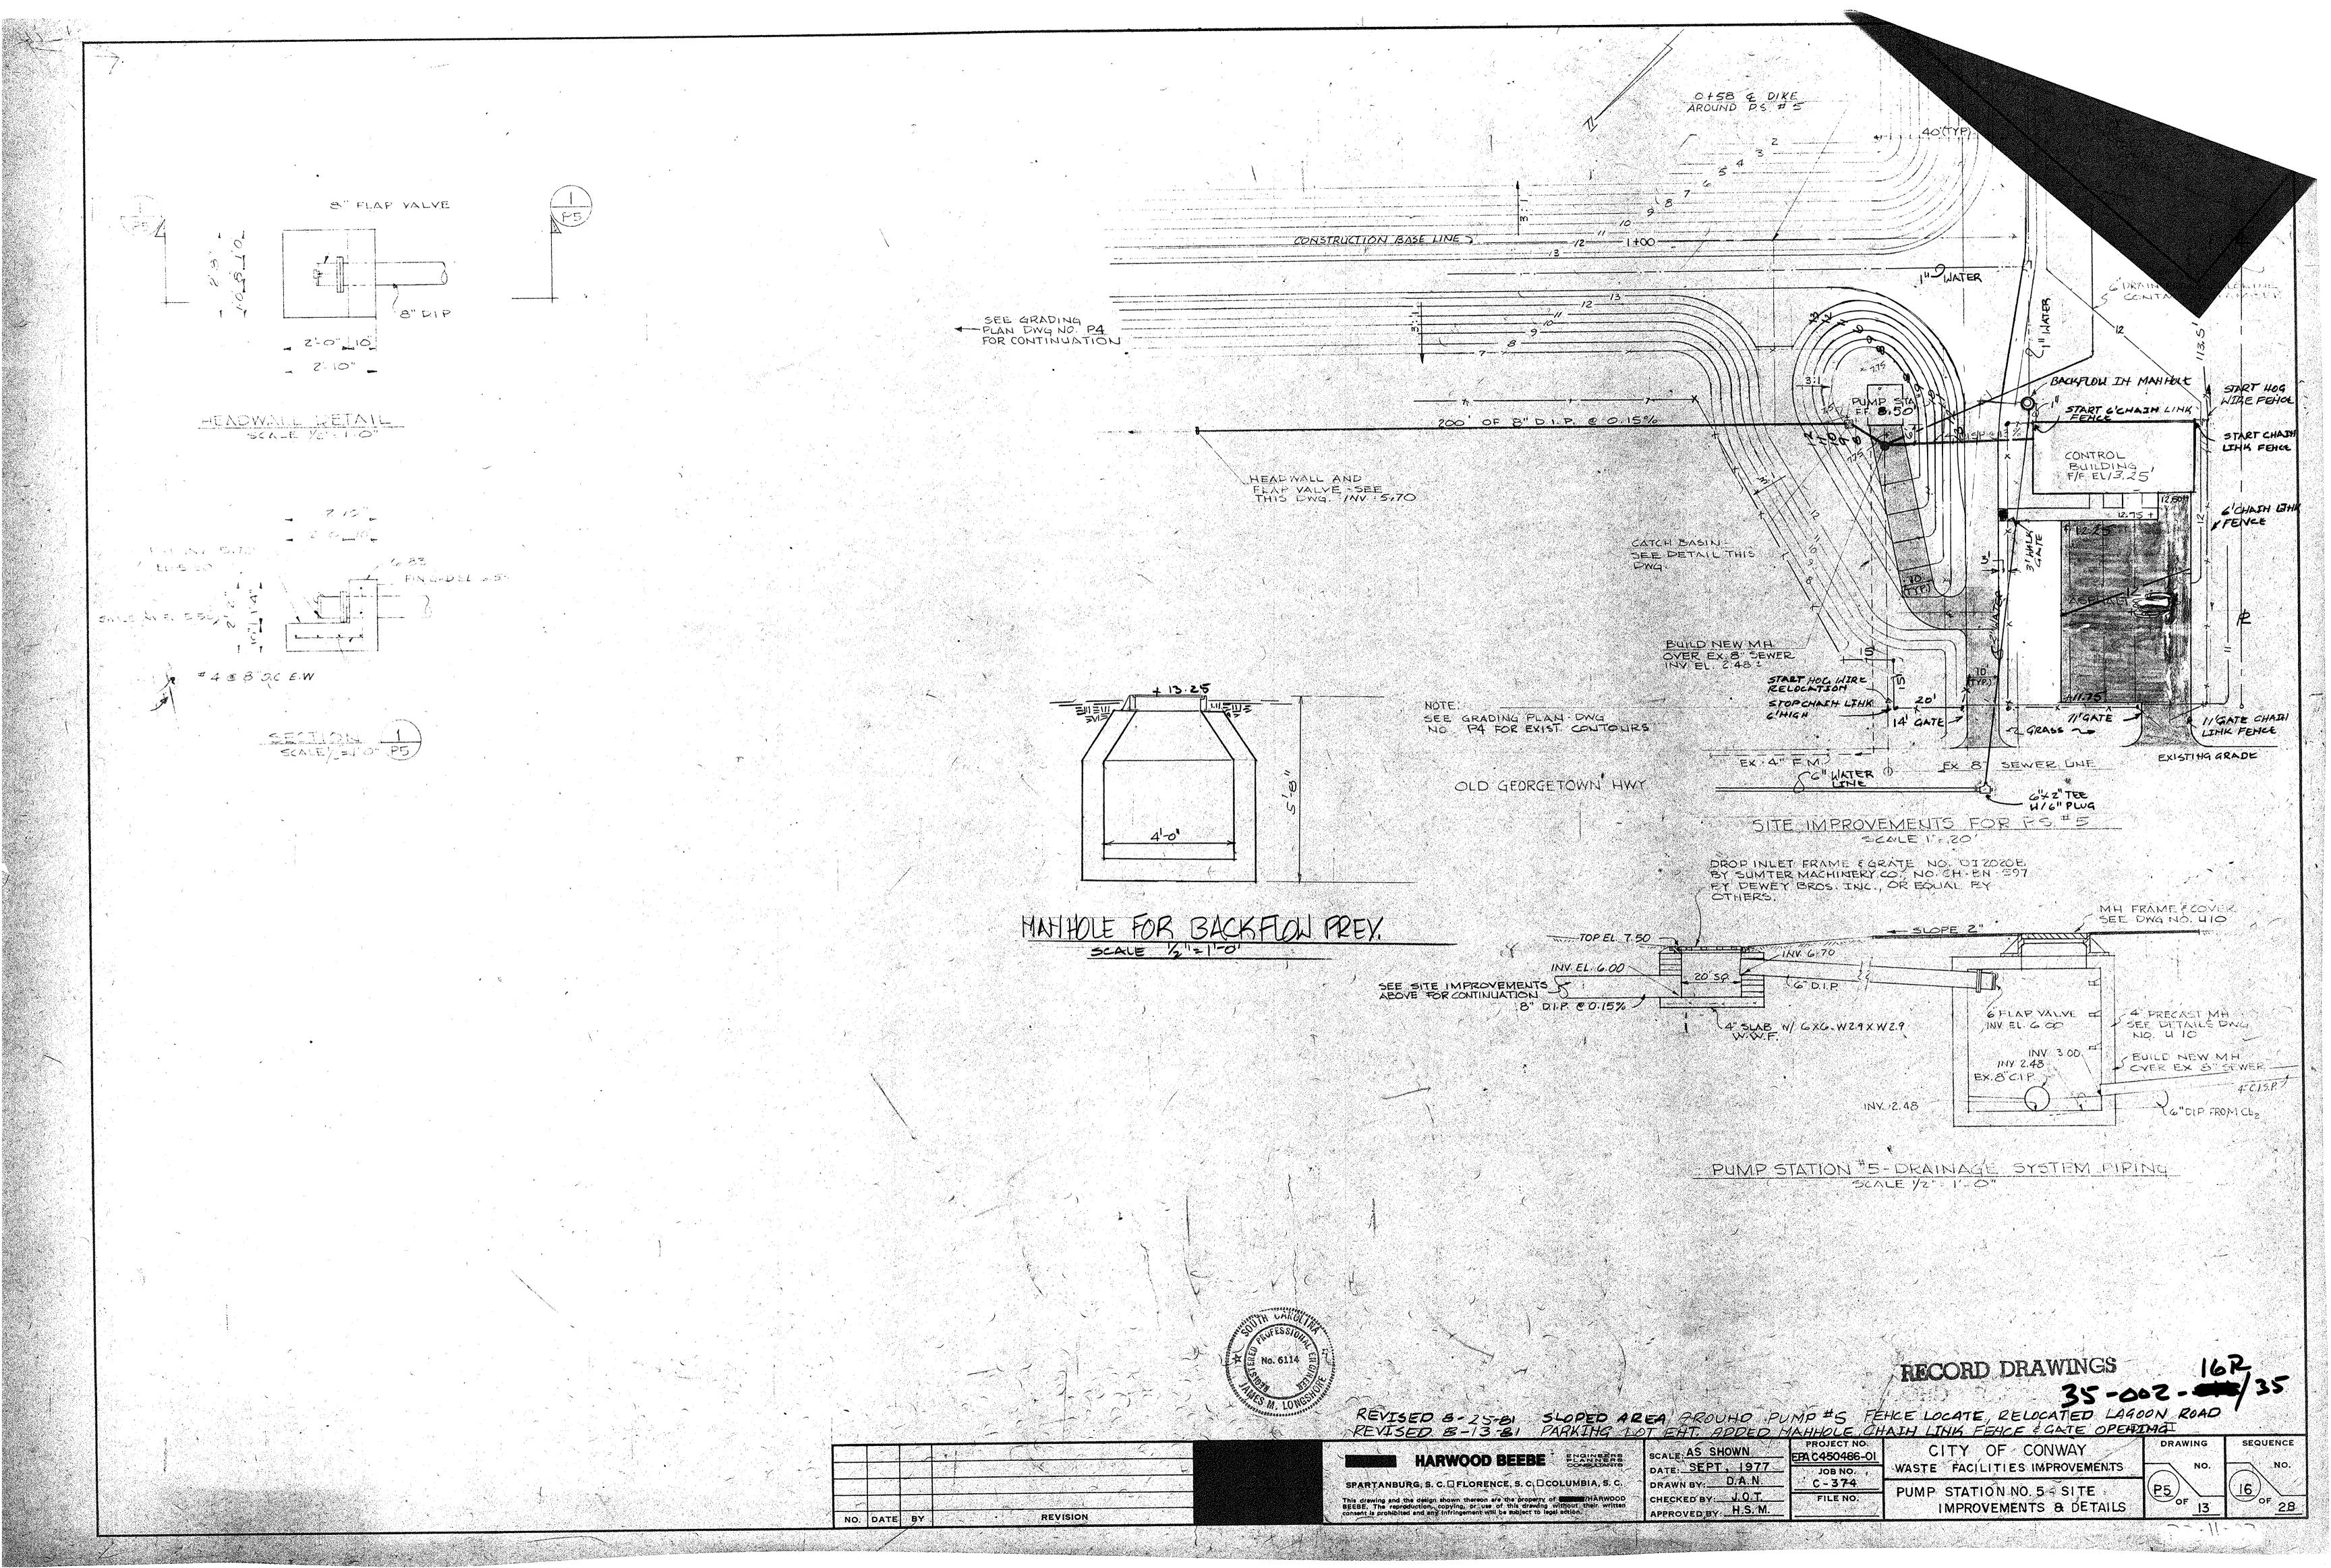


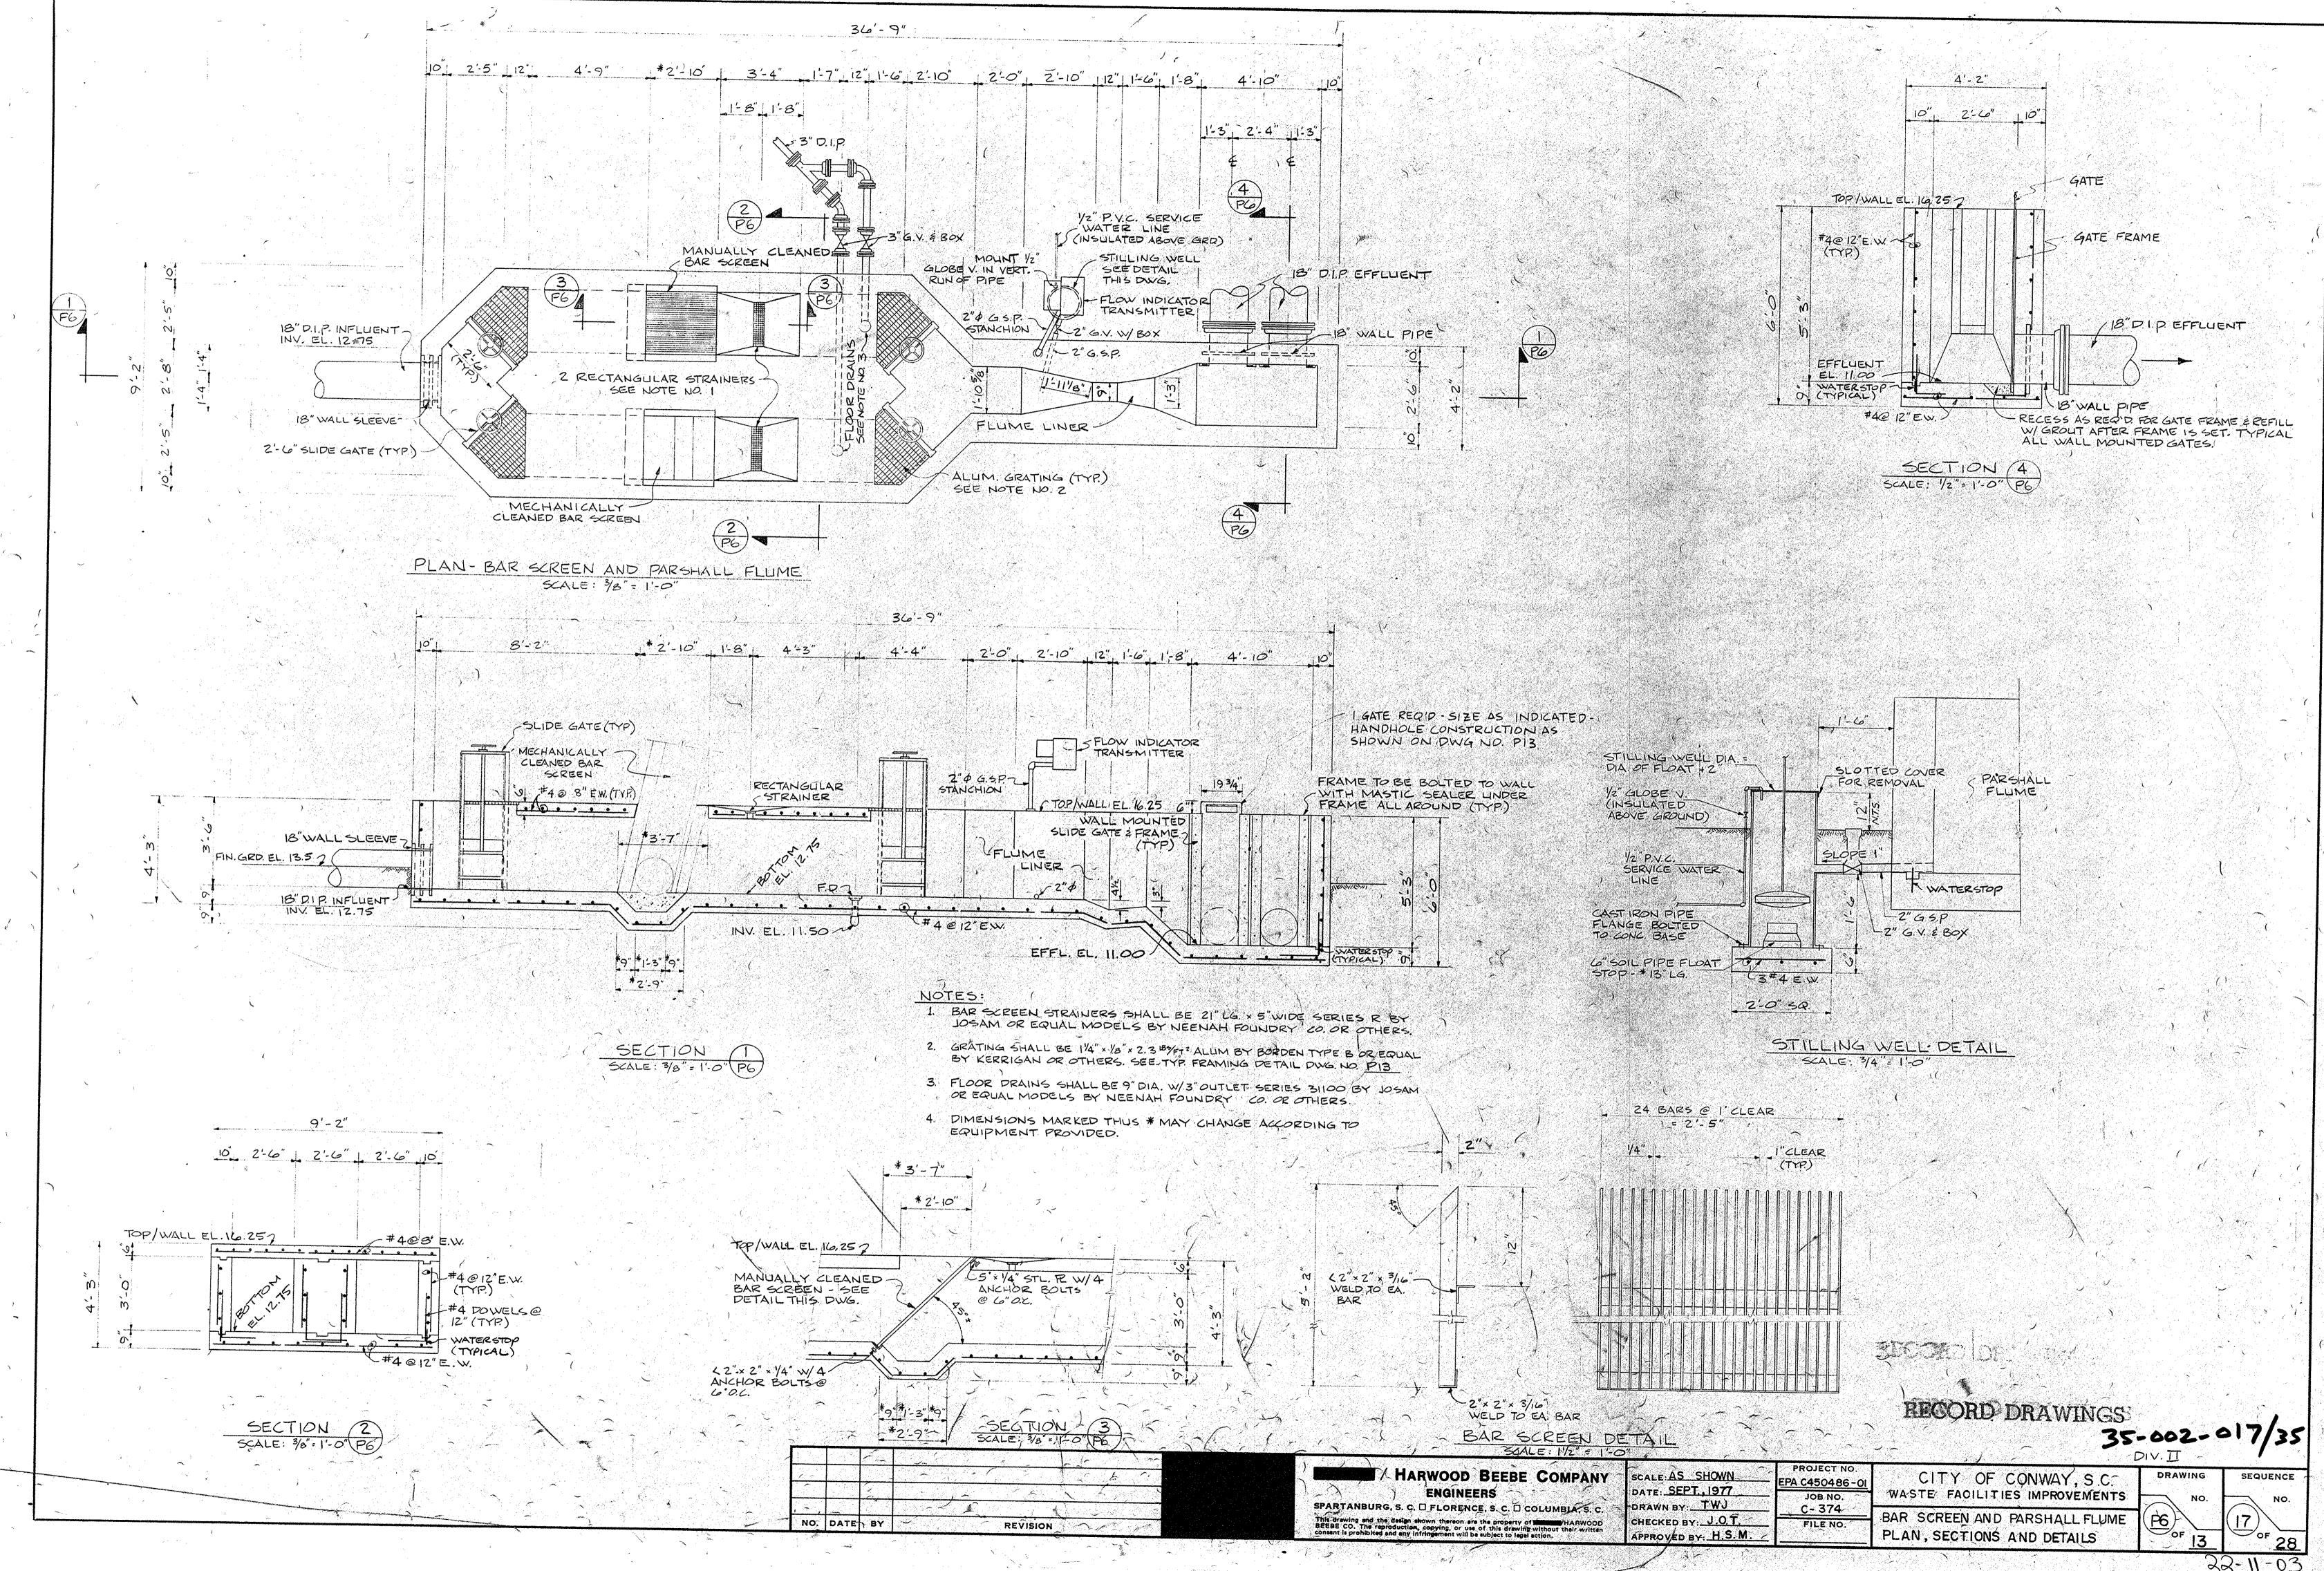


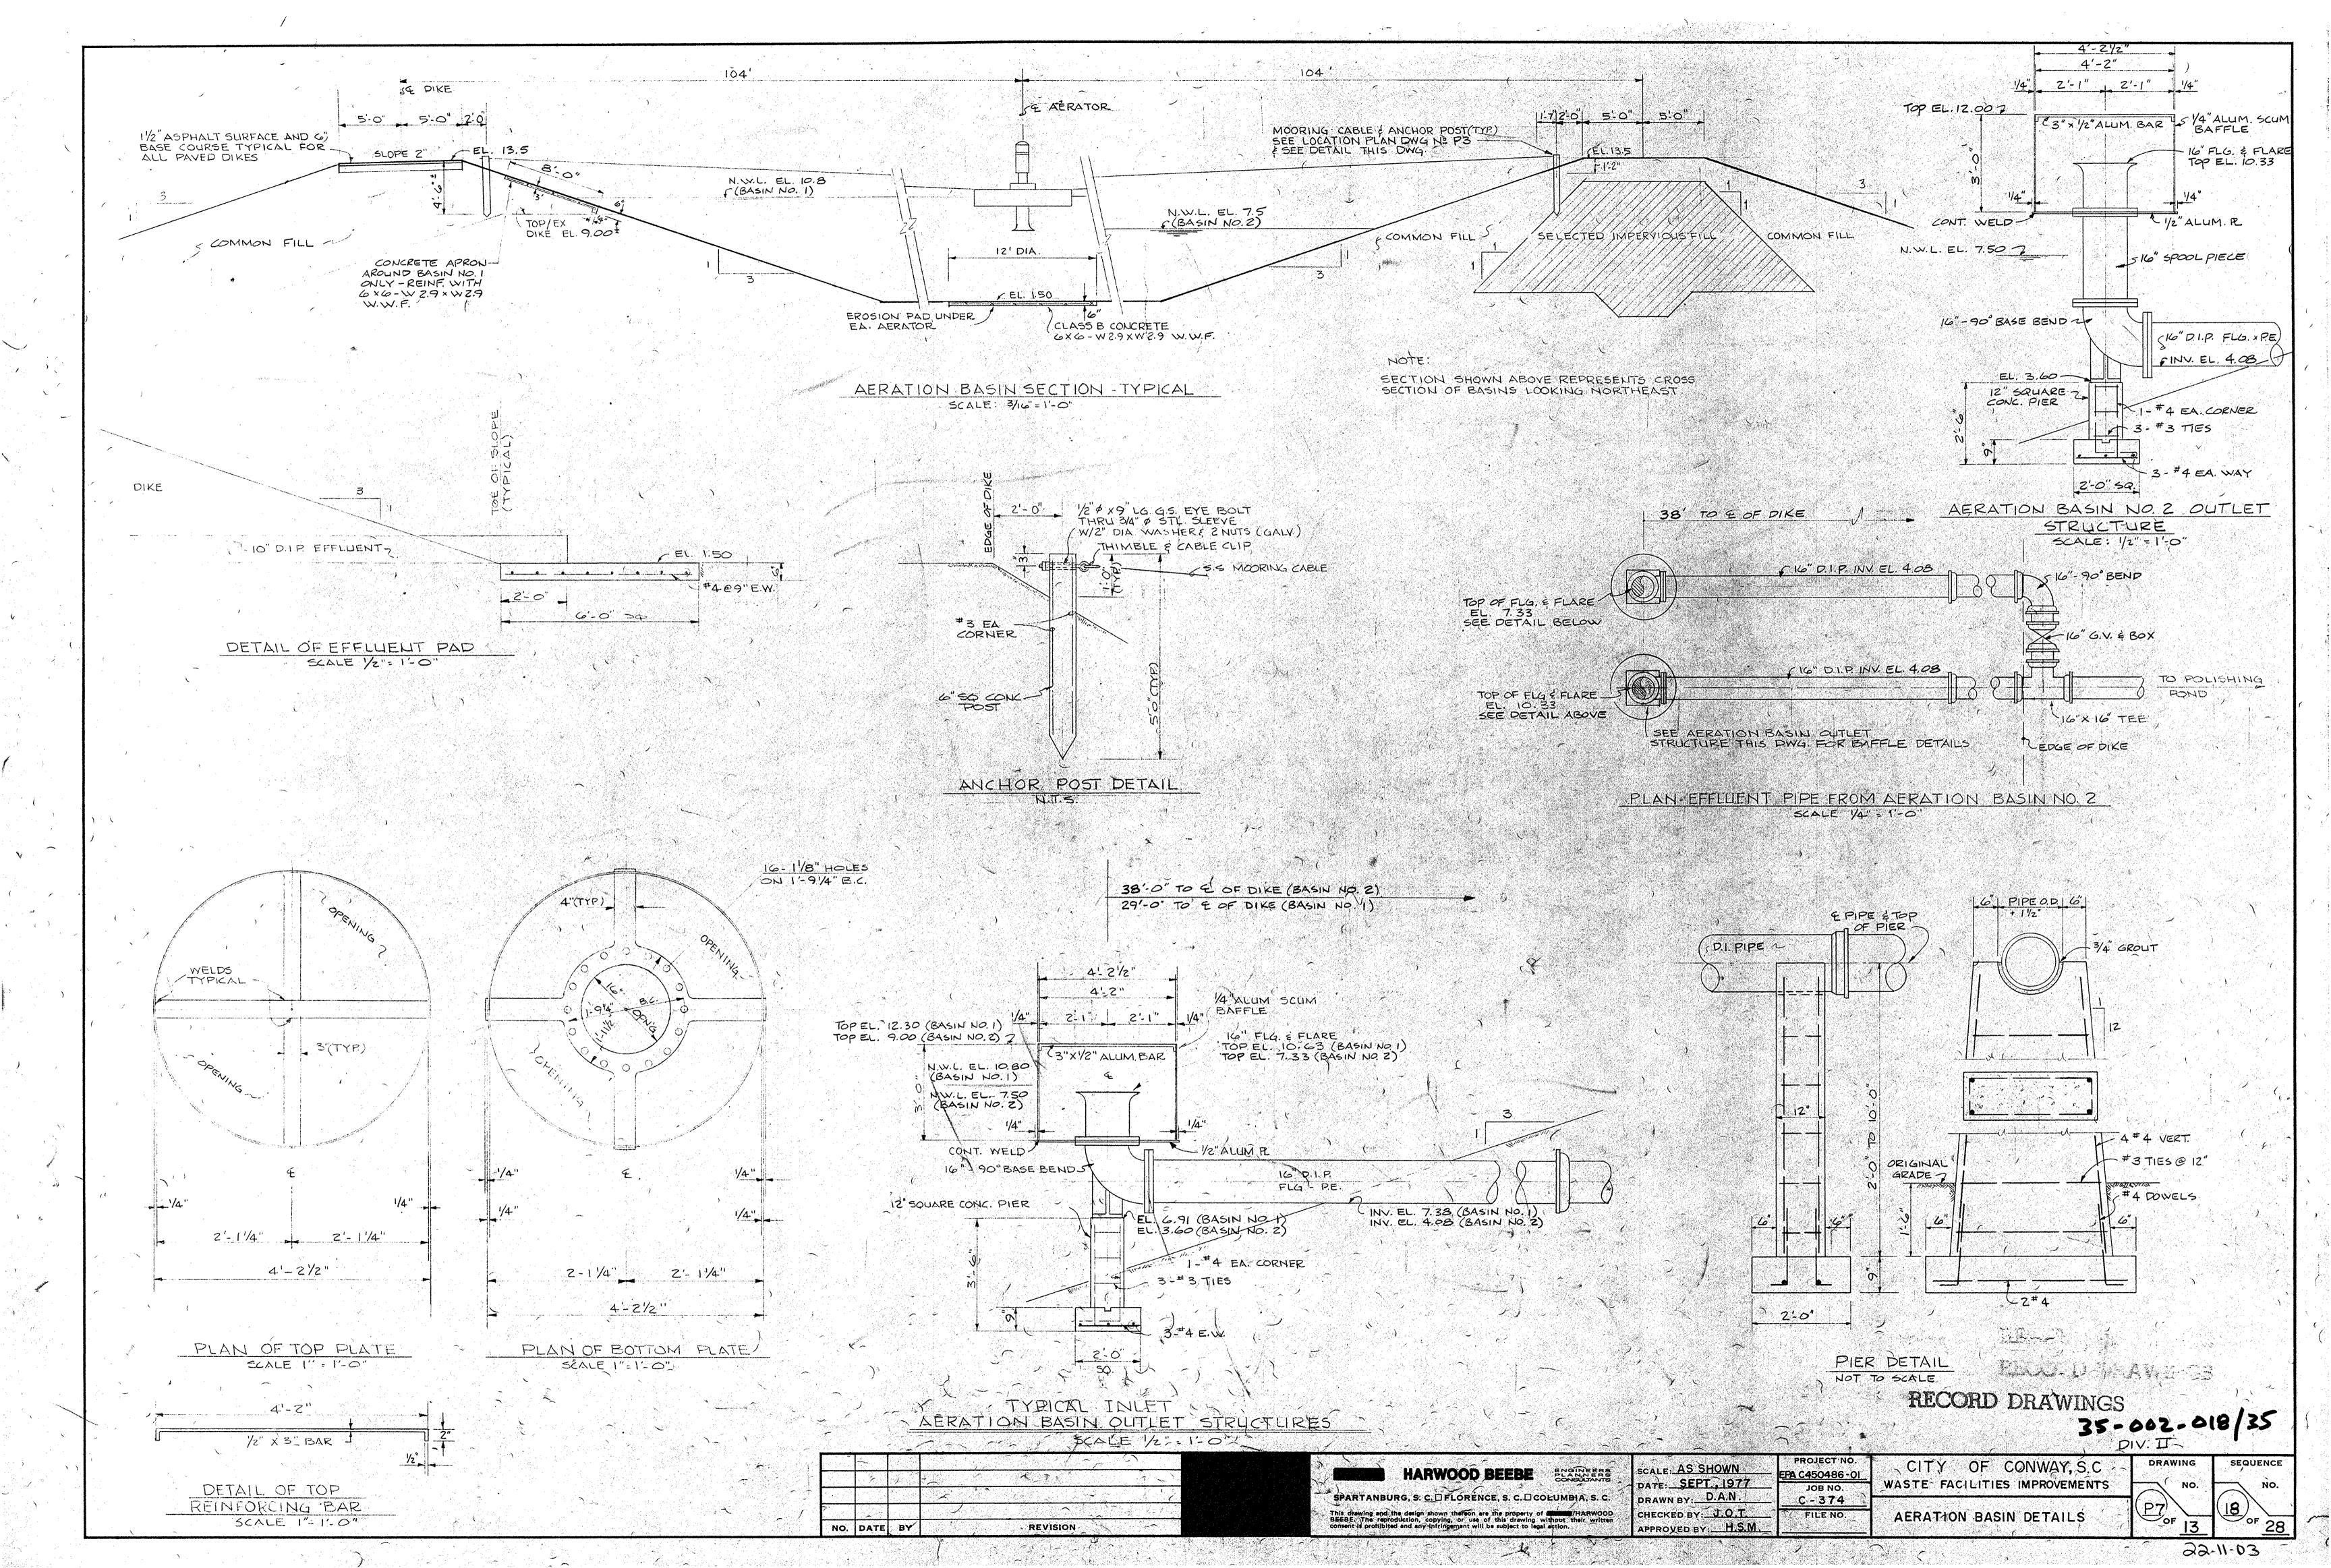


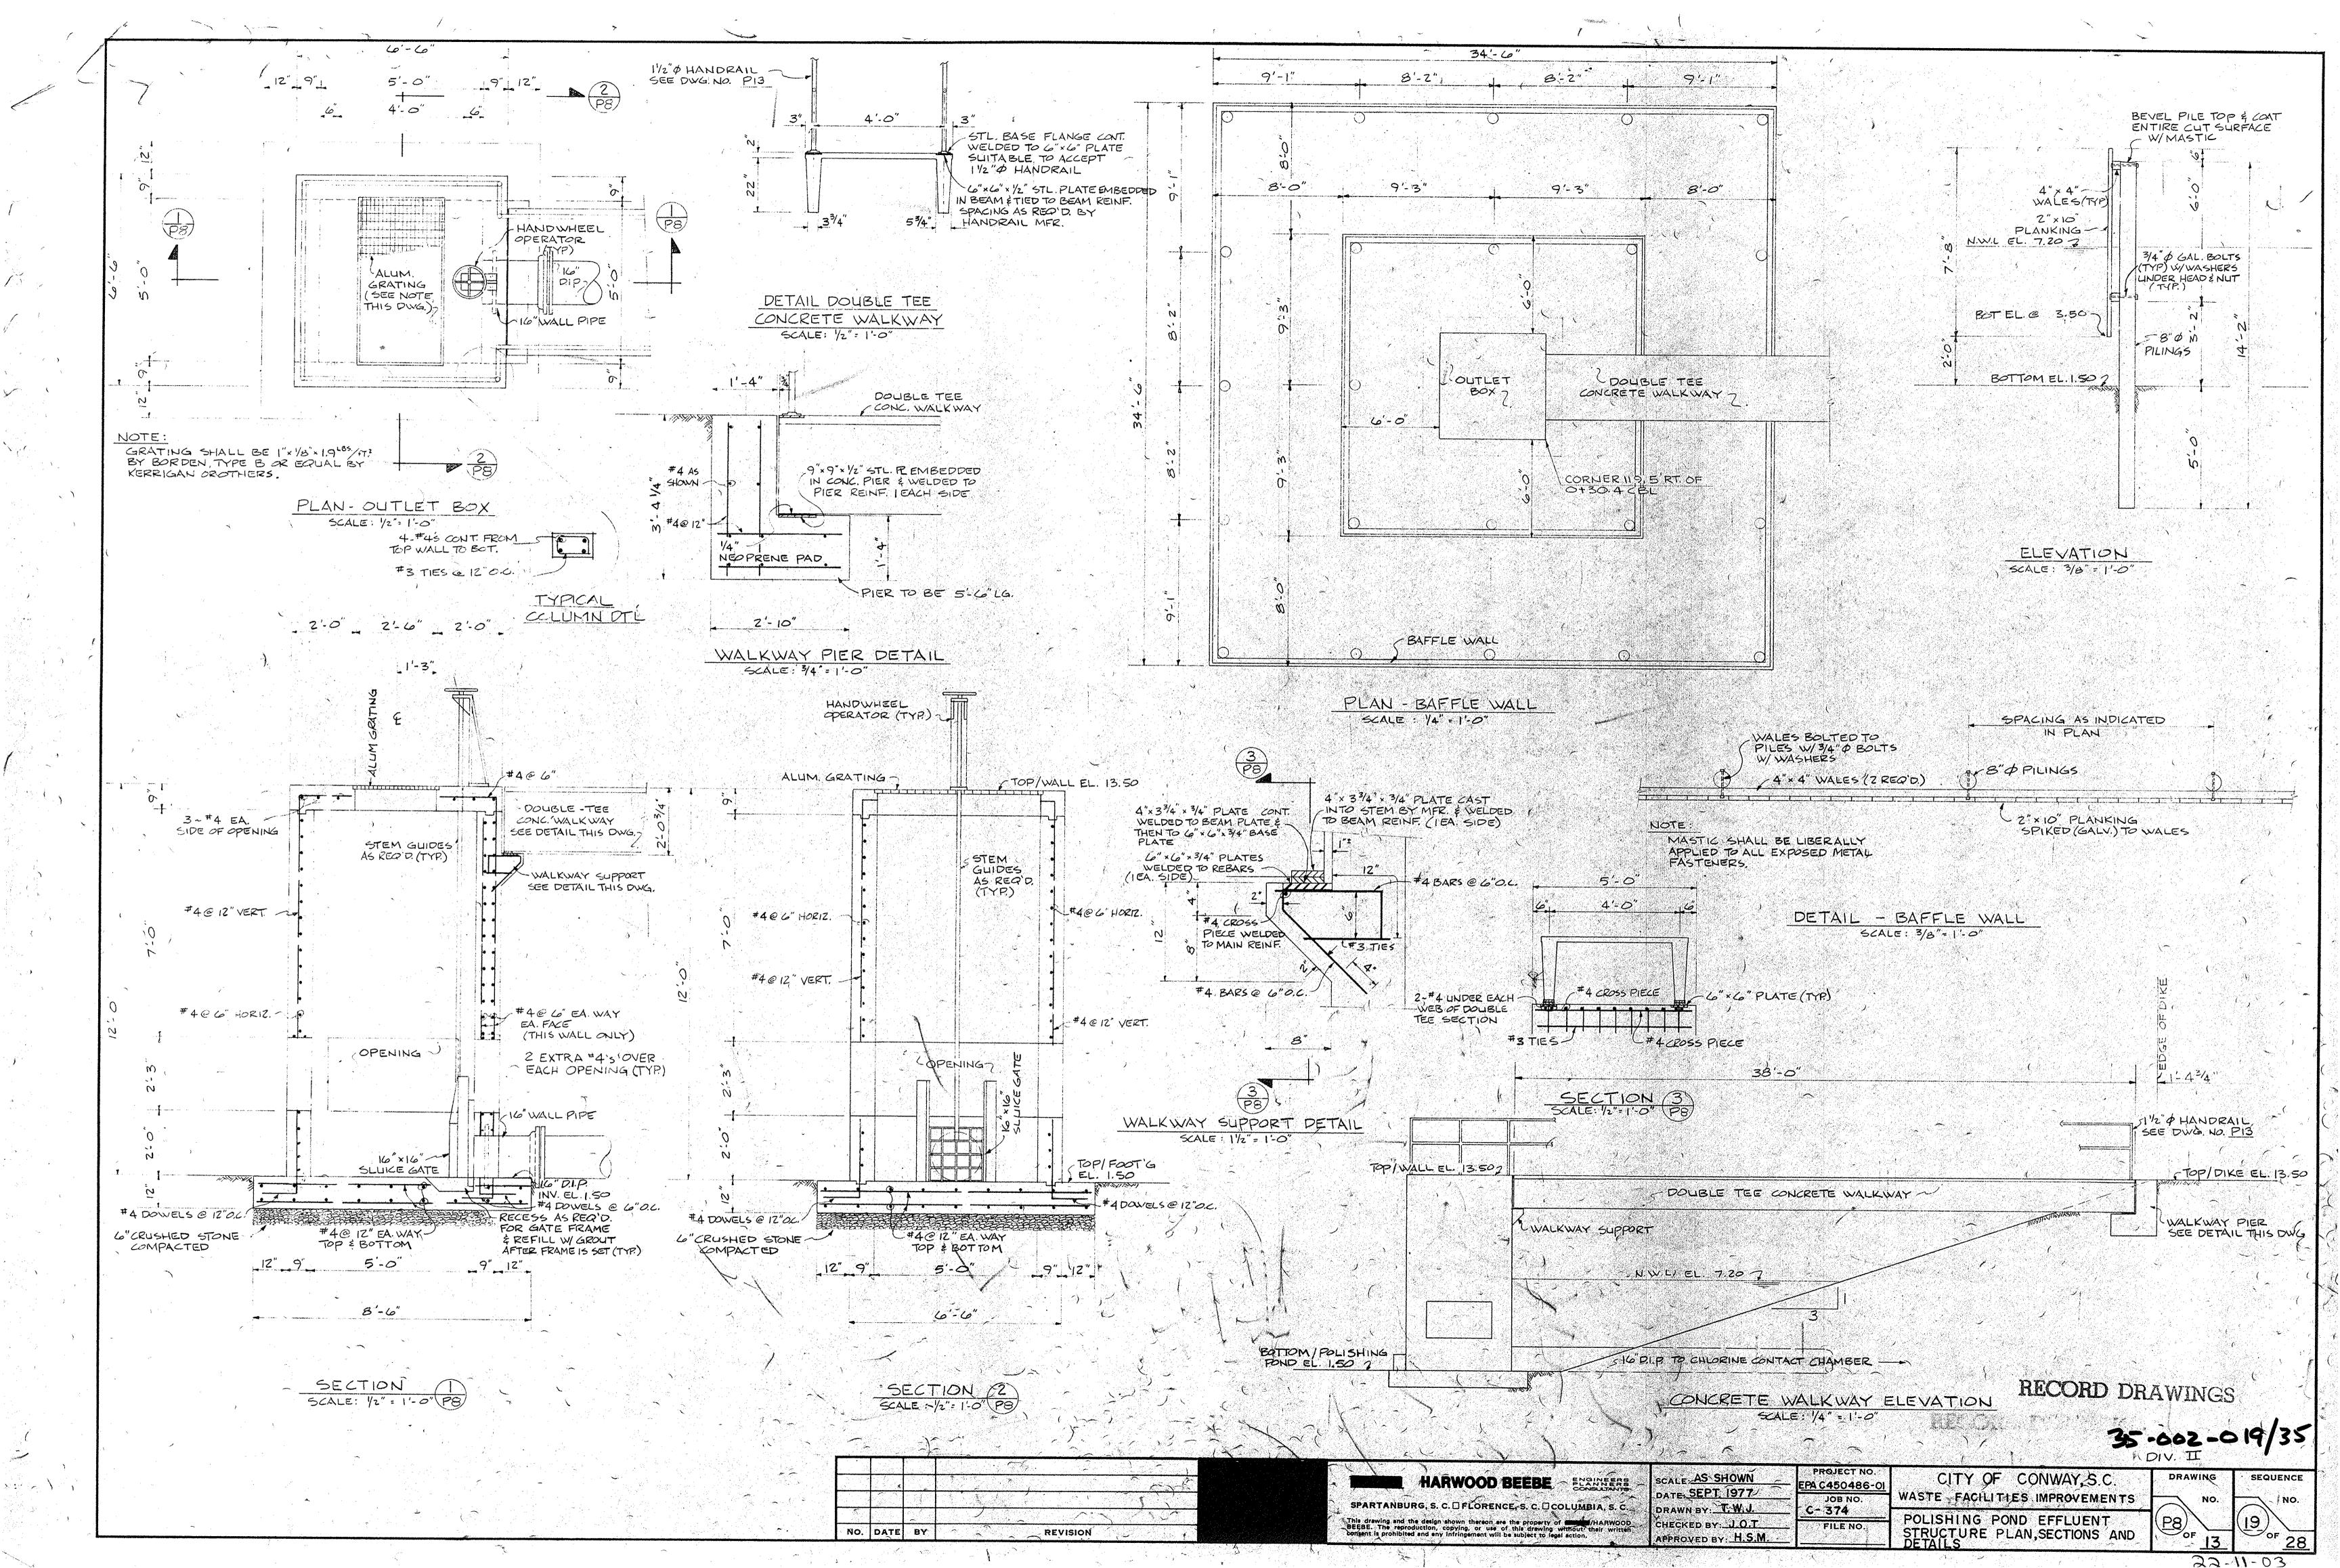


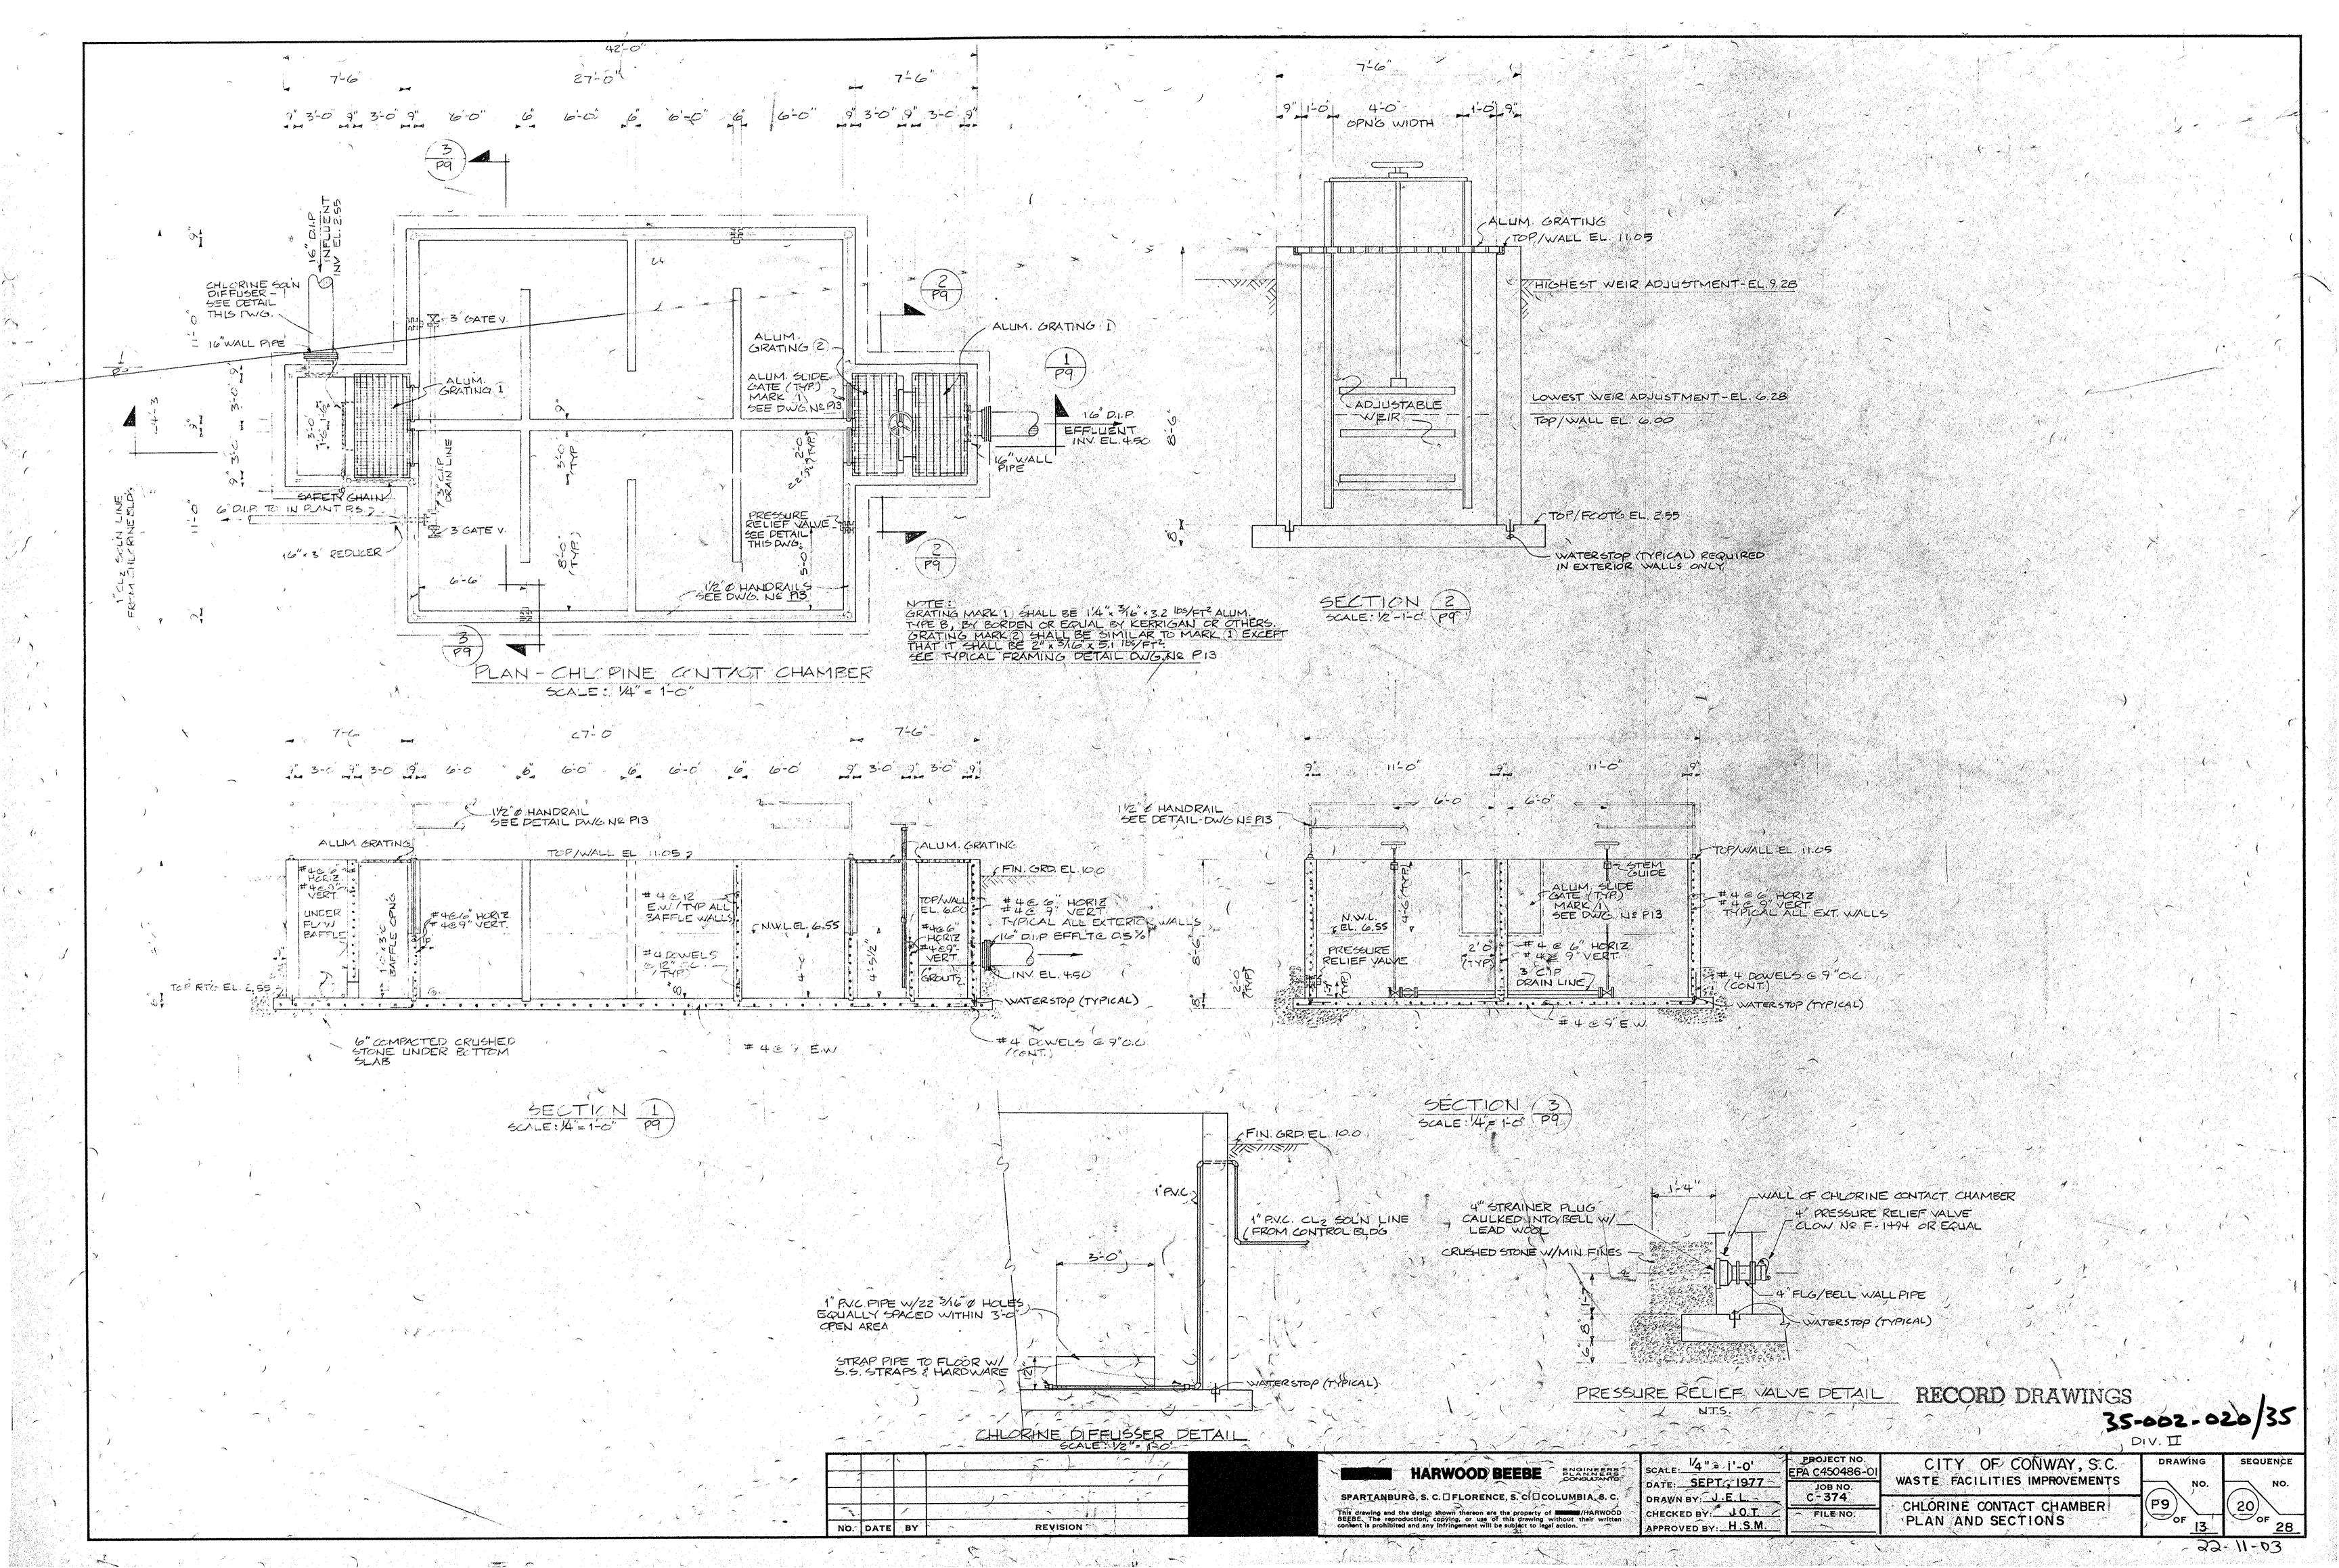

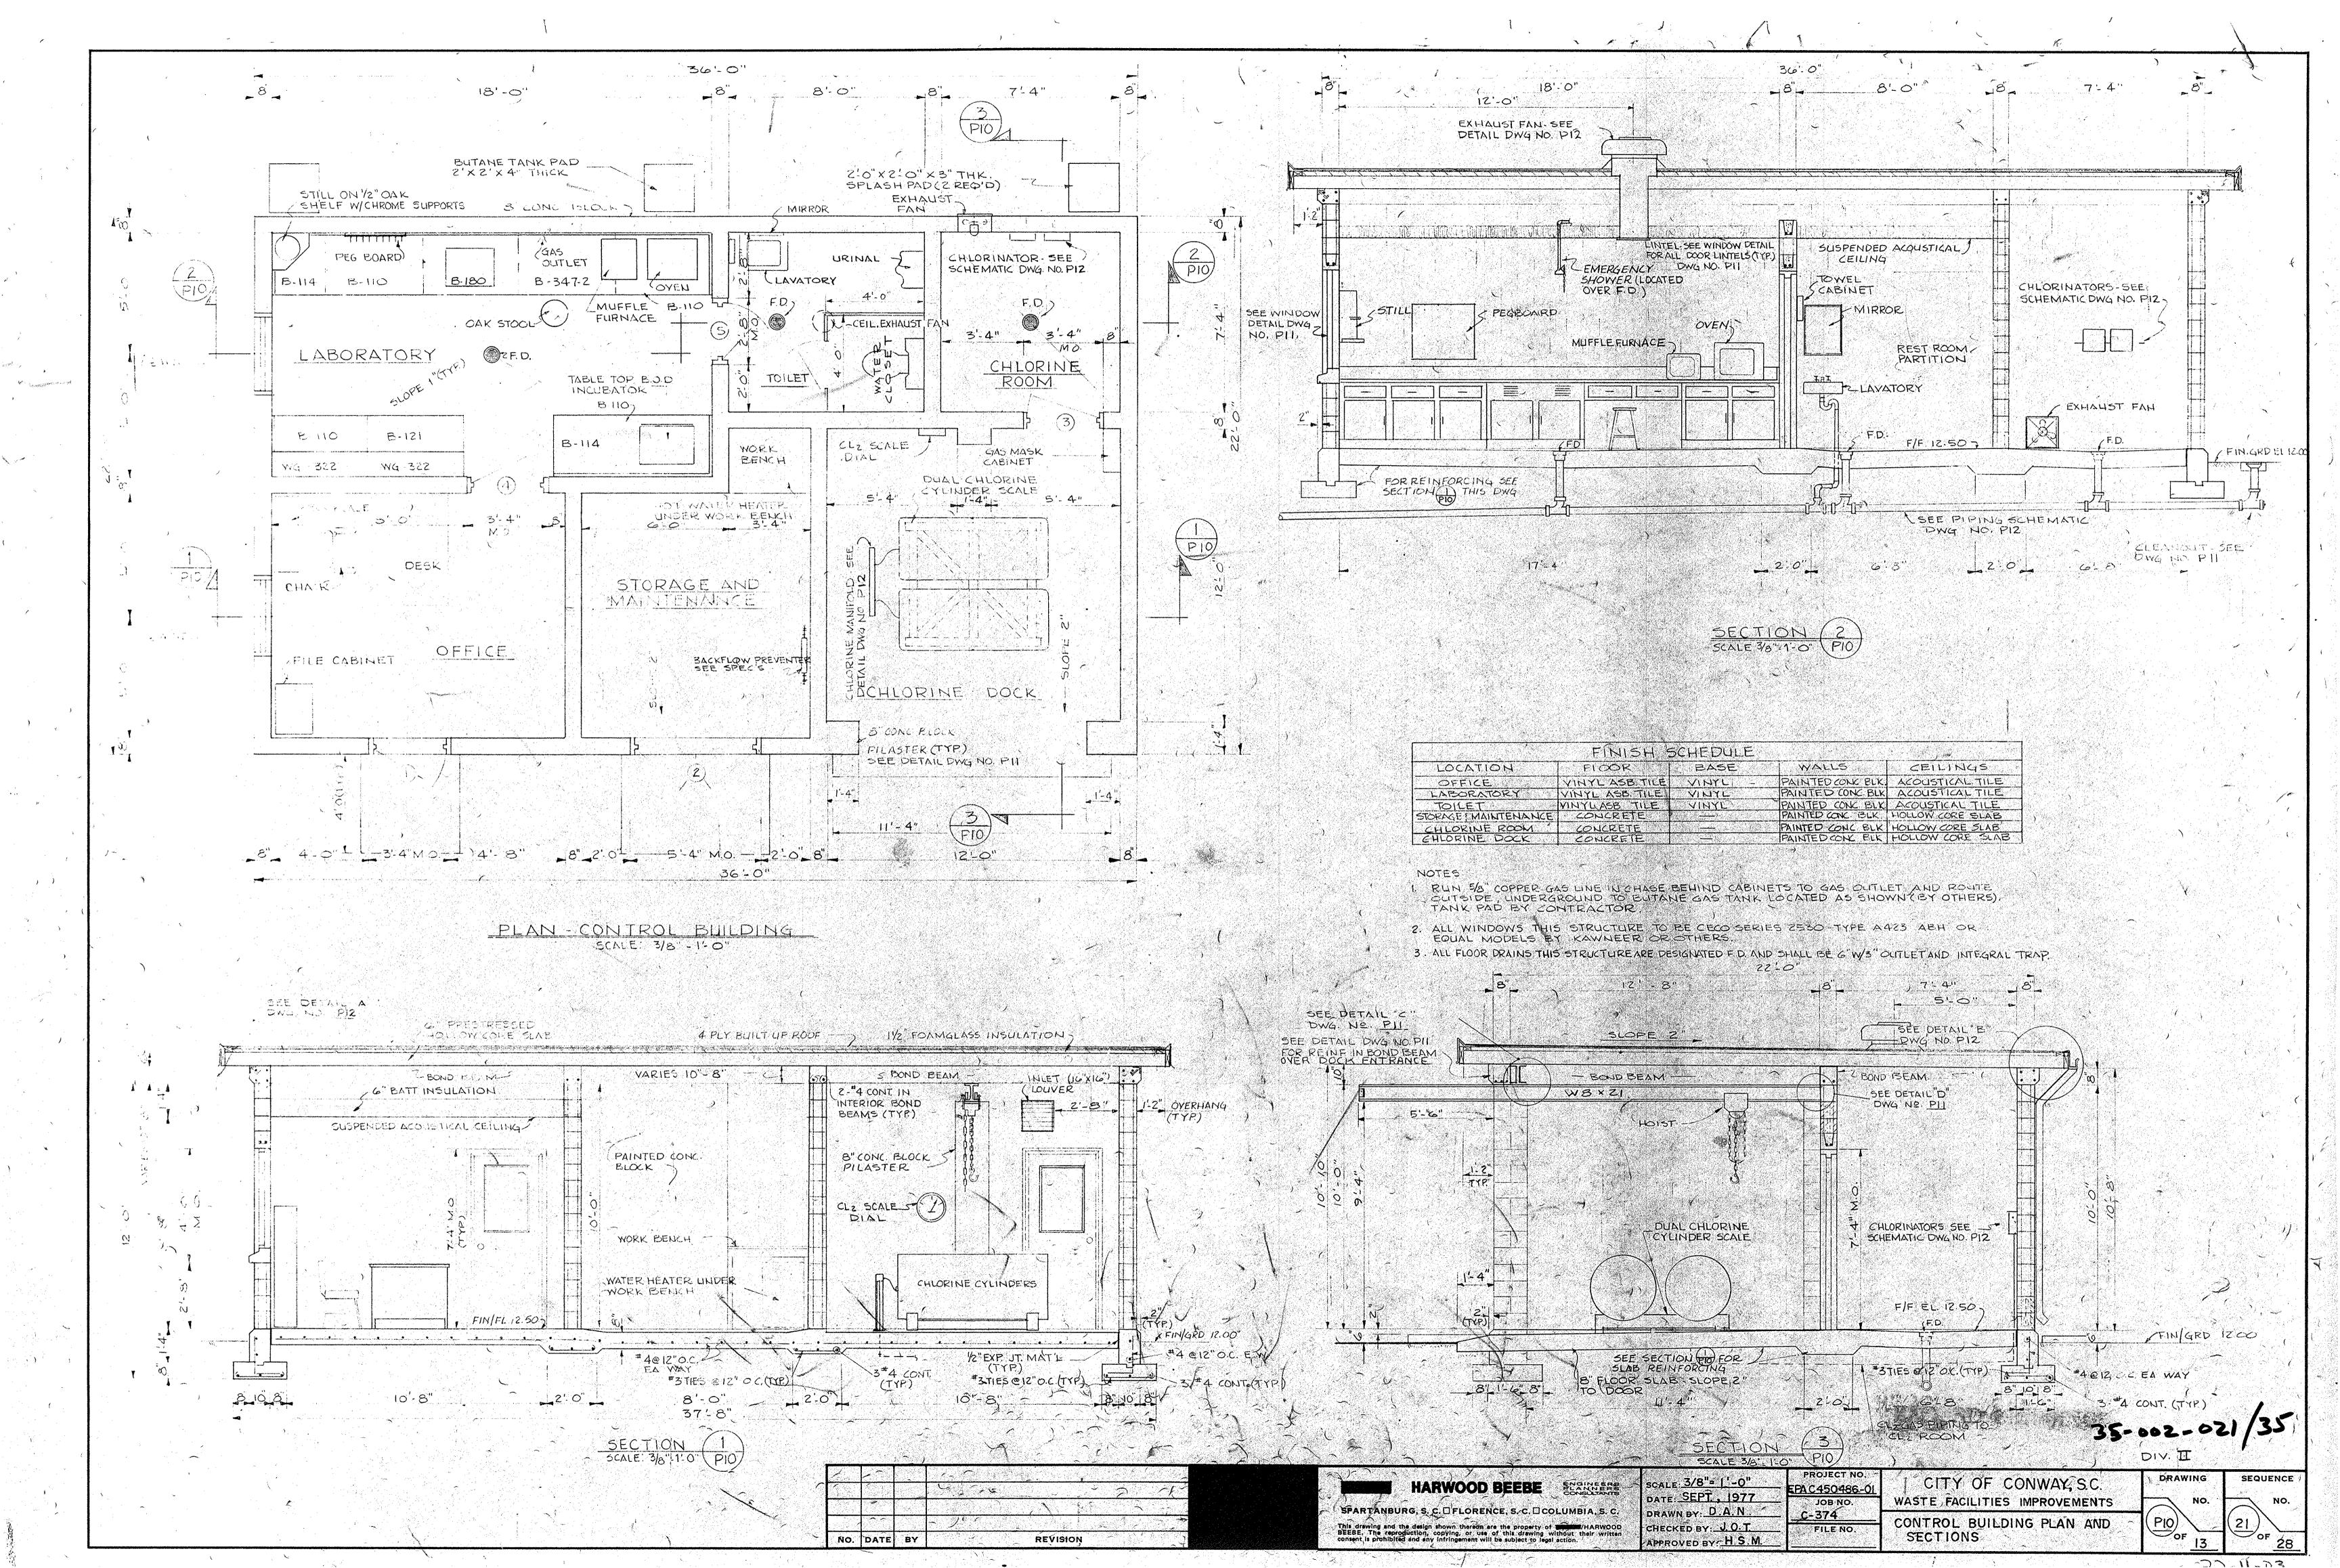


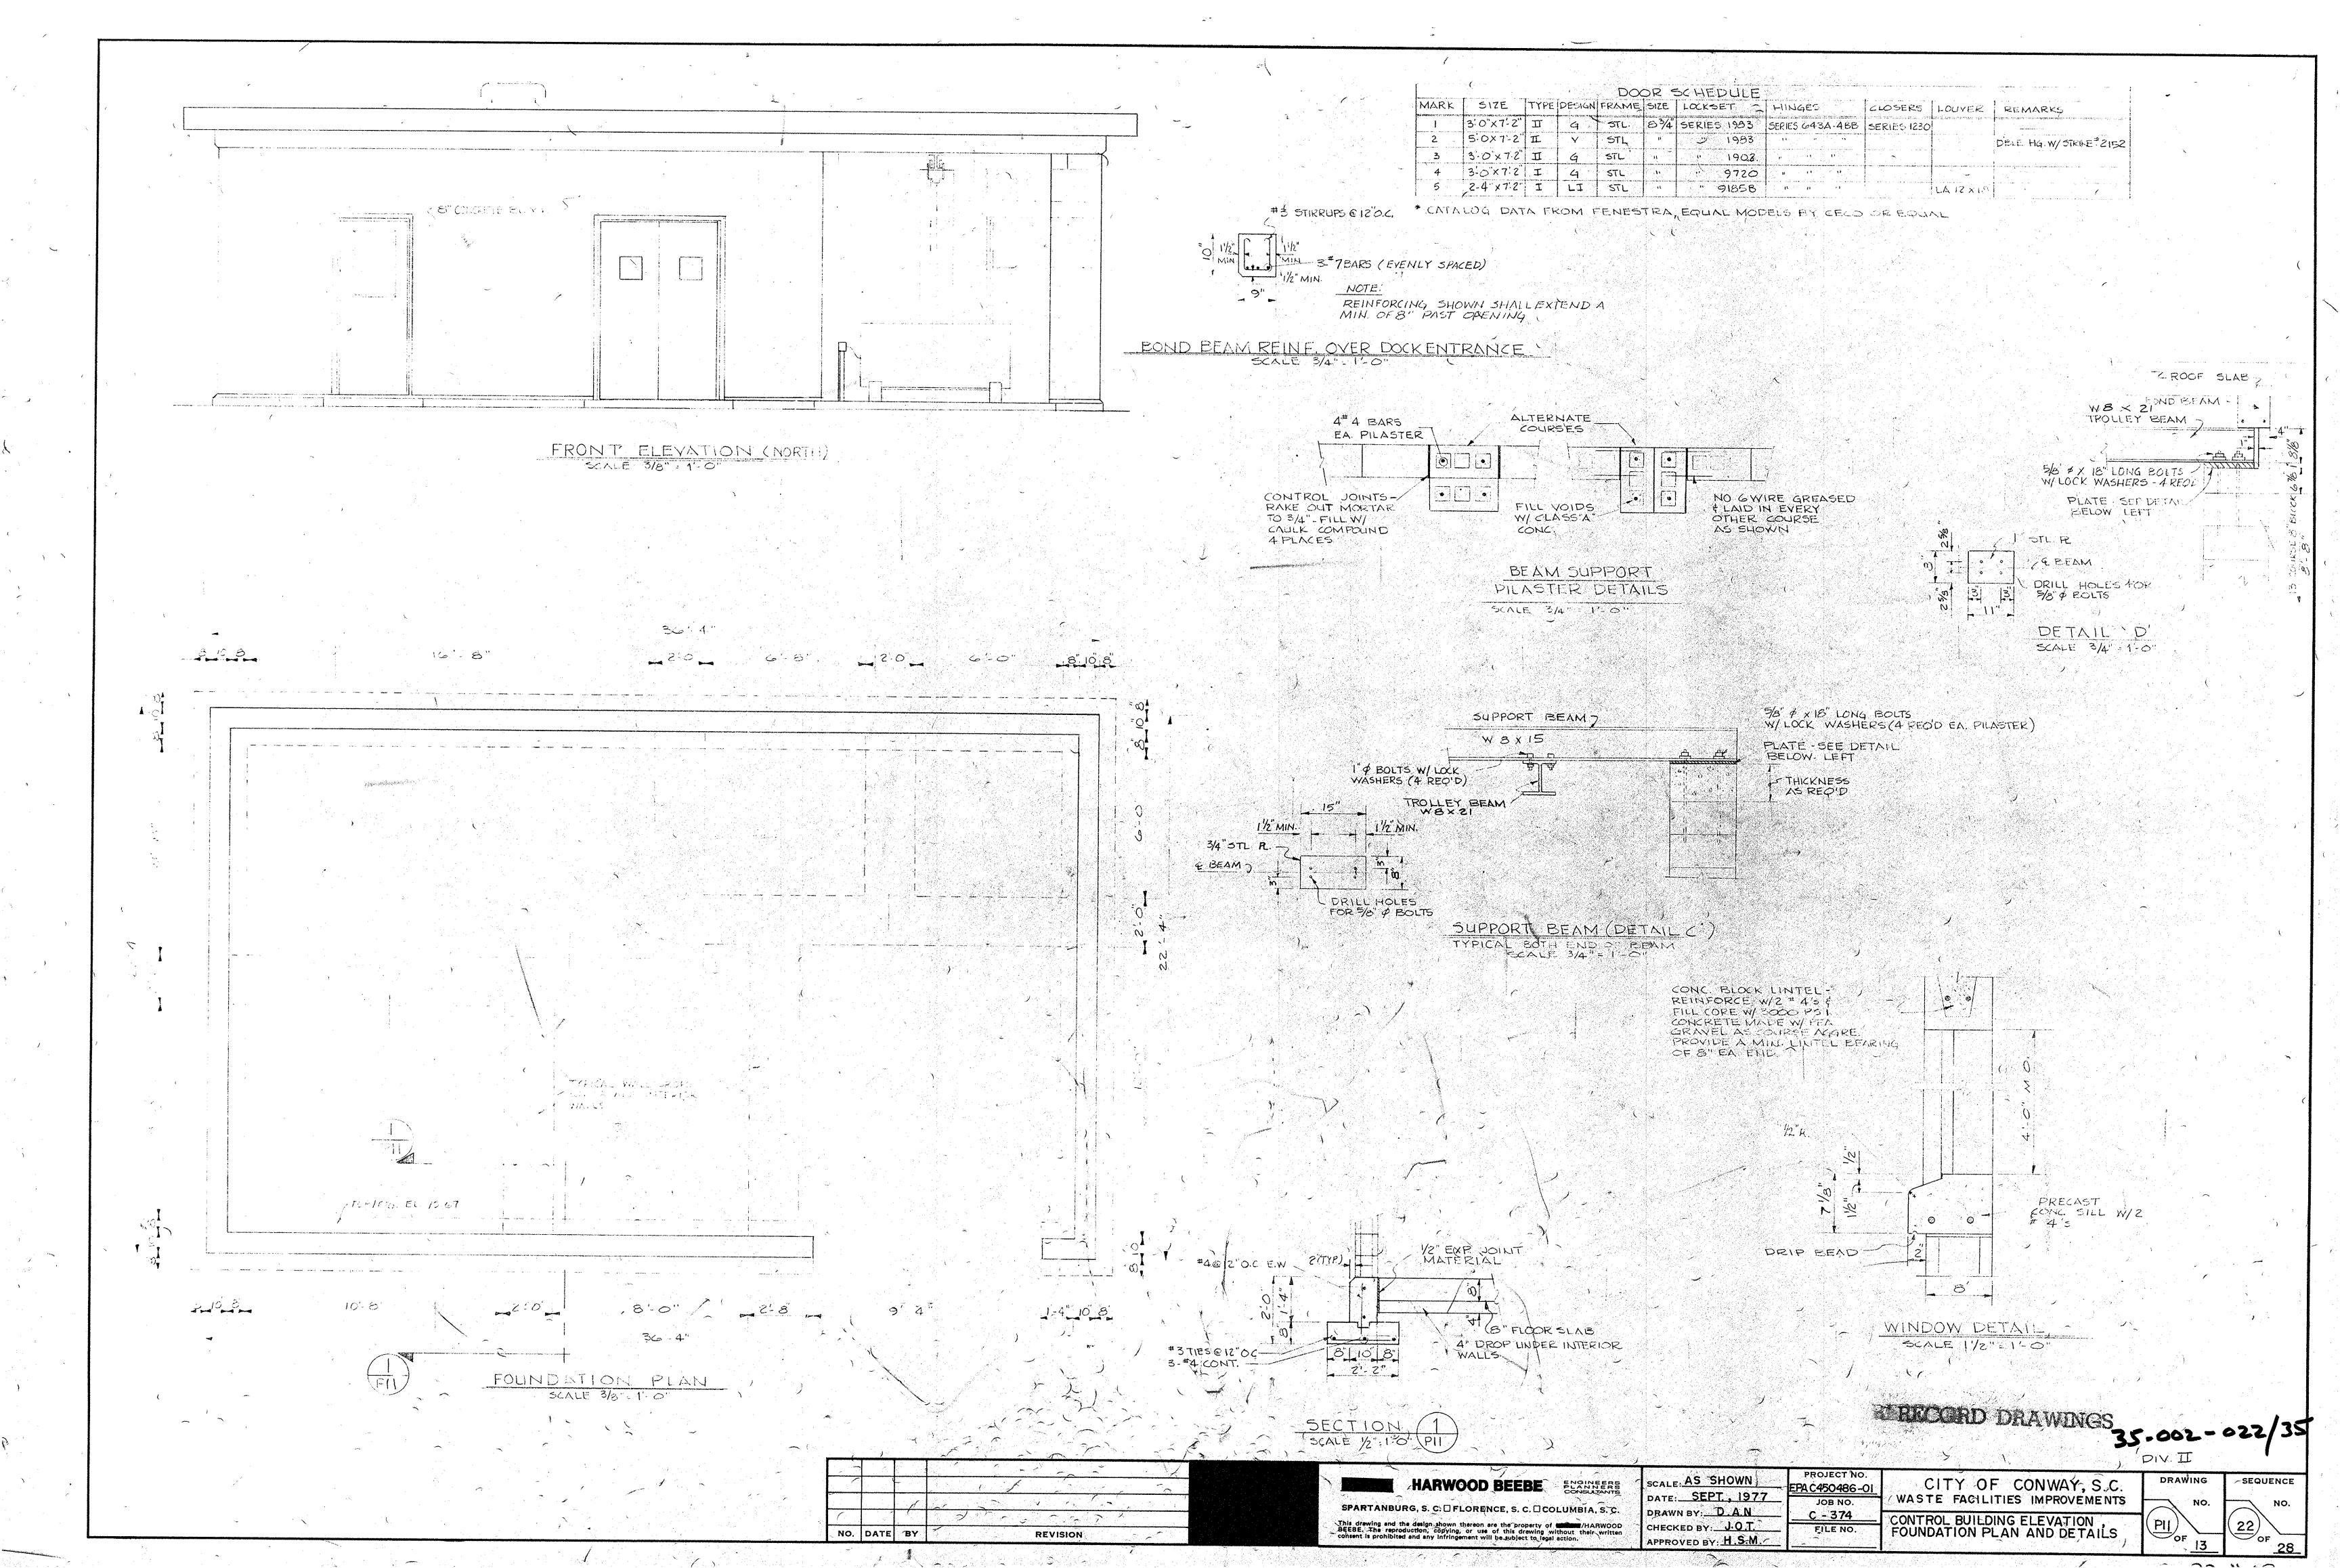

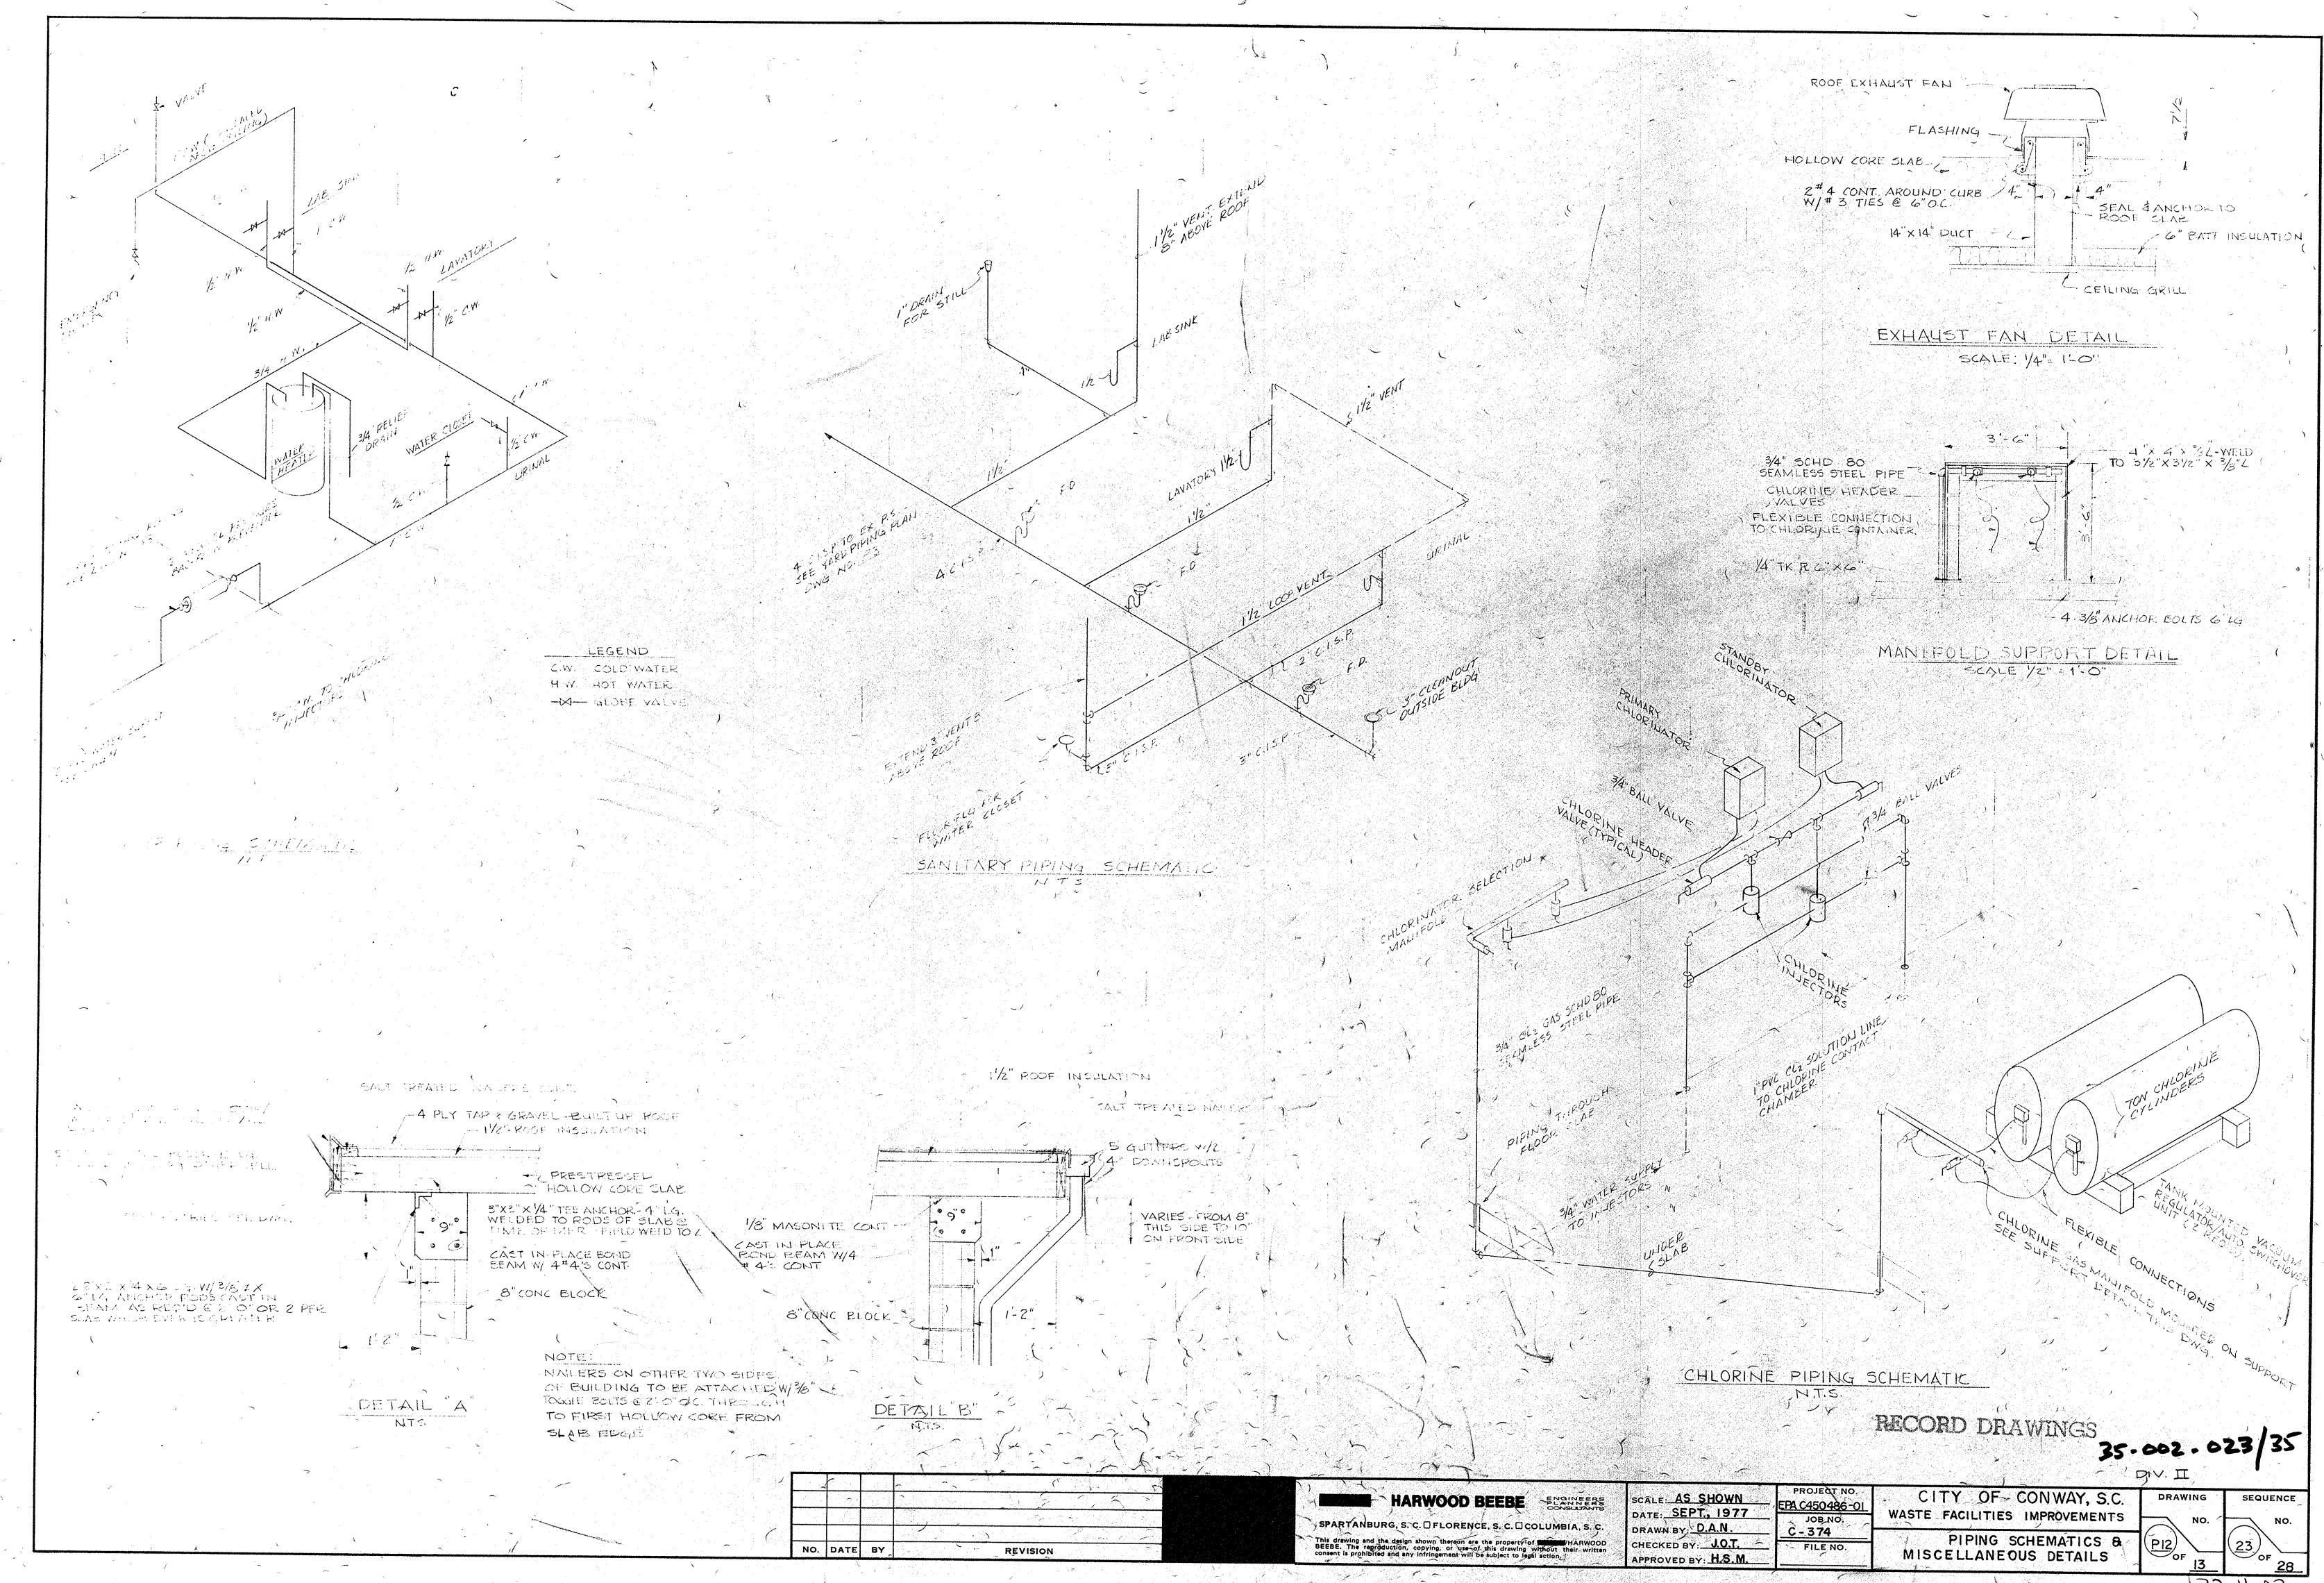


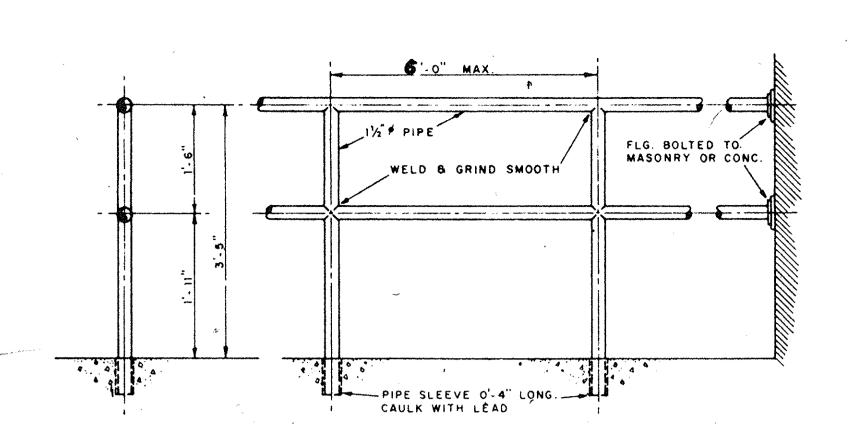


TYPICAL PIPE HANDRAIL DETAIL

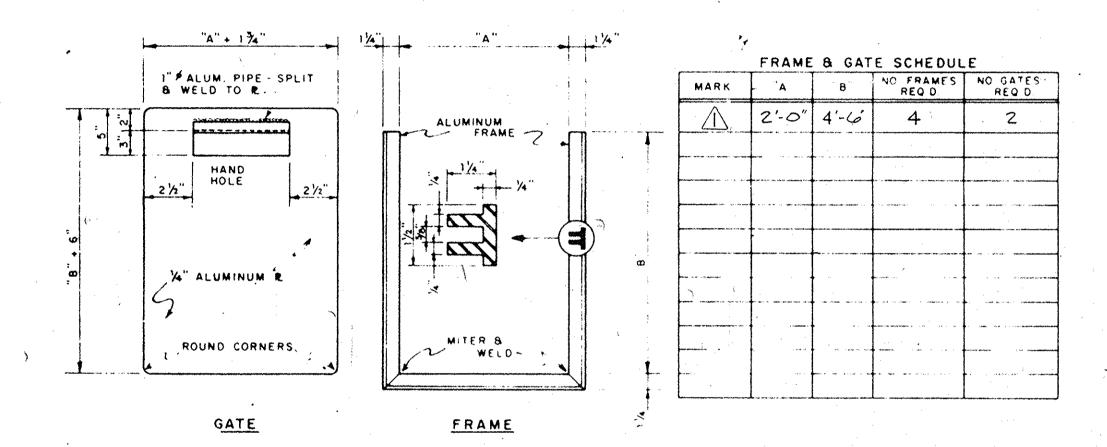


ALUMINUM STOP GATE & FRAME DETAIL

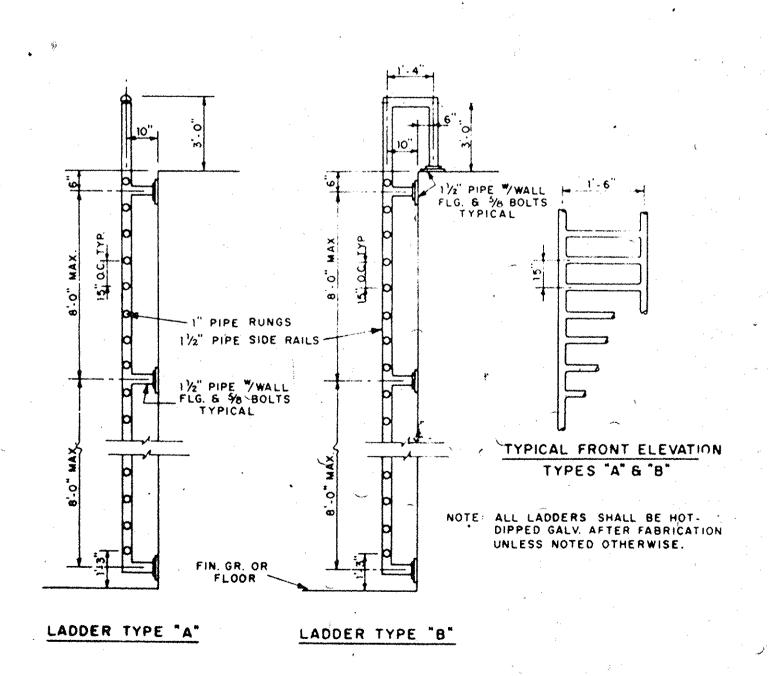


PIPE LADDER DETAILS

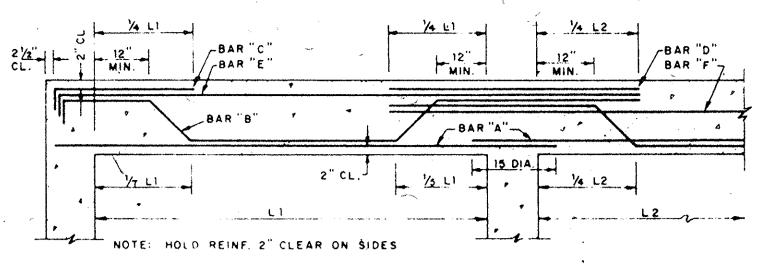

### BEAM DETAIL

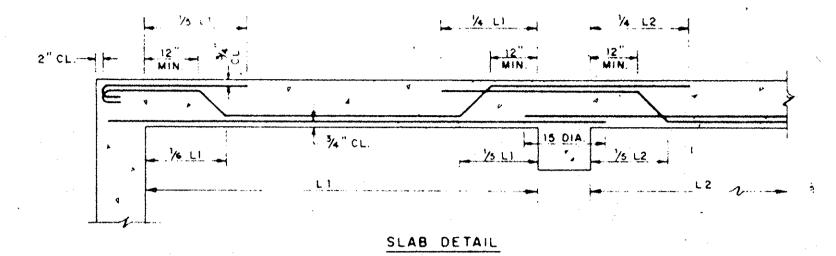

TYPICAL BEAM & SLAB BENDING DETAILS

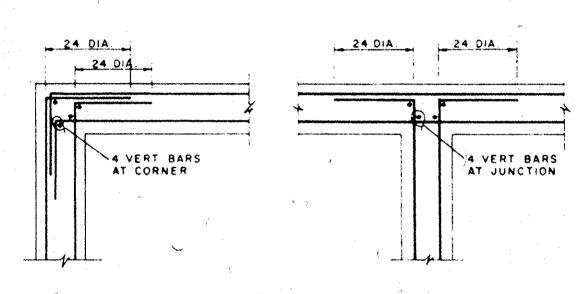

TYPICAL REINF. WALL JUNCTIONS & CORNERS

2-NO 5-1 TOP &

TYPICAL ARRANGEMENT REINFORCING

11/2" PIPE RAIL

CAULK & LEAD

PIPE SLEEVE -MITER & WELD

MOUNTING FOR PIPE HANDRAILS ON EXTERIOR OF WALKBEAMS & WALLS

REVISION

2" 10 PIPE

NO. DATE BY

AT TIE & WALL BEAM ENDS & CORNERS

2-NO 5-1 TOP 6


3/8" & ANCHOR BOLTS

THE HARWOOD BEEBE COMPANY


CONSULTING ENGINEERS

SPARTANBURG, S. C. B. FLORENCE, S. C.


2" CL

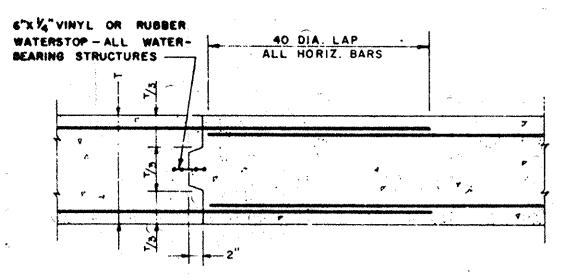

TYPICAL VERTICAL CONSTRUCTION JOINT

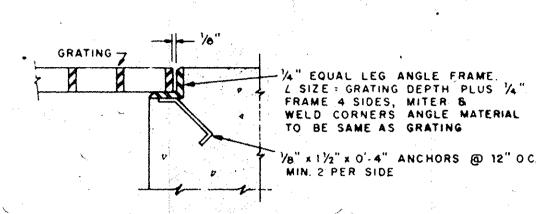


TYPICAL GRATING & FRAME DETAIL

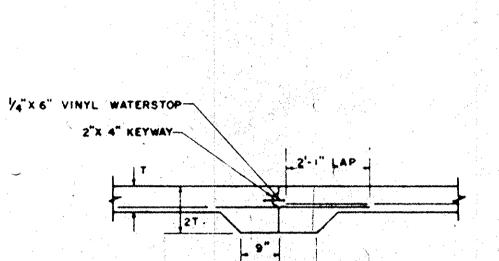

TYPICAL SLAB CONSTRUCTION JOINT SLABS ON GRADE ONLY

LIG DIP

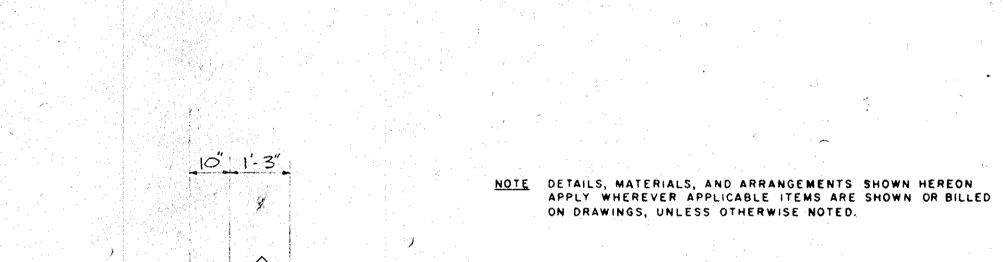



B DIAGONAL BARS, 4 EA. FACE SAME SIZE AS MAIN REINFORCING.

TYPICAL ARRANGEMENT REINFORCING WHERE PIPES PASS THRU WALLS

REINFORCING BARS IN SLABS SHALL BE HELD 3/4" CLEAR FROM FACE OF CONC. UNLESS OTHERWISE NOTED. REINF. BARS SHALL BE LAPPED 40 DIA. AT SPLICES AND SPLICES SHALL BE STAGGERED.

DOWELS SHALL EXTEND 40 DIA. INTO ADJOINING CONC.

COLUMN DOWELS SHALL EXTEND 24 DIA: INTO COLUMNS.

-HORIZONTAL REINF. IN WALLS SHALL RETURN 24 DIA. INTO ADJOINING WALLS AT JUNCTIONS AND CORNERS.

REINF. BARS IN WALLS AND BEAMS SHALL BE HELD 2" CLEAR FROM FACE OF CONC. UNLESS OTHERWISE NOTED.

REINF. BARS IN FOOTINGS AND SLABS ON EARTH SHALL BE HELD 3" CLEAR FROM FACE OF CONC.

ALL EXPOSED CORNERS OF CONCRETE SHALL BE CHAMFERED 3/4"

### DESIGN STRESSES

CONCRETE: COMPRESSIVE STRENGTH AT 28 DAYS. DESIGN STRESS IN FLEXURE C. . 1,350 PSI

REINFORCING STEEL: WATER BEARING STRUCTURES - TENSION DUE

TO BENDING..... 18,000 PSI -NON-WATER BEARING STRUCTURES-

TENSION DUE TO BENDING ...... . 20,000 PSI DIRECT TENSION .. 14,000 PSI

#4@8"EA.WAY BEND HORIZONTAL BAR INTO WINGWALLS -16" PIP. 7 

HEADWALL FOR EFFLUENT PIPE - PLAN

10" 1'-3"

SCALE: 1/2" - 1-0"

-SCALE: 1/2"=1'-0" P12)

DRAWN BY:\_

CHECKED BY: J.O.T.

APPROVED BY: H.S.M.

PROJECT NO. SCALE: N.T.S. EPA C450486-01 DATE: SEPT. 1977

JOS NO.

B C - 374

FILE NO:


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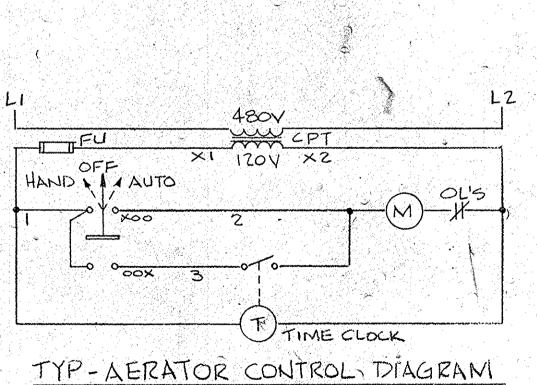
CITY OF CONWAY, S.C. DRAWING WASTE FACILITIES IMPROVEMENTS STANDARD STRUCTURAL AND

MISCELLANEOUS DETAILS

22-11-03

SEQUENCE



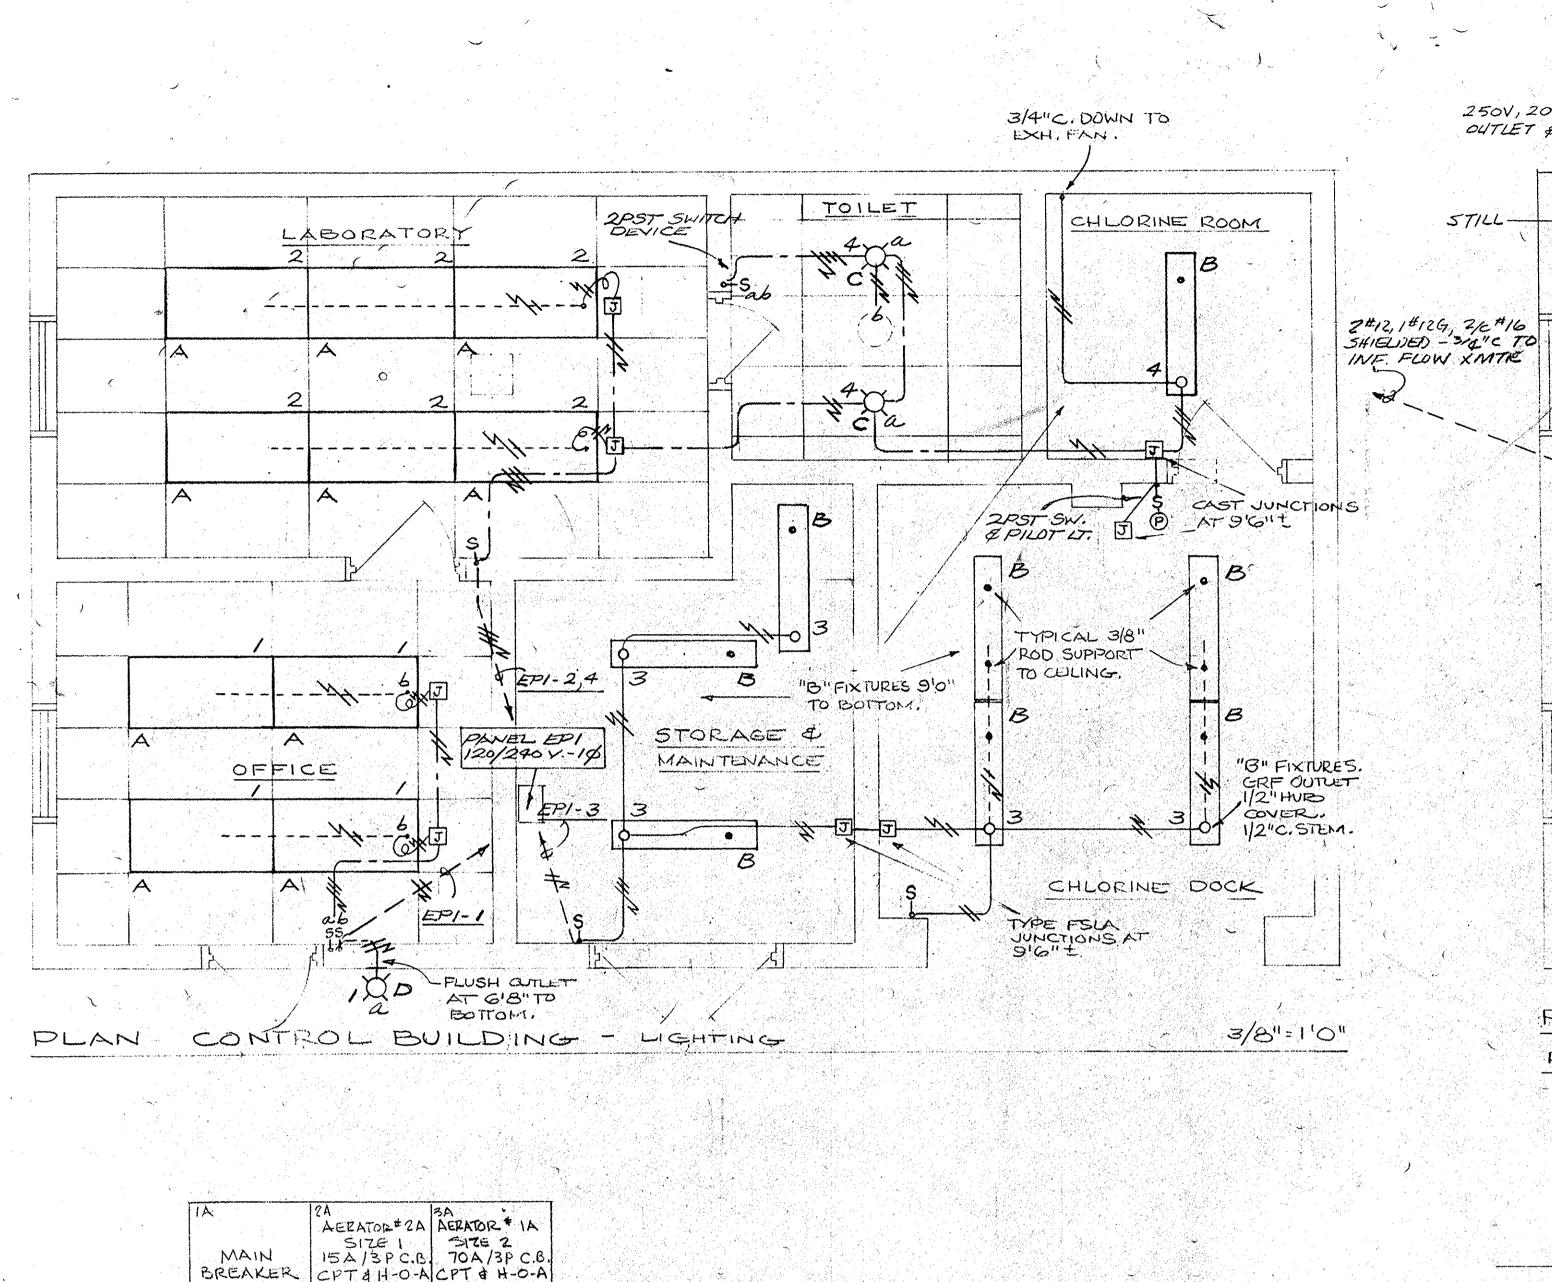

5 CHEDULE MOTOR CONTROL CENTER MCC-(SEE SPECS)

AERATOR #28 AERATOR #18

15A/3P C.B. 70A/3P C.B. CPT & H-O-A CPT & H-O-A

SIZE

BAR AERATOR # 2C AERATOR # 1C 5C REEN SIZE 1 20A BPC.B. CPT # H-O-A 70A BPC.B.

TARD
LIGHTS
SIZE 1
TIME CLOCK
TO SIZE 1
TIME CLOCK
TO SIZE 1
TIME CLOCK
COMPARTMENT.
CPT & H-O-A
EIGHT (8)

SIZE 1 15A/3P C.B. CPT 4 H-O-A

SPACE

SIZE 2

TORK# 8001

AERATOR # 2E WITH SPRING

(OR EQUAL)

MOUND

RESERVE

200 A / 3P

CIRC. BREAKER

SPACE

SPACE

# LIGHTING FIXTURE SCHEDULE

REFER TO SITE PLAN, 'DRAWING NO. 52.

250V, 20A, 2P, 3W-

EP1-5-7

-EP1-13

LABORATORY

- INFLUENT FLOW! INDICATOR/RECORDER/ TOTALIZER

3/4" ENPTY CONOUIT

TO TELL, CAISINET.

OFFICE

EP1-19'

250V, 20A;

EP1-9-11\_

PANIL EPI-

3W OUTLET

OUTLET & BOX

} [	TYPE	DESCRIPTION
	4	2'x4' FLUORESCENT TROFFER WITH PRISMATIC ACRYLIC LENS, 120V BALLAST, 4-40 WATT, F40T12/CW LAMPS. SYLVANIA NO. KFW-BD-4404 OR EQUAL!
and the second s	B	4' INDUSTRIAL TYPE FLUORESCENT FIXTURE WITH SLOTTED REPLECTORS (10% UPLIGHT): 120V BALLAST; 2-40 WATT F40TIZ/CW LAMPS SYLVANIA NO. PVIO-2404 OR EQUAL.
	<u>,</u>	RECESSED INCANDESCENT FIXTURE WITH WHITE ALBALITE GLASS LENS \$ 150 WATT A-ZI LAMP LIGHTOLIER NO 7303 OR EQUAL.
	D.	WALL MOUNTED OUTDOOR INCANDESCENT WITH 100 WATT A 19 LAMP, HOLOPHANE NO. 400 OR EQUAL.
	E	WALL MOUNTED VAPORTIGHT INCANDESCENT. FIXTURE WITH GLOBE & 30° ANGLE REFLECTOR, 150 WATT A-21 LAMP. CROUSE HINDS NO. VXHBF 25GRA OR EQUAL:
		LOW PRESSURE SODIUM AREA LUMINAIRE WITH 135 WATT LAMP, 480V, ID BALLAST & PHOTO-ELEC. CONTROL - NORELCO NO 31665 WITH SOX-135 LAMP, OR EQUAL, MOUNTED ON 30' TAPERED ALUMINUM POLE WITH 4' MOUNTING ARM - HAPCO NO 21-582 OR EQUAL.

WATER HEATER. LEP1-21 CHLORINE DOCK EP1-10-12 -3#2, [#10G-112"C -SIGNAL & CAR. DOUBLE THROW STORAGE & MAINTENANCE TRANSTER SWITCH, 400A, 3P, 480V 2#6, 1#104-1"C (PRI) 18,146G-2"C (3.500Mcm, 1#26,3'2'C AUXILIARY SLZVICE. RECEPTACIE TO SERVICE PRINTS PLAN - CONTROL BUILDING - CONVENIENCE OUTLETS & POWER DRAWING LEGEND & SYMBOLS: MOTOR LOCATION, HORSEPOWER INDICATED,

- EXHAUST FAN

CHILORINE ROOM

- CHLORINATORS

TON - CIRCUIT TERMINAL COMMECTION IN FLEXIBLE LIQUID-TIGHT METAL CONDUIT, MINIMUM 3/4" SIZE,

RACENAY RUN EXPOSED AT CEILINGS & ON WALLS, EXCLIPTAS NEUTRAL COMPUCTORS

MOTED. RIGID STEEL CONUNT, 3/4"
UNLESS OTHERWISE NOTED. NO. 12 CONDUCTORS OR AS INDICATED. RACEWAY RUN CONCENLED ABOVE CEILING CONSTRUCTIONS & TURNED

DOWN CONCEALED IN WALL OR PARTITIONS. RIGID STELL CONDUIT 3/4" MINIMUM SIZE, NO.12 CONDUCTORS EXCEPT AS HOLED. RACEVINY RUN UNDERGROUND, OR

UMBER FLOOR SLAPS, CONCLULIO. MINIMUM SIZE 3/4" RIGID STELL CONDUIT, NO. 12 CONDUCTORS EXCEPT AS NOTED.

MOUNTED OVER FLUSH OUTLET; HEIGHT INDICATED. O - INCANDESCENT TYPE LIGHTING FIXTURE ON CEILING OUTLET.

B (etc)

- FLUORESCENT TYPE LIGHTING FIXTURE, CEILING SURFACE MOUNTED OR SUSPENDED AS NOTED.

FLUORESCENT TYPE LIGHTING FIXTURE, CEILING RECESSED, FLEX. METAL CONDUIT TO OUTLET ABOVE CEILING,

FLUSH MOUNTED SWITCH WIRING DEVICE, 20A.
IP. 1204, MOUNTING HEIGHT 48" OR AS NOTED. WALL SURPACE MID. SWITCH DEVICE, CAST SURFACE OUTLET, AT 48" OR AS NOTELD.

FLUSH WALL OUTLET AT 16" EXCEPT AS NOTED DUPLEX 2-MIRE 3-WIRE GROUNDING ELCEPTACLE DEVICE, ISA AT 120V.

DUPLEX RECEPTACLE, GROUND-FAULT INTERRUPTER TYPE, AS SRECIFIED.

HARWOOD BEEBE SPARTANBURG, S.C. □FLORENCE, S. C. □COLUMBIA, S. C.

PROJECT NO. SCALE: AS NOTED DATE: SEPT., 1977 PA C450486-0 JOB NO. DRAWN BY: CAR C-374 CHECKED BY: REH FILE NO. APPROVED BY: HSM

RECORD DRAWINGS

HEDT-PWAP CONDENSES UNIT.

INCUBATOR-

delet. HEATER.

-3#10,1#10G-34K EDI-20

25 KVA X FMR 14

480V TO 120/240V

AUTUCLAVE -

TOILET


CITY OF CONWAY WASTE FACILITIES IMPROVEMENTS CONTROL BUILDING ELECTRICAL PLANS


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22-11-03


SEQUENCE


DRAWING



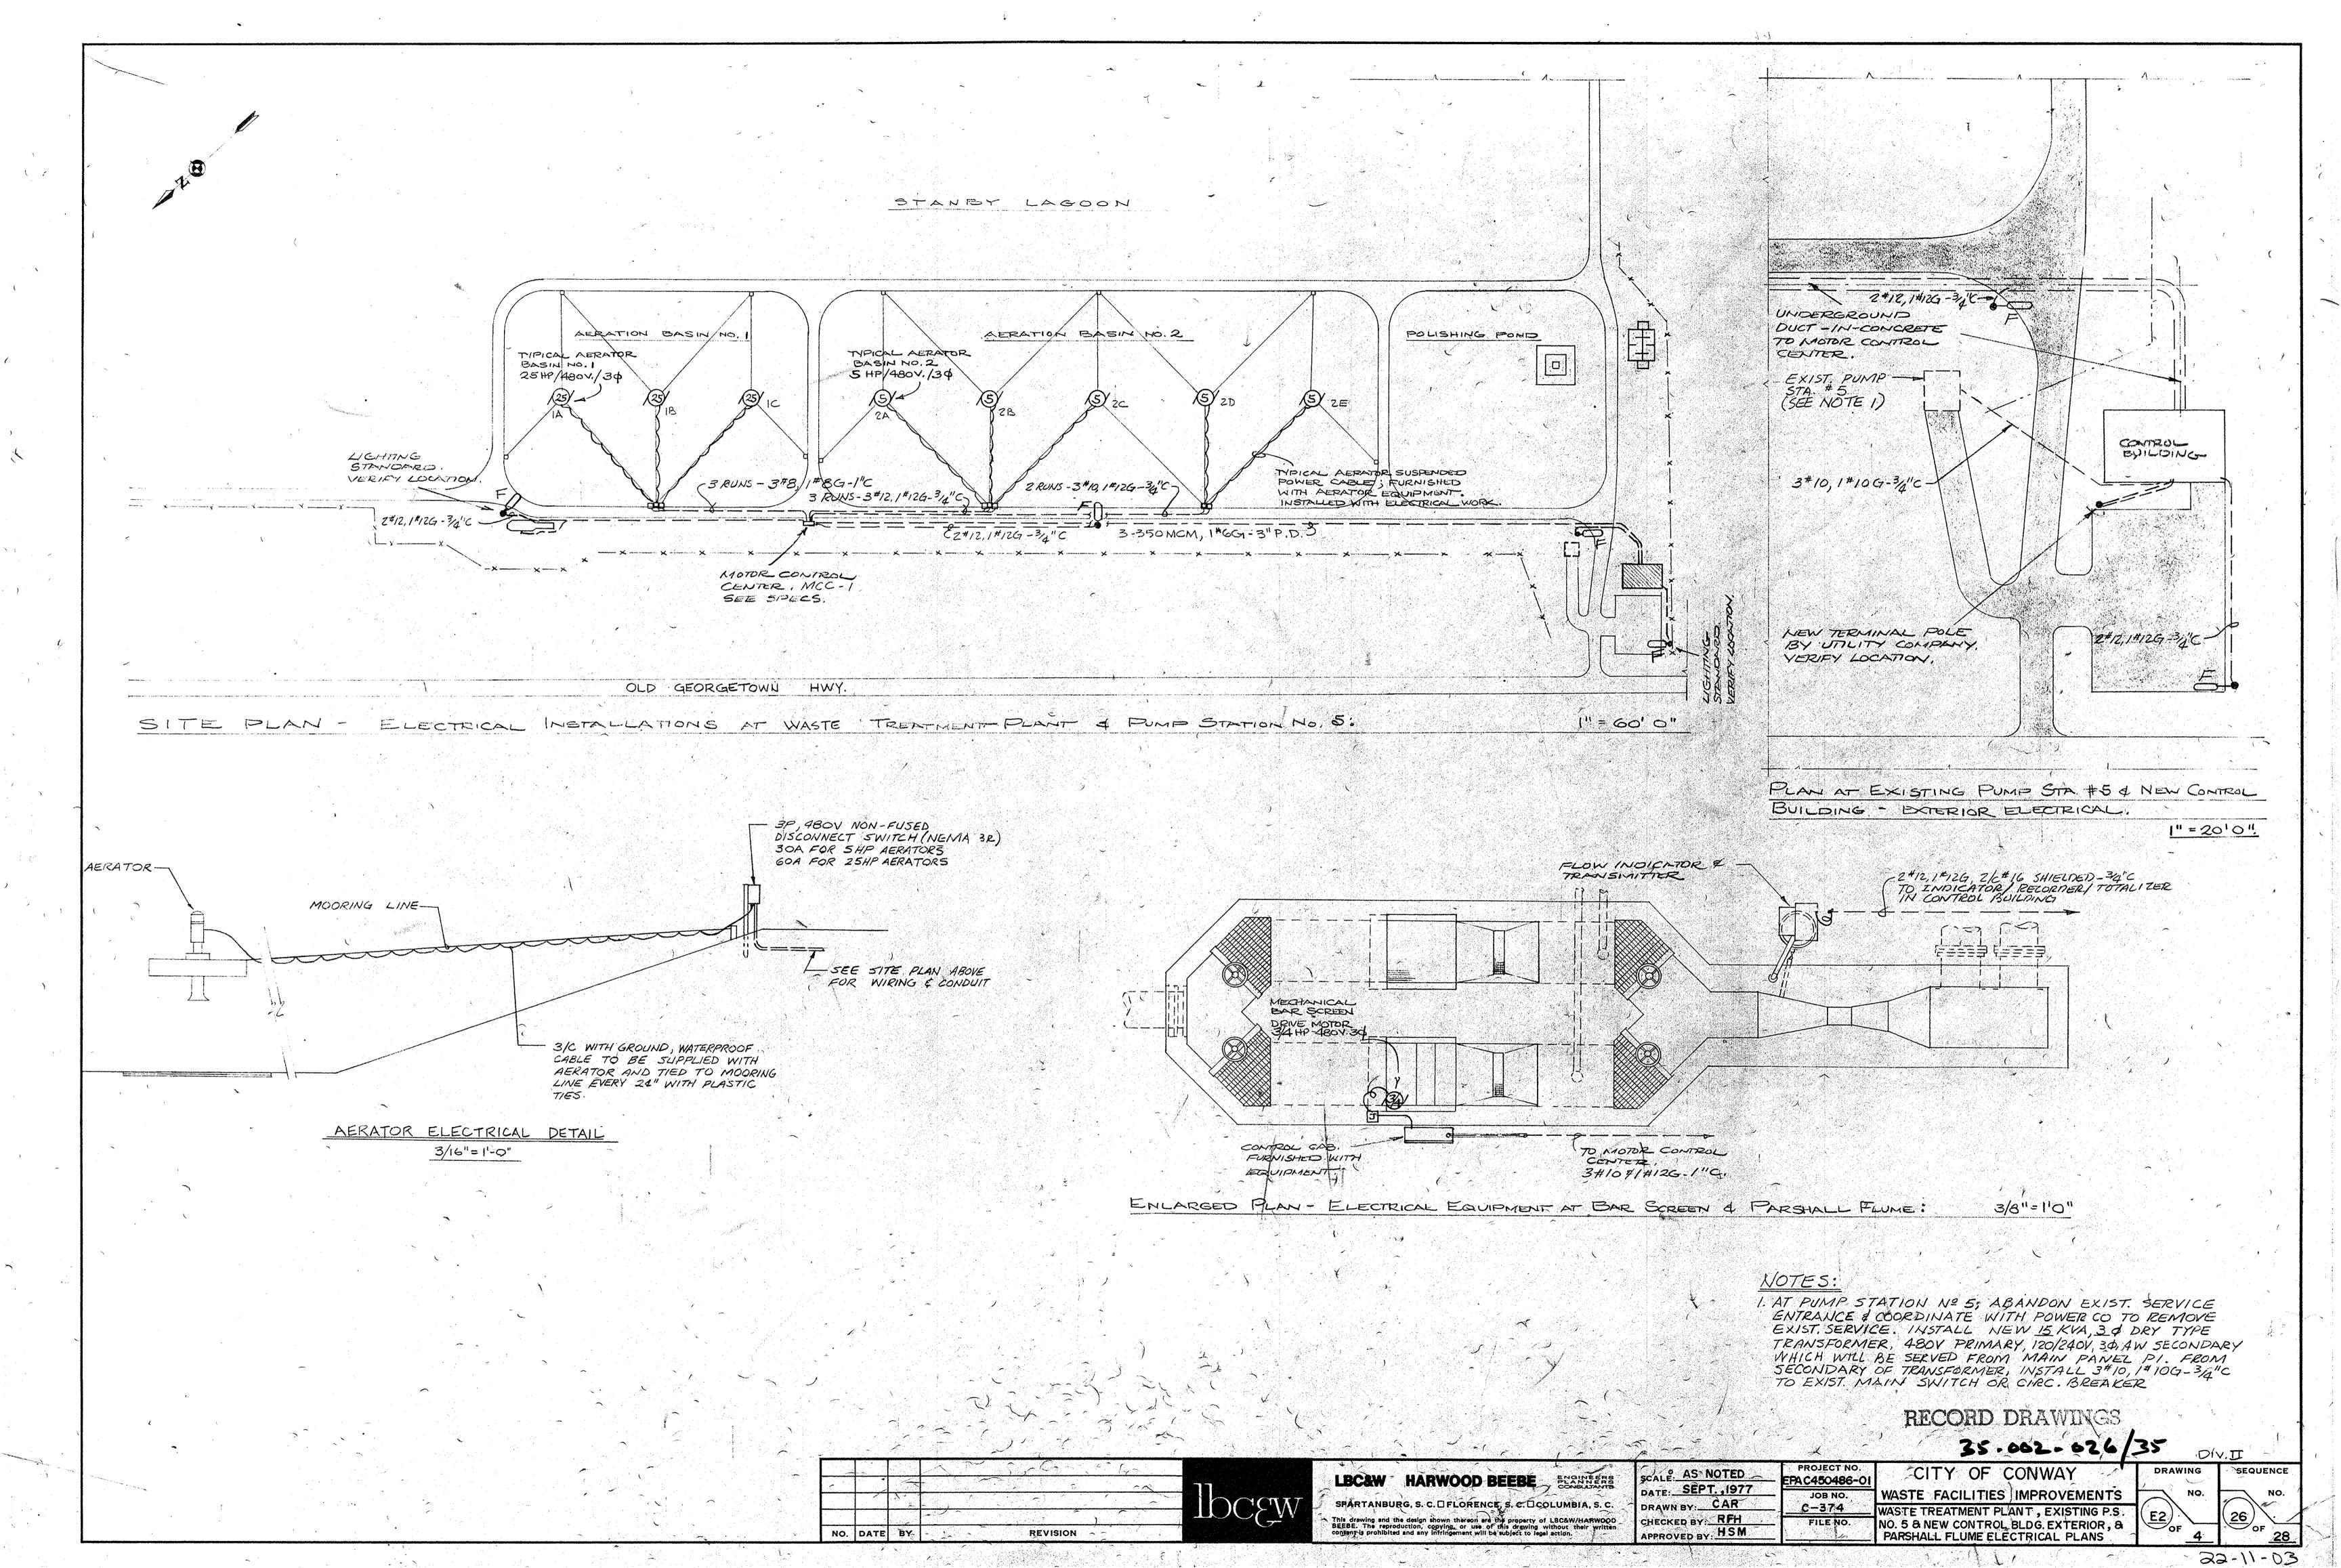


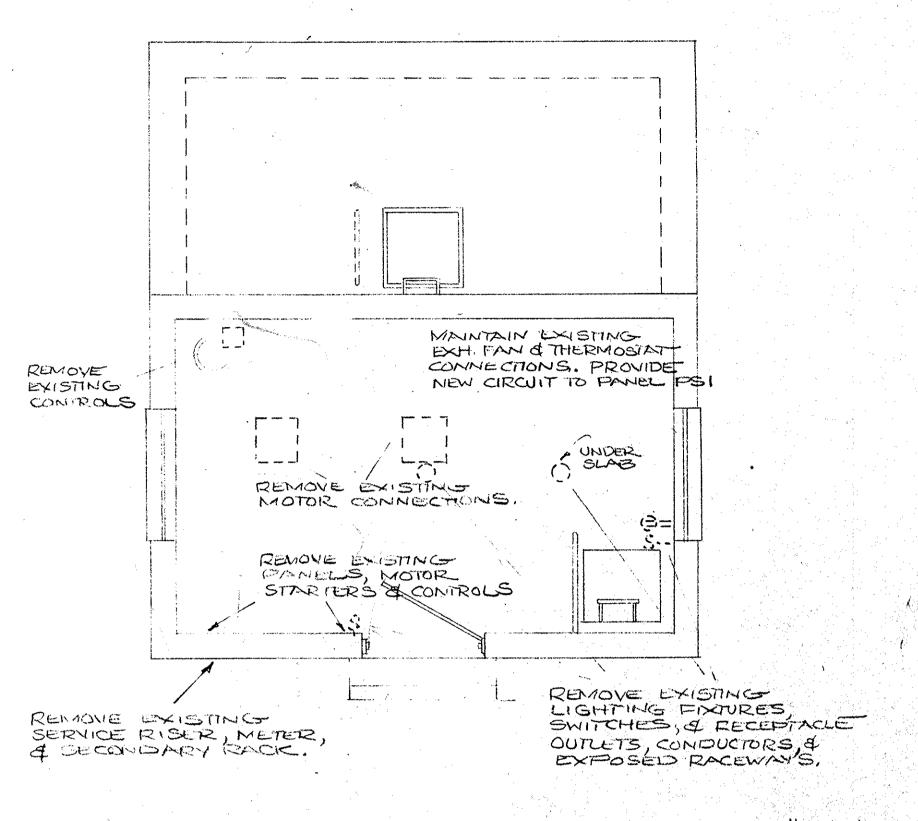PLAN - EXISTING PUMP STATION No. 1: 3/8"=110" VERIFY EXISTING CONDITIONS AT SITE, REMOVE ALL EXISTING ELECTRICAL EQUIPMENT, PACEWAY, AND CONDUCTORS NOT REQUIRED TO BE REUSED.

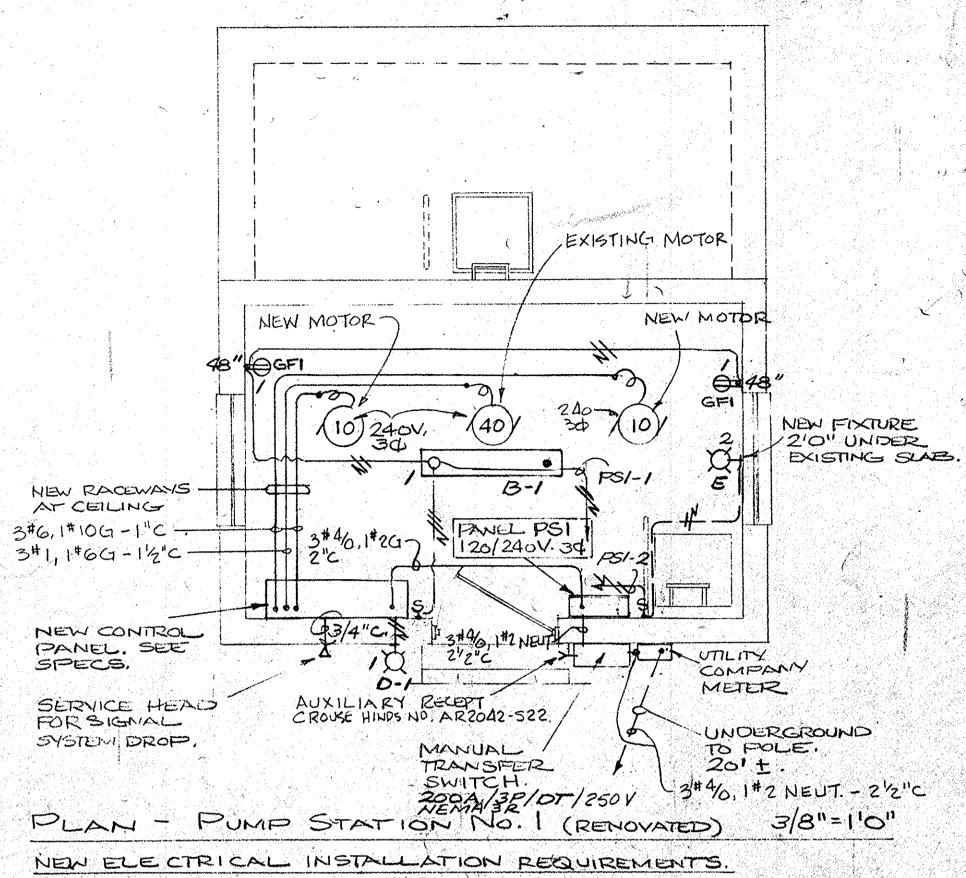

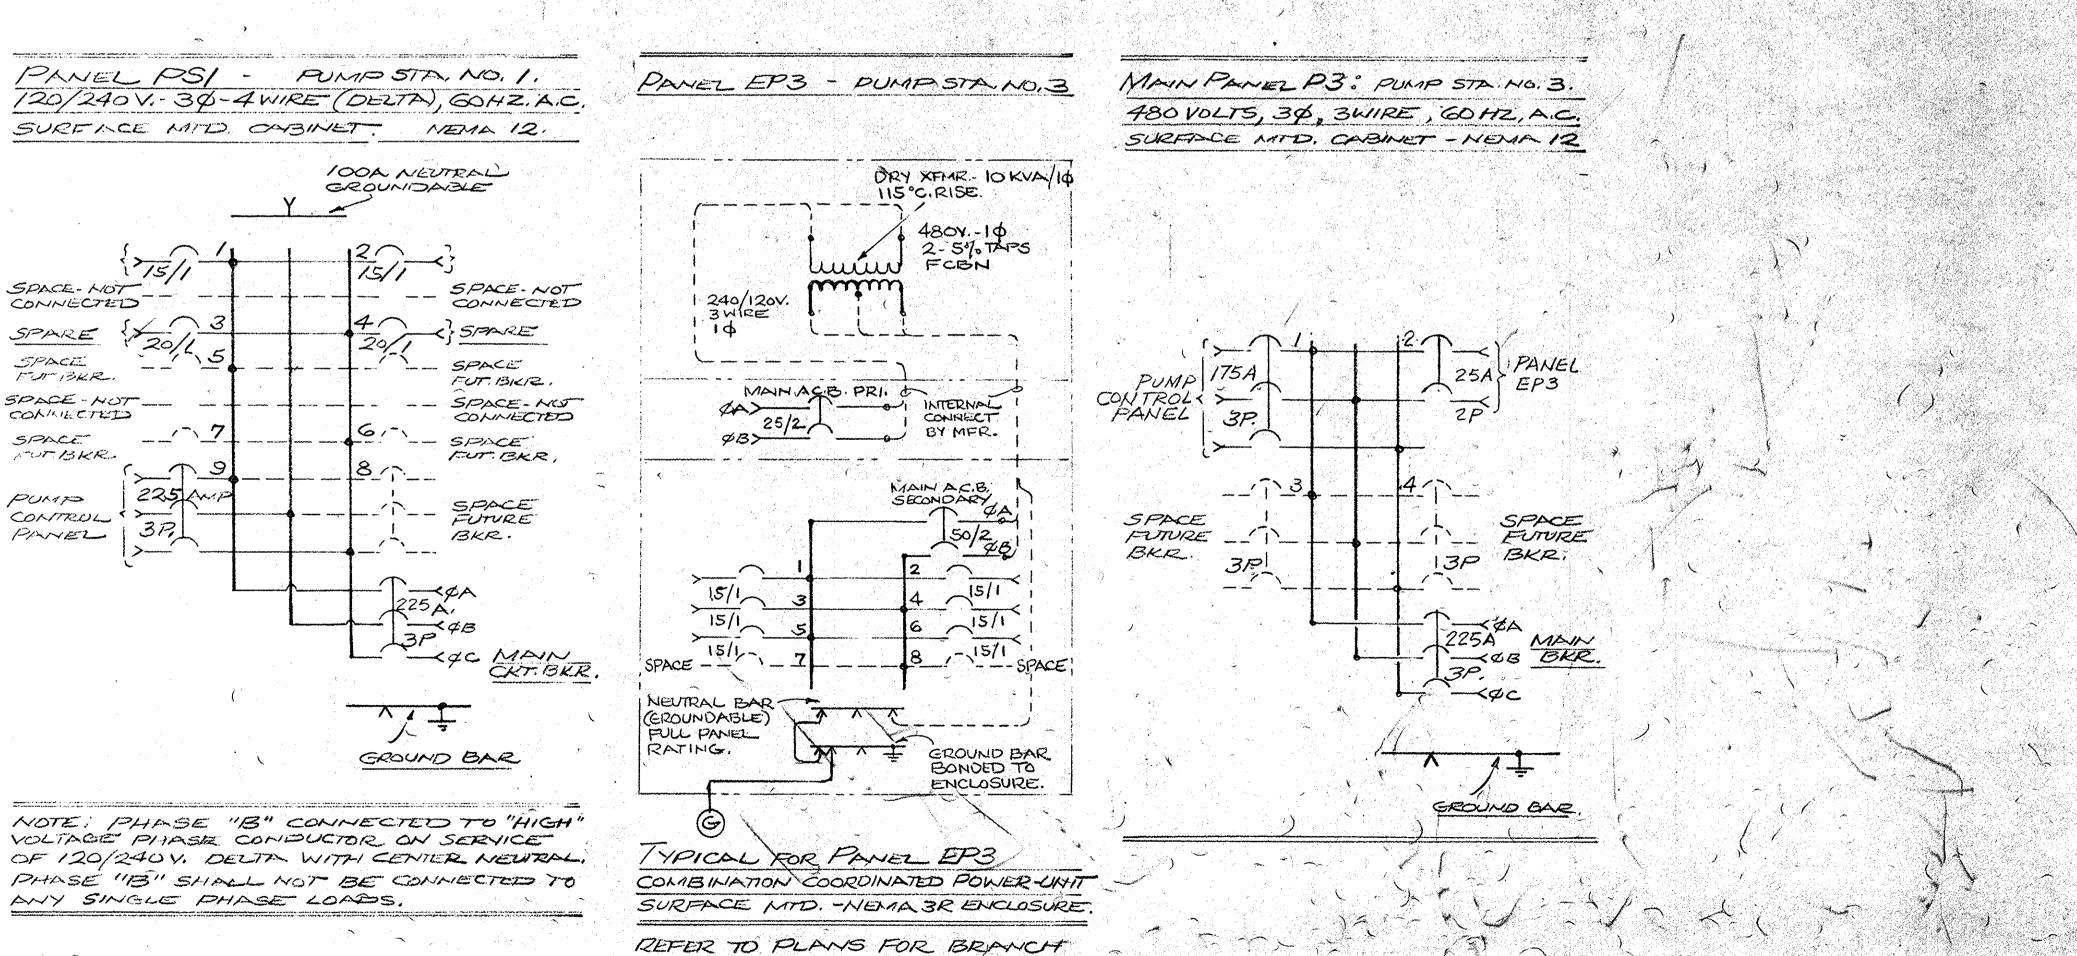

CIRCUITS CONNECTED; OTHERS SPARE.

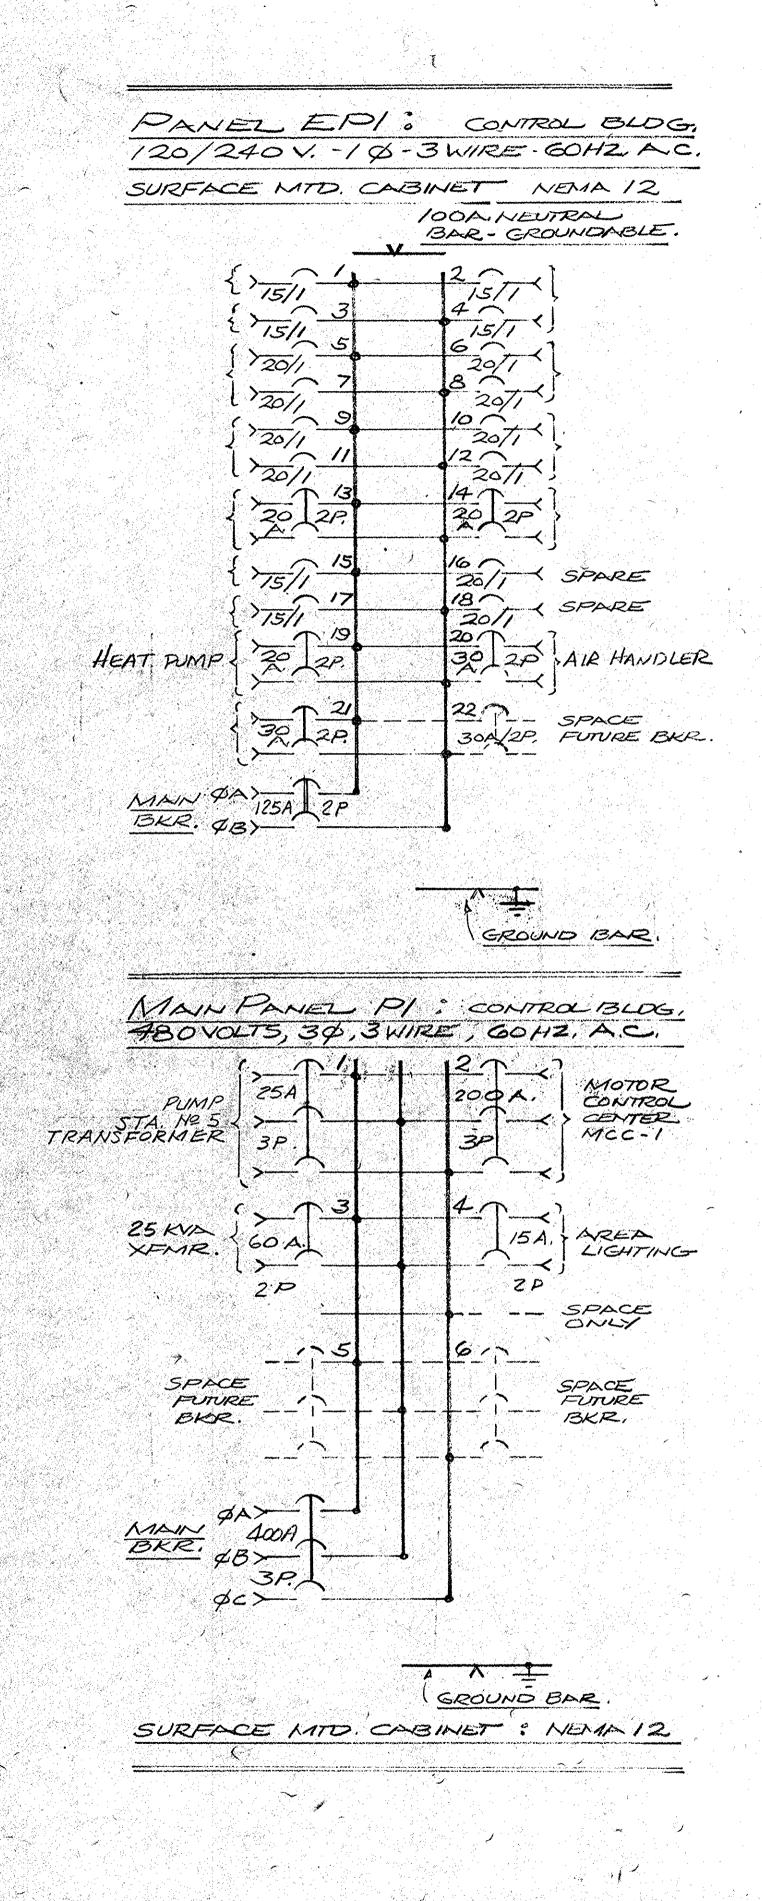

35.002-027/35 DIVI

CITY OF CONWAY WASTE FACILITIES IMPROVEMENTS

SEQUENCE

APPROVED BY HSM

NO. DATE BY REVISION:


LBC&W HARWOOD BEEBE ELGINEERS

SPARTANBURG, S.C. | FLORENCE, S. G. | COLUMBIA, S. C.


DATE: SEPT., 1977 JOB NO. DRAWN BY: CAR C-374 PUMP STATION NO. I CHECKED BY: RFH -ELECTRICAL PLANS

PAC450486-0

SCALE: ÀS NOTED

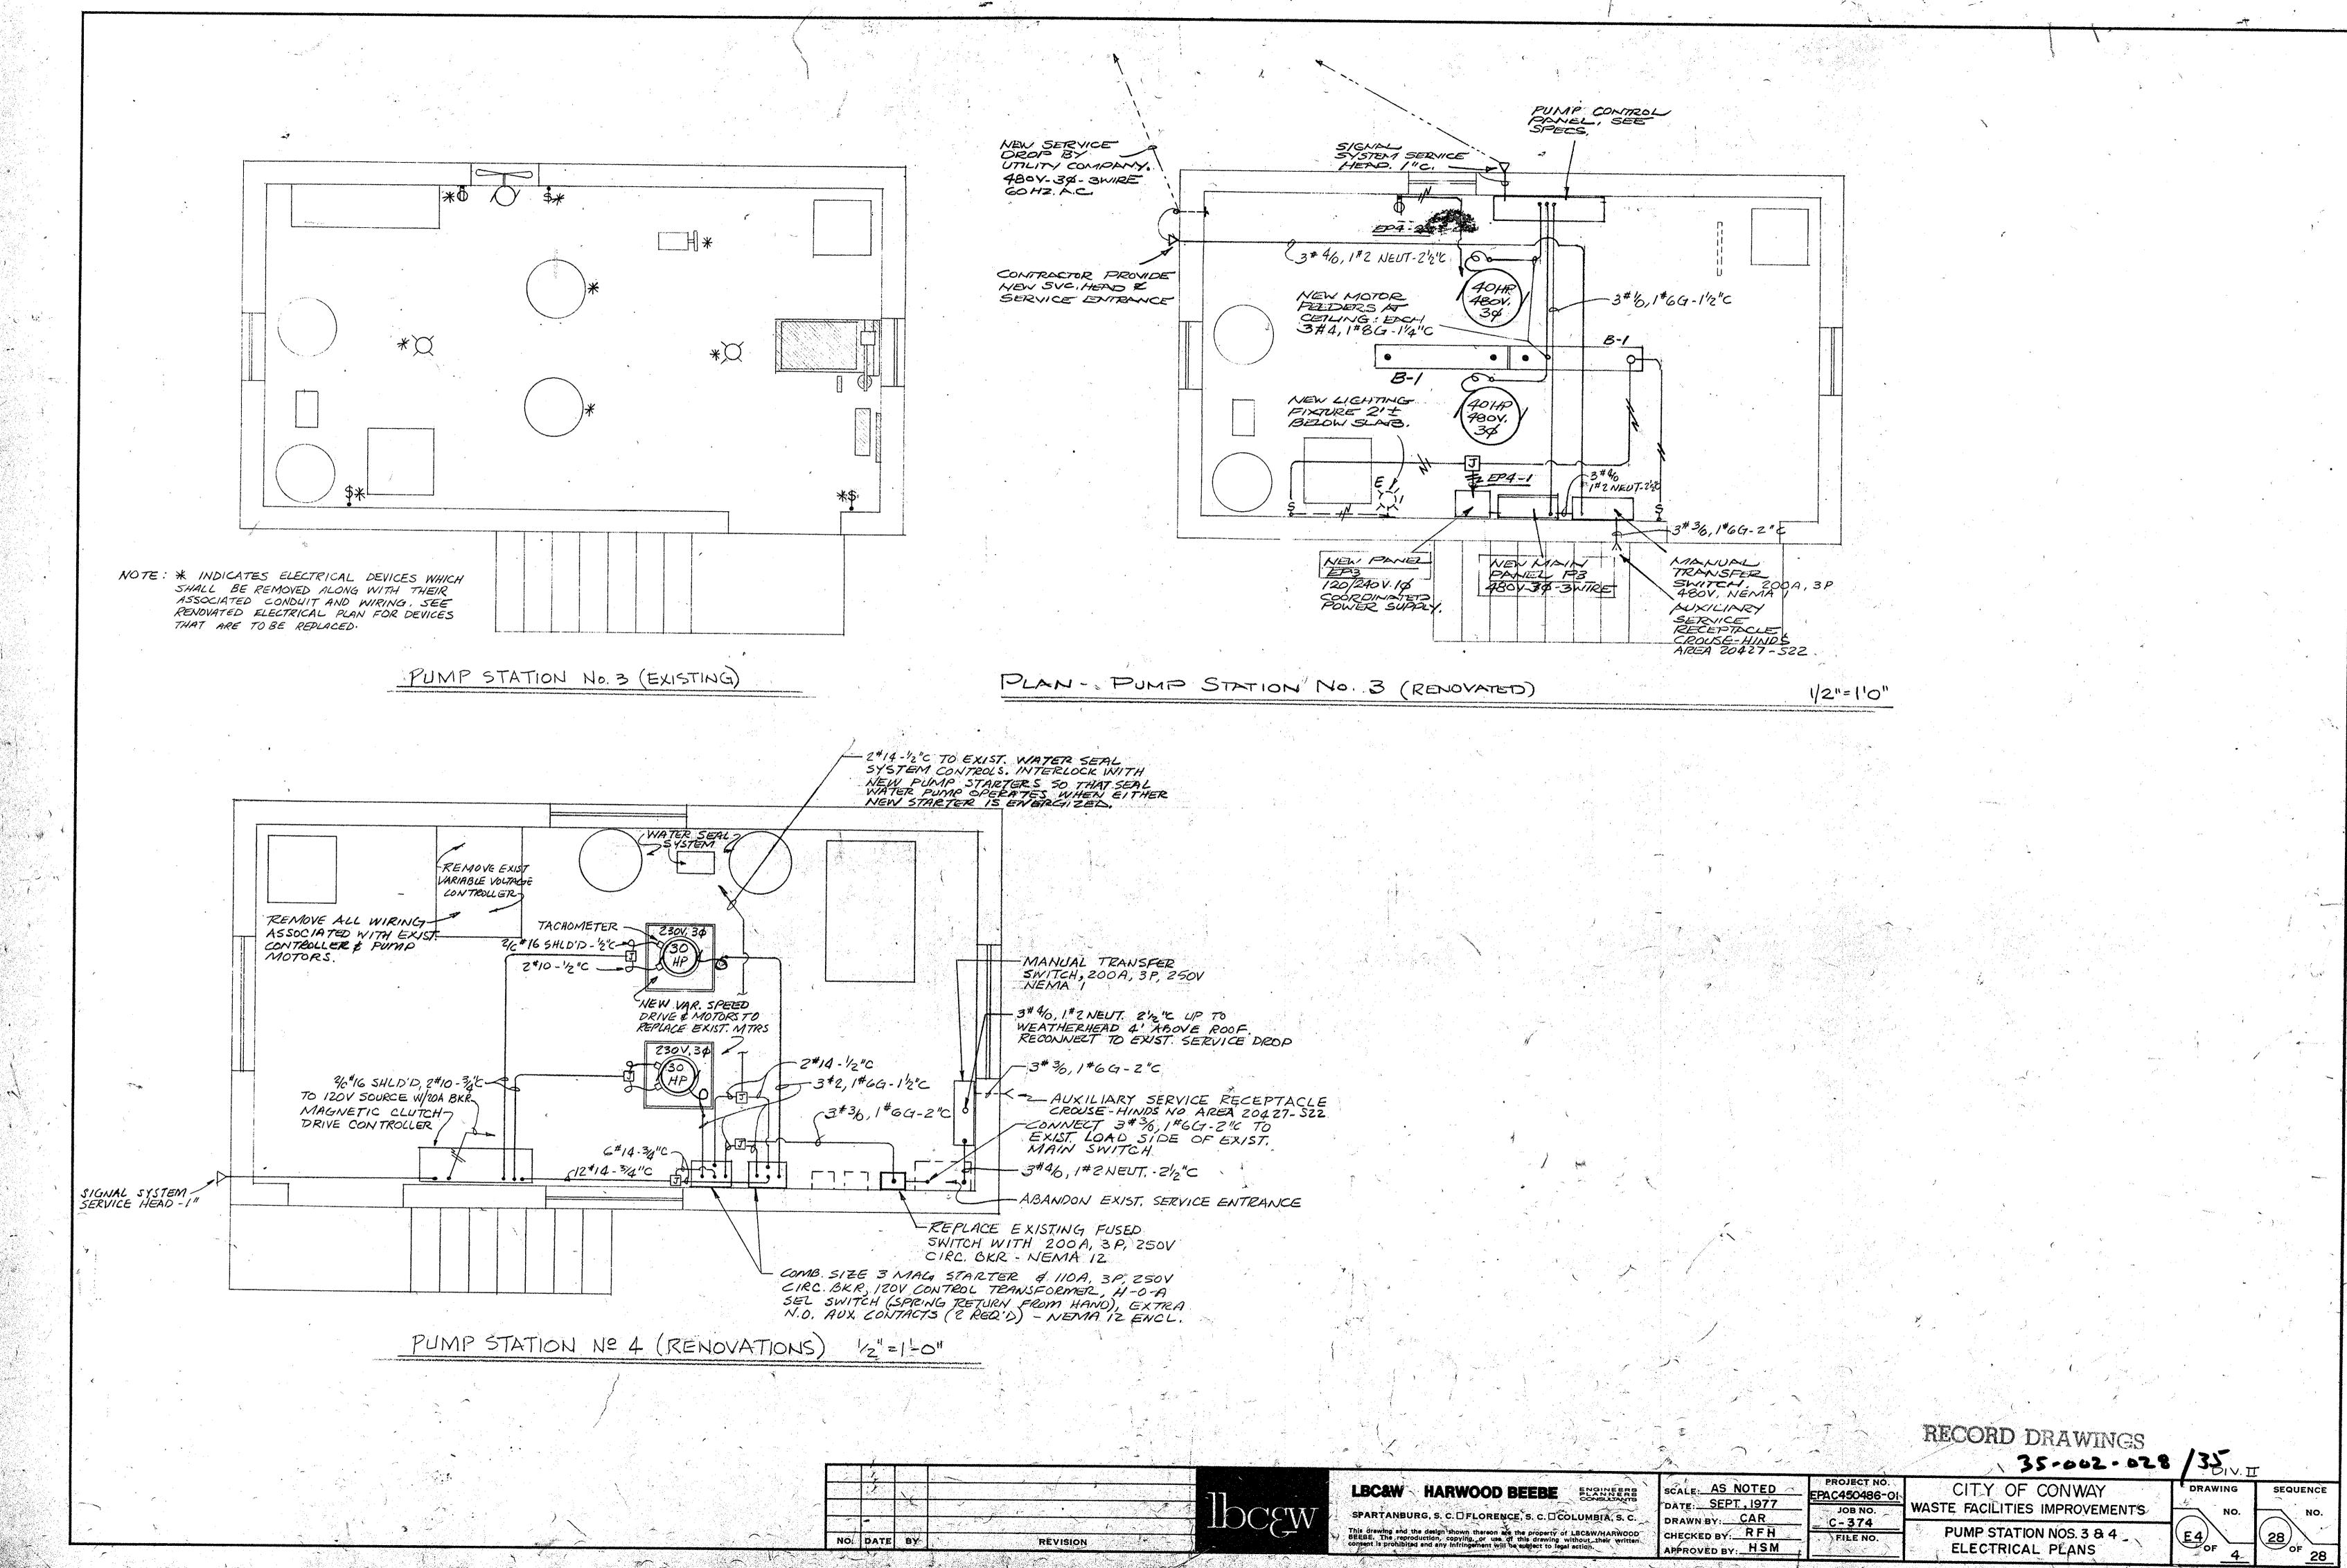

22-11-03

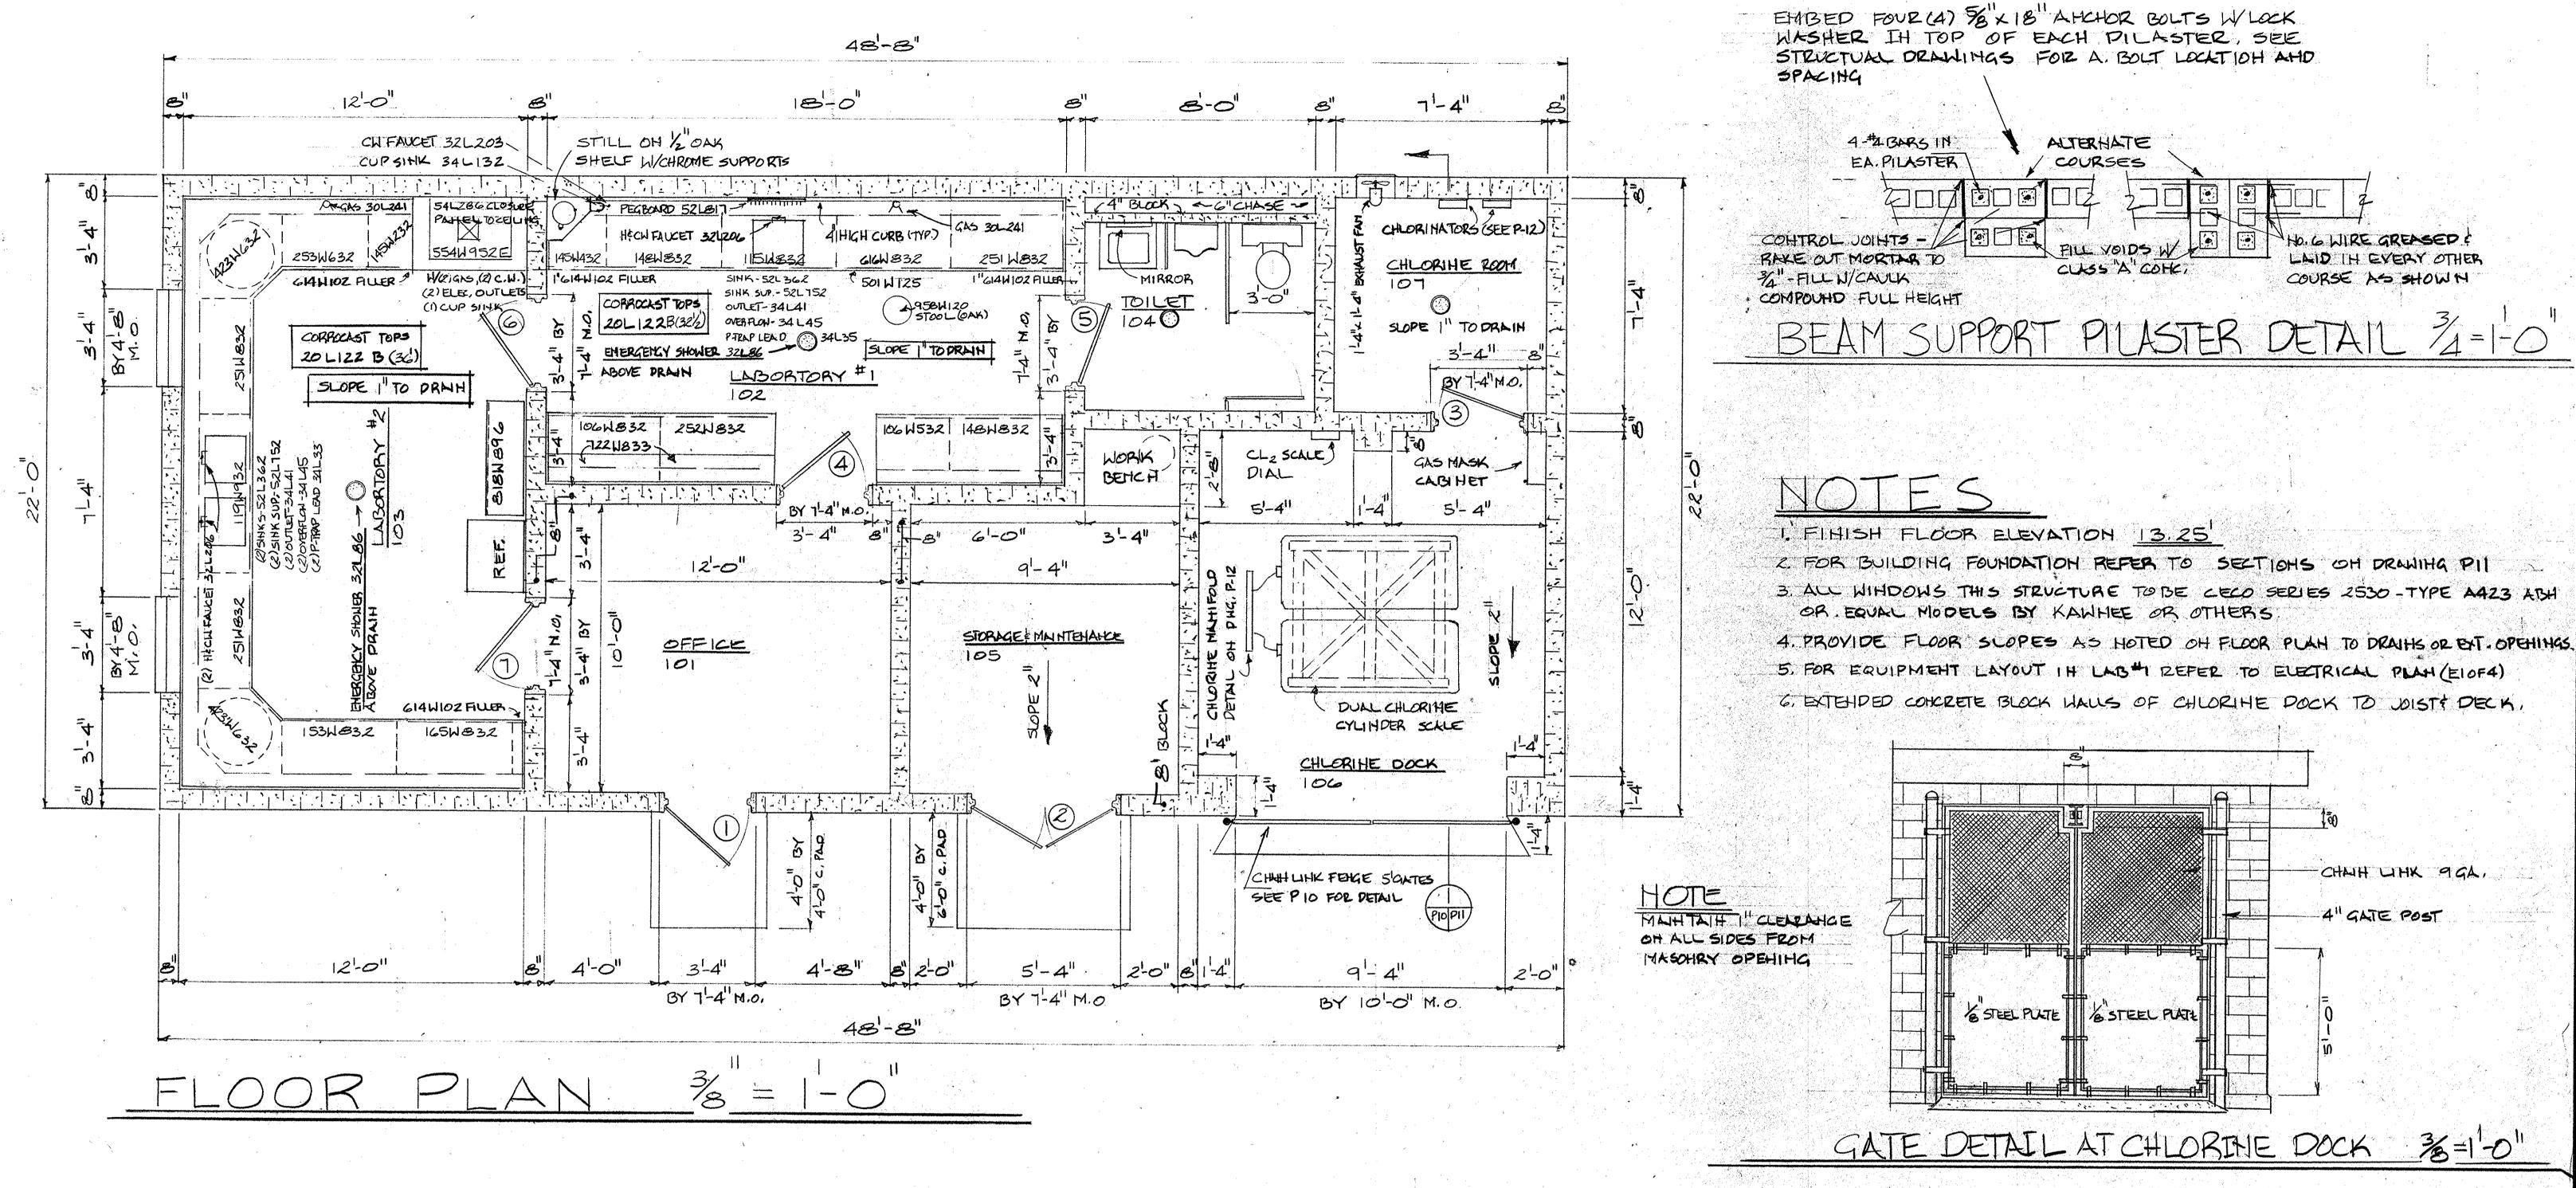

Mr. 11 m engymenydmanadousea.		FINISH C	SCHEDULE		
HO.	AREA	HALLS	FLOOR	BASE	CEILINGS
101	OFFICE	PANHTED CONCRETE BLOCK	VINYL 45BESTOS TILE	4"VIHYL COVE	ACOUSTICAL TILE (244)
102	LAB#1	PAINTED CONCRETE BLOCK	YINYL ASBESTOSTILE	4 VINYL COVE	ACOUSTICAL TILE (21441)
103	L/38#2	PAINTED CONCRETE BLOCK	YINYL &BESTOS TILE	4 VINYL COVE	ACQUISTICALTILE (244')
104	TOILET	PAINTED CONFRETE BLOCK	YINYLASBESTOS TILE	4ºVINYL COYE	ACOUSTICALTILE (21+41)
105	STOR HANN.	PAINTED CONCRETE BLOCK	CONCRETE		ACOUSTICAL TILE (21441)
106	CHLORHED.	PAINTED CONCRETE BLOCK	CONCRETE	And the second s	PAINTED BAR JUIST & DECI
101	CHLORIHER,	PAINTED CONCRETE BOCK	CONCRETE		PAINTED PLYWOOD

NOTE

REFER TO SPECS FOR FIHISHES COLOR, SYTLE, NO. OF COATS & TEXTURE.

DOOR SCHEDULE									
HO,	SIZE	TYPE	DESIGH	FRAME	HARD WARE				
	3-0"+7-2" 134"	П	G	834" STEEL	HIHGES SERIES 643A-413B, CLOSER SERIS 1230, LOCKSET SERIES 1983				
2	5047-24134"		V		HINGES SERIES 643A-41313, LOCKSET SERIES 1983, DOLE HG WSTRIKE #2152				
3	3-0×7-2×134"		9	8¾"STEEL	HIHGES SERIES (43A-4BB, LOCKSET SERIES 1902				
4	3-04 7-24 134"	<b>1</b>	9	834"STEEL	HIHGES SERIES 643A- 48B, LOCKSET SERIES 9720				
5	3-047-214134"	エ	LT	834"STEEL	HINGES SERIES 643A-4BB, LOCKSET SERIES 9185B, LOUVER 121418"				
6	3-04724134"	_ <b>I</b>	ৰ	8兆"STEEL	HINGES SERIES 643A-4BB, LOCKSET SERIES 9720				
.7	3-04-1-24-13/	Į	৭	8%"STEEL	HINGES SERIES 643A-4 BB, LOCKSET SERIES 9720				

\* CATLOG DATA FROM FENESTRA, EQUAL MODELS BY CECO OR EQUAL

RECORD DRAWINGS

SEAL:	ENG	ASSOCIATES, INC. NEERS BIA, S. C.	CITY OF COHWAY, S.C. WASTE FACILITIES IMPROVEMENTS		SHEET NO.
# No. 6114 € T	DESIGNED	REVISIONS			of 3 SHEETS
	TRACED		CONTROL BUILDING	PLAH & SECTIONS	
M LONG.	CHECKED		SCALE: HOTED	DATE	FILE NO. 22-11-03

