# MYRTLE BEACH WWTP PIPING MODIFICATIONS

HORRY COUNTY, SOUTH CAROLINA



### **RECORD DRAWING**

OCTOBER 2012


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OCTOBER 2012

JOB NO. 31001

11x17 DWGS. ARE TRUE HALF SCALE



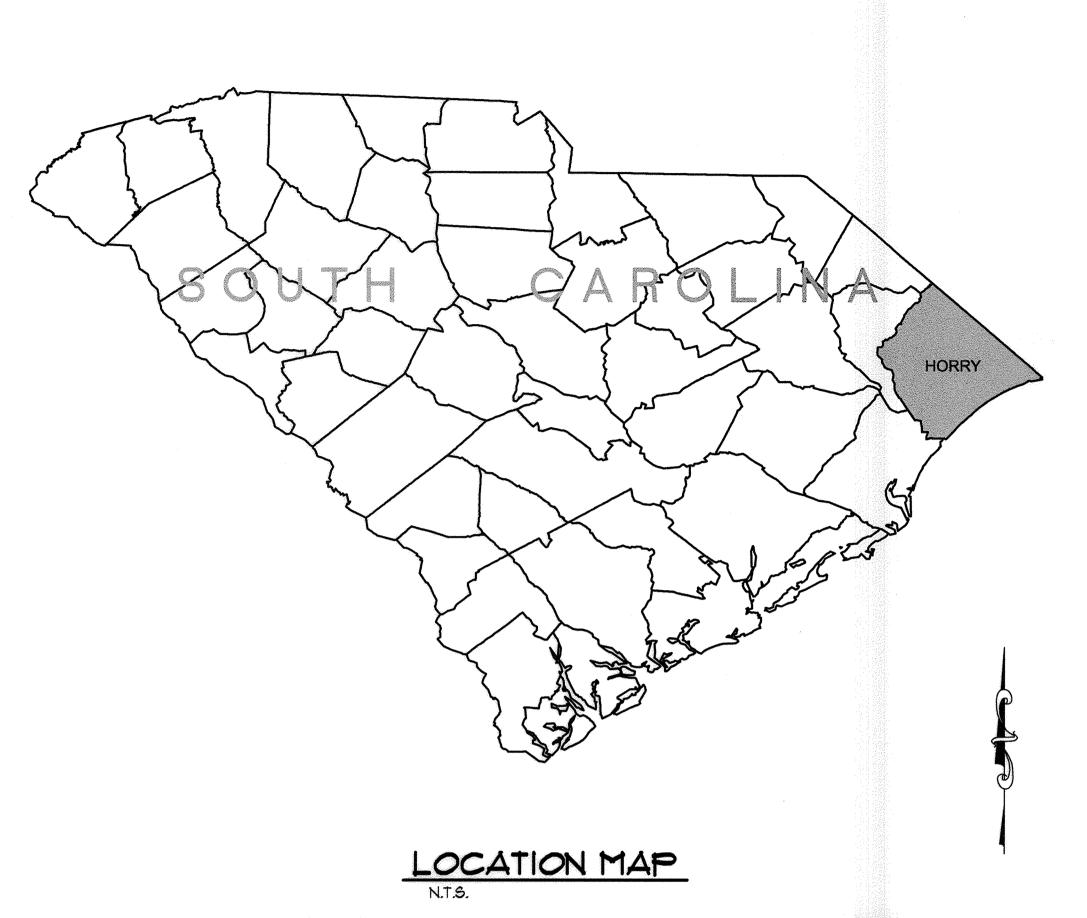

Of: \_\_\_ Version: \_\_5

AS SHOWN

OCT 2012

GENERAL NOTES

# GENERAL CONSTRUCTION ABBREVIATIONS


NUMBER OR POUND DIAMETER INVERT LESS THAN JOINT LESS THAN OR EQUAL TO GREATER THAN LONG LEG OUT POUND ANCHOR BOLT LG LONG ABOYE FINISHED FLOOR LOW POINT ADDITIONAL MECHANICAL JOINT ALUMINUM OR ALUM MATL. MATERIAL APPROXIMATE(LY) ARCHITECTURAL MAXIMUM BENCH MARK OR BEAM MANUFACTURER BLOCK WALL CAST IRON MINIMUM C/C CENTER TO CENTER MOUNTING NONPOTABLE WATER CAPACITY NOT TO SCALE CIRCUMFERENCE CLEARANCE ON CENTER CLR. CL2 CHLORINE OPENING CLARIFIER OXIDATION CHEMICAL PLAIN END COLUMN CONCRETE CONSTRUCTION CONTINUOUS CONTRACTOR POLYVINTL CHLORIDE CONCRETE WALL REINFORCED CONCRETE PIPE DIAMETER DIAMETER RETURN ACTIVATED SLUDGE DUCTILE IRON PIPE REDUCER DISCHARGE REINFORCING OR REINFORCED DOWELS EACH FACE STAINLESS STEEL EXPANSION JOINT EFFLUENT ELEVATION SPACES EQUAL EQUIPMENT STANDARD EXISTING STEEL EXPANSION STAINLESS FLARED END SECTION SLAB WIDTH FIBERGLASS SIDE WALL DEPTH REINFORCED PLASTIC TOP OF FIG FIGURE TCJ,CJ TYP. CONTROL JOINT FINISHED CONSTRUCTION JOINT FLANGE THRD THREAD(SXED) FLOOR TRICK TRICKLING FOOTING GALV GALVANIZED U.O.N. UNLESS OTHERWISE NOTED HARDWARE VERTICAL HOOK WELDED WIRE FABRIC HORIZONTAL WITH HIGH POINT WITHOUT W/O WASTE ACTIVATED SLUDGE

### SECTION/DETAIL LEGEND

DETAIL CALL-OUT AND DETAIL TITLE IDENTIFICATION

INSIDE DIAMETER

OUTSIDE DIAMETER

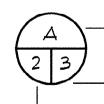


- DETAIL IDENTIFICATION LETTER (IN SAME STRUCTURE)

WATER LEVEL

SHEET NUMBER (IN SAME DISCIPLINE) WHERE DETAIL IS DRAWN.

SHEET NUMBER ON WHICH DETAIL CONDITION OCCURS. (DASH INDICATES CONDITION OCCURS ON MULTIPLE SHEETS.)

SECTION CUT SYMBOL (W/ARROW) OR TITLE IDENTIFICATION SYMBOL (W/O ARROW)

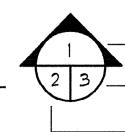


SECTION IDENTIFICATION NUMBER

SHEET NUMBER (IN SAME STRUCTURE) WHERE SECTION IS DRAWN.


SHEET NUMBER (IN SAME STRUCTURE) ON WHICH SECTION IS INITIALLY CUT.

# INDEX OF SHEETS


- **COVER SHEET**
- **GENERAL NOTES & INDEX**
- **EXIST. SITE LAYOUT**
- G-4 SITE LAYOUT
- EXIST. MANHOLE "A" DEMOLITION LAYOUT & SECTION & MODIFICATION SECTION
- G-5A EXIST. MANHOLE "B" LAYOUT & MODIFICATION SECTION
- G-6 EXIST. FLOCULATOR/ CLARIFIER DISTRIBUTION CHAMBER LAYOUT & PIPING DETAILS
- EXIST. JUNCTION CHAMBER "C" MODIFICATION LAYOUT
- THICKENED SLUDGE PUMP STATION NO. 1 LAYOUT & DETAILS
- G-8A THICKENED SLUDGE PUMP STATION NO. 2 LAYOUT & DETAILS
- METER VAULT NO. 1 LAYOUT & DETAILS
- G-10 MISCELLANEOUS DETAILS
- G-11 MISCELLANEOUS DETAILS
- ELECTRICAL LEGEND
- ELECTRICAL ENLARGED SITE PLAN
- ELECTRICAL EXISTING MCC P51 AND THICKENED SLUDGE **CONTROL PANEL NO. 1**
- ELECTRICAL THICKENED SLUDGE PS NO. 1, METER VAULT NO. 1 AND MISC. DETAILS

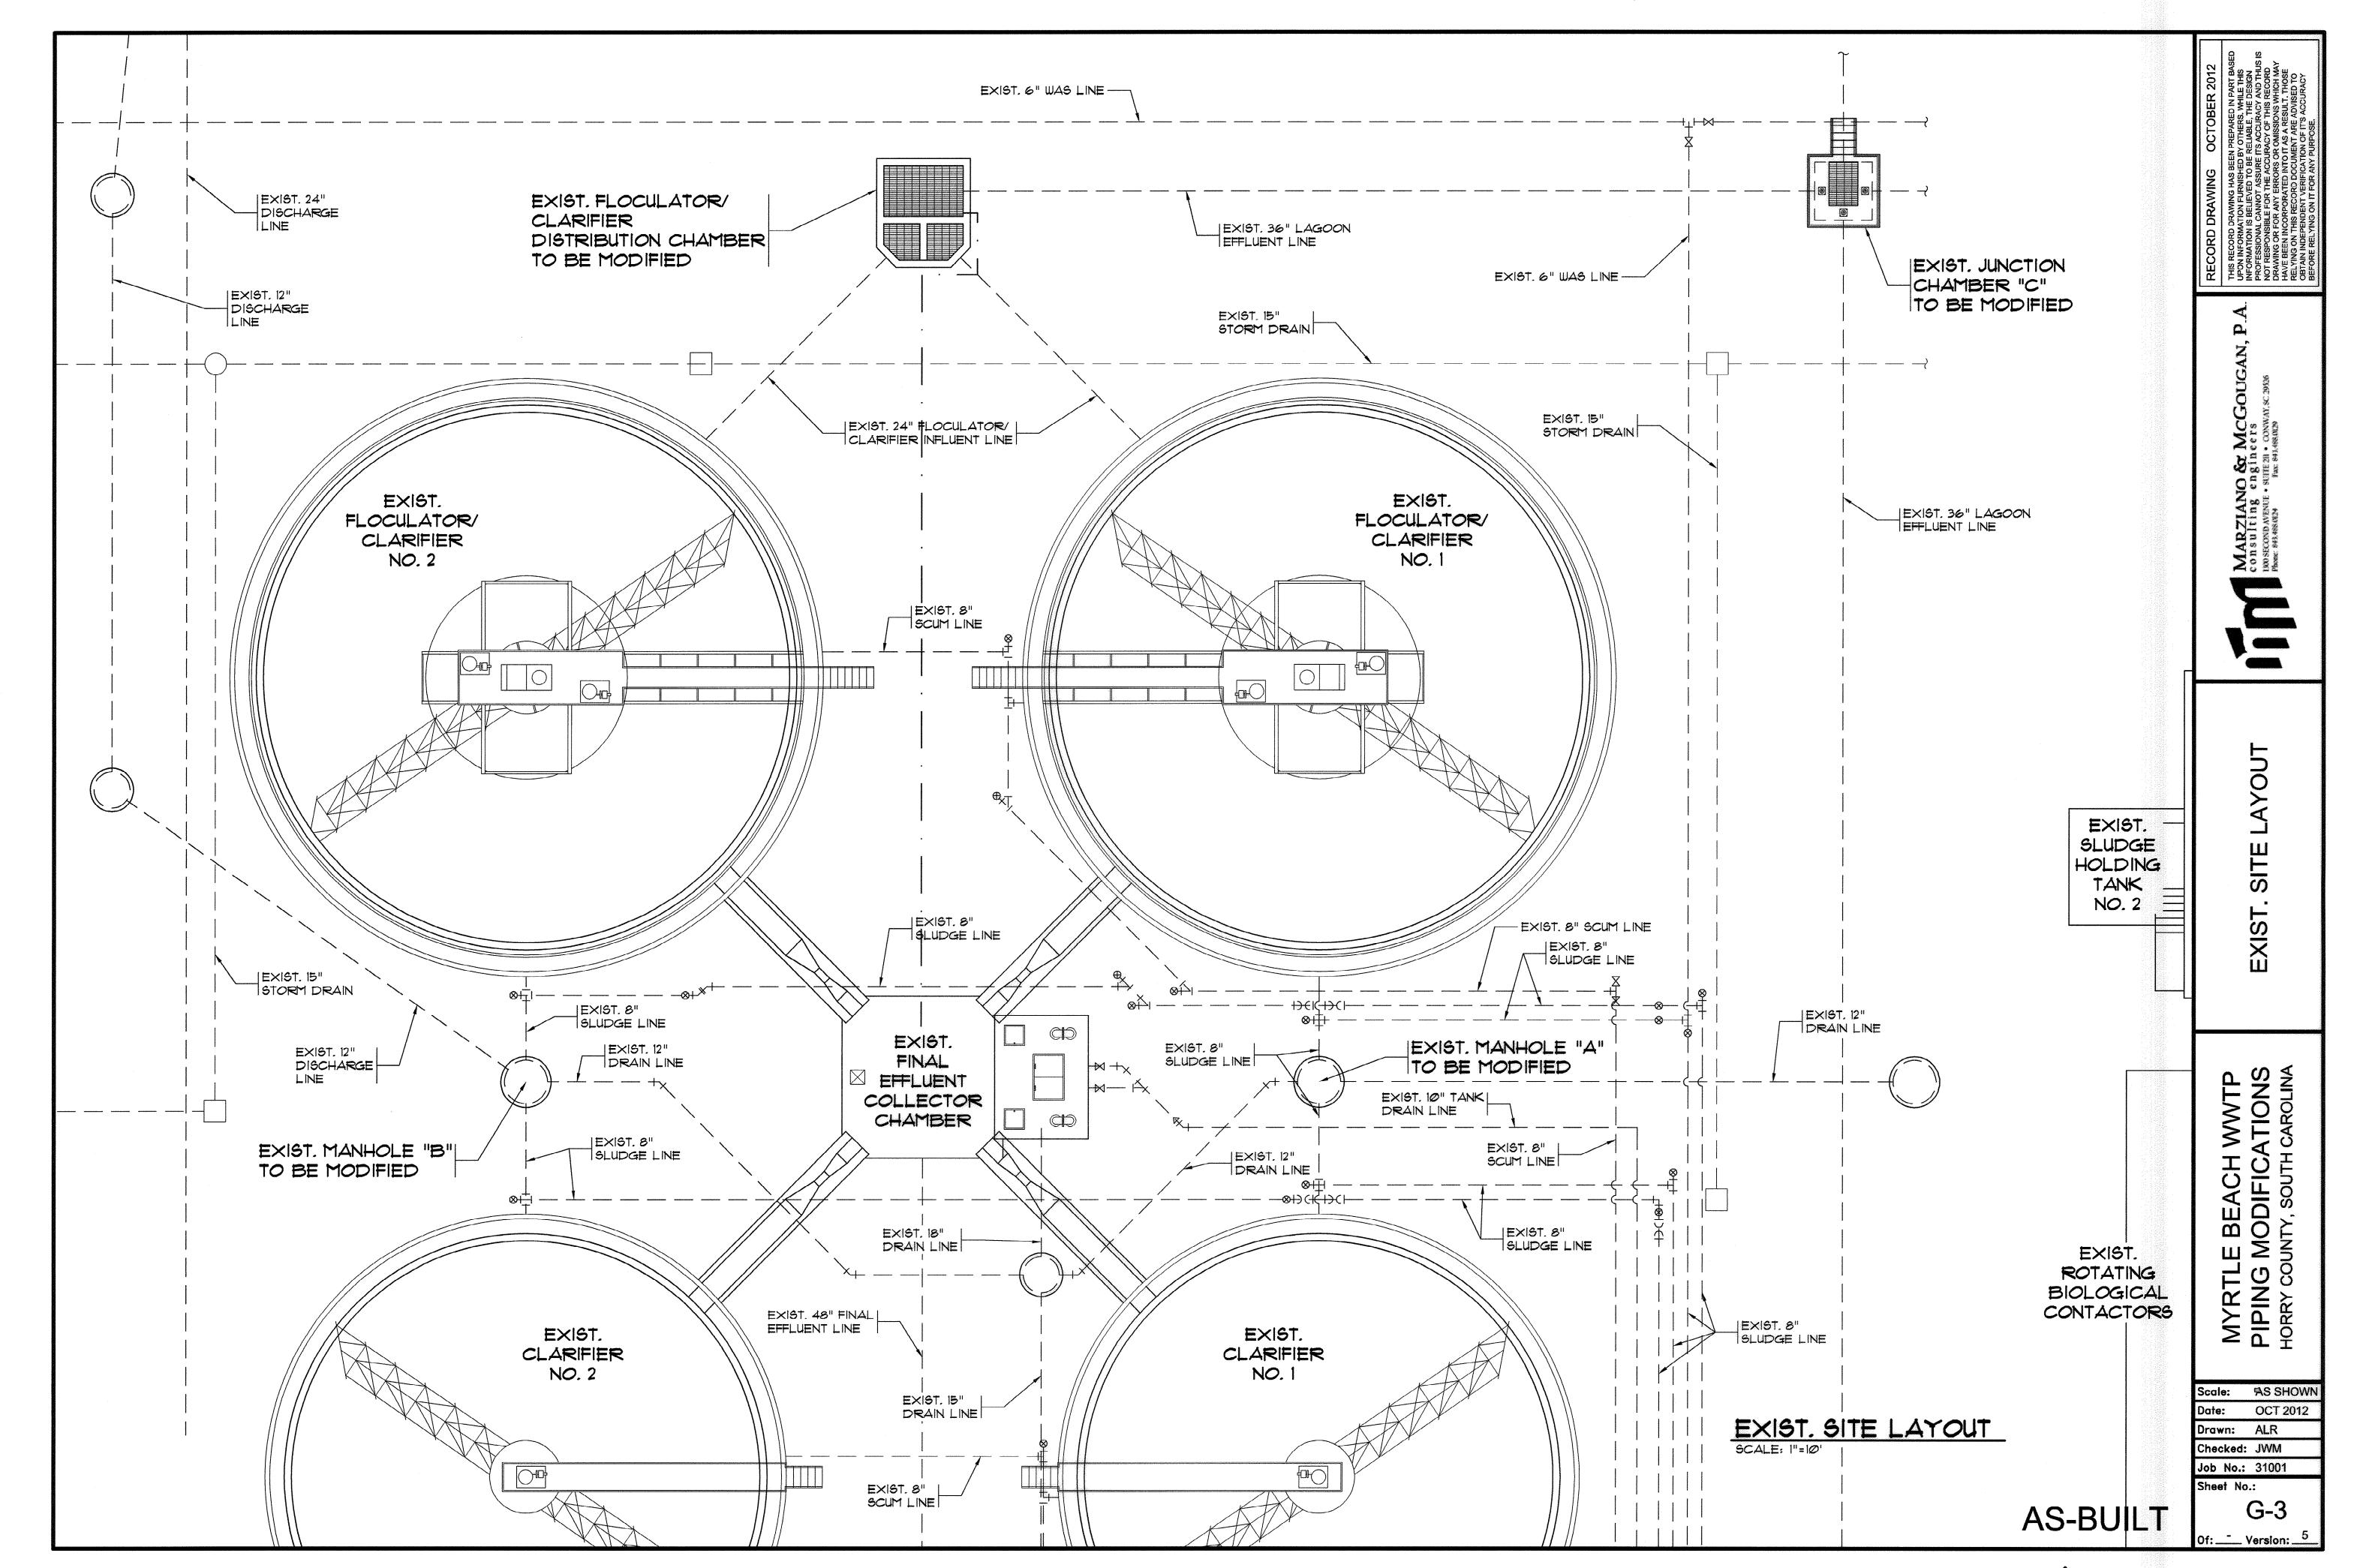

51-014-003/17

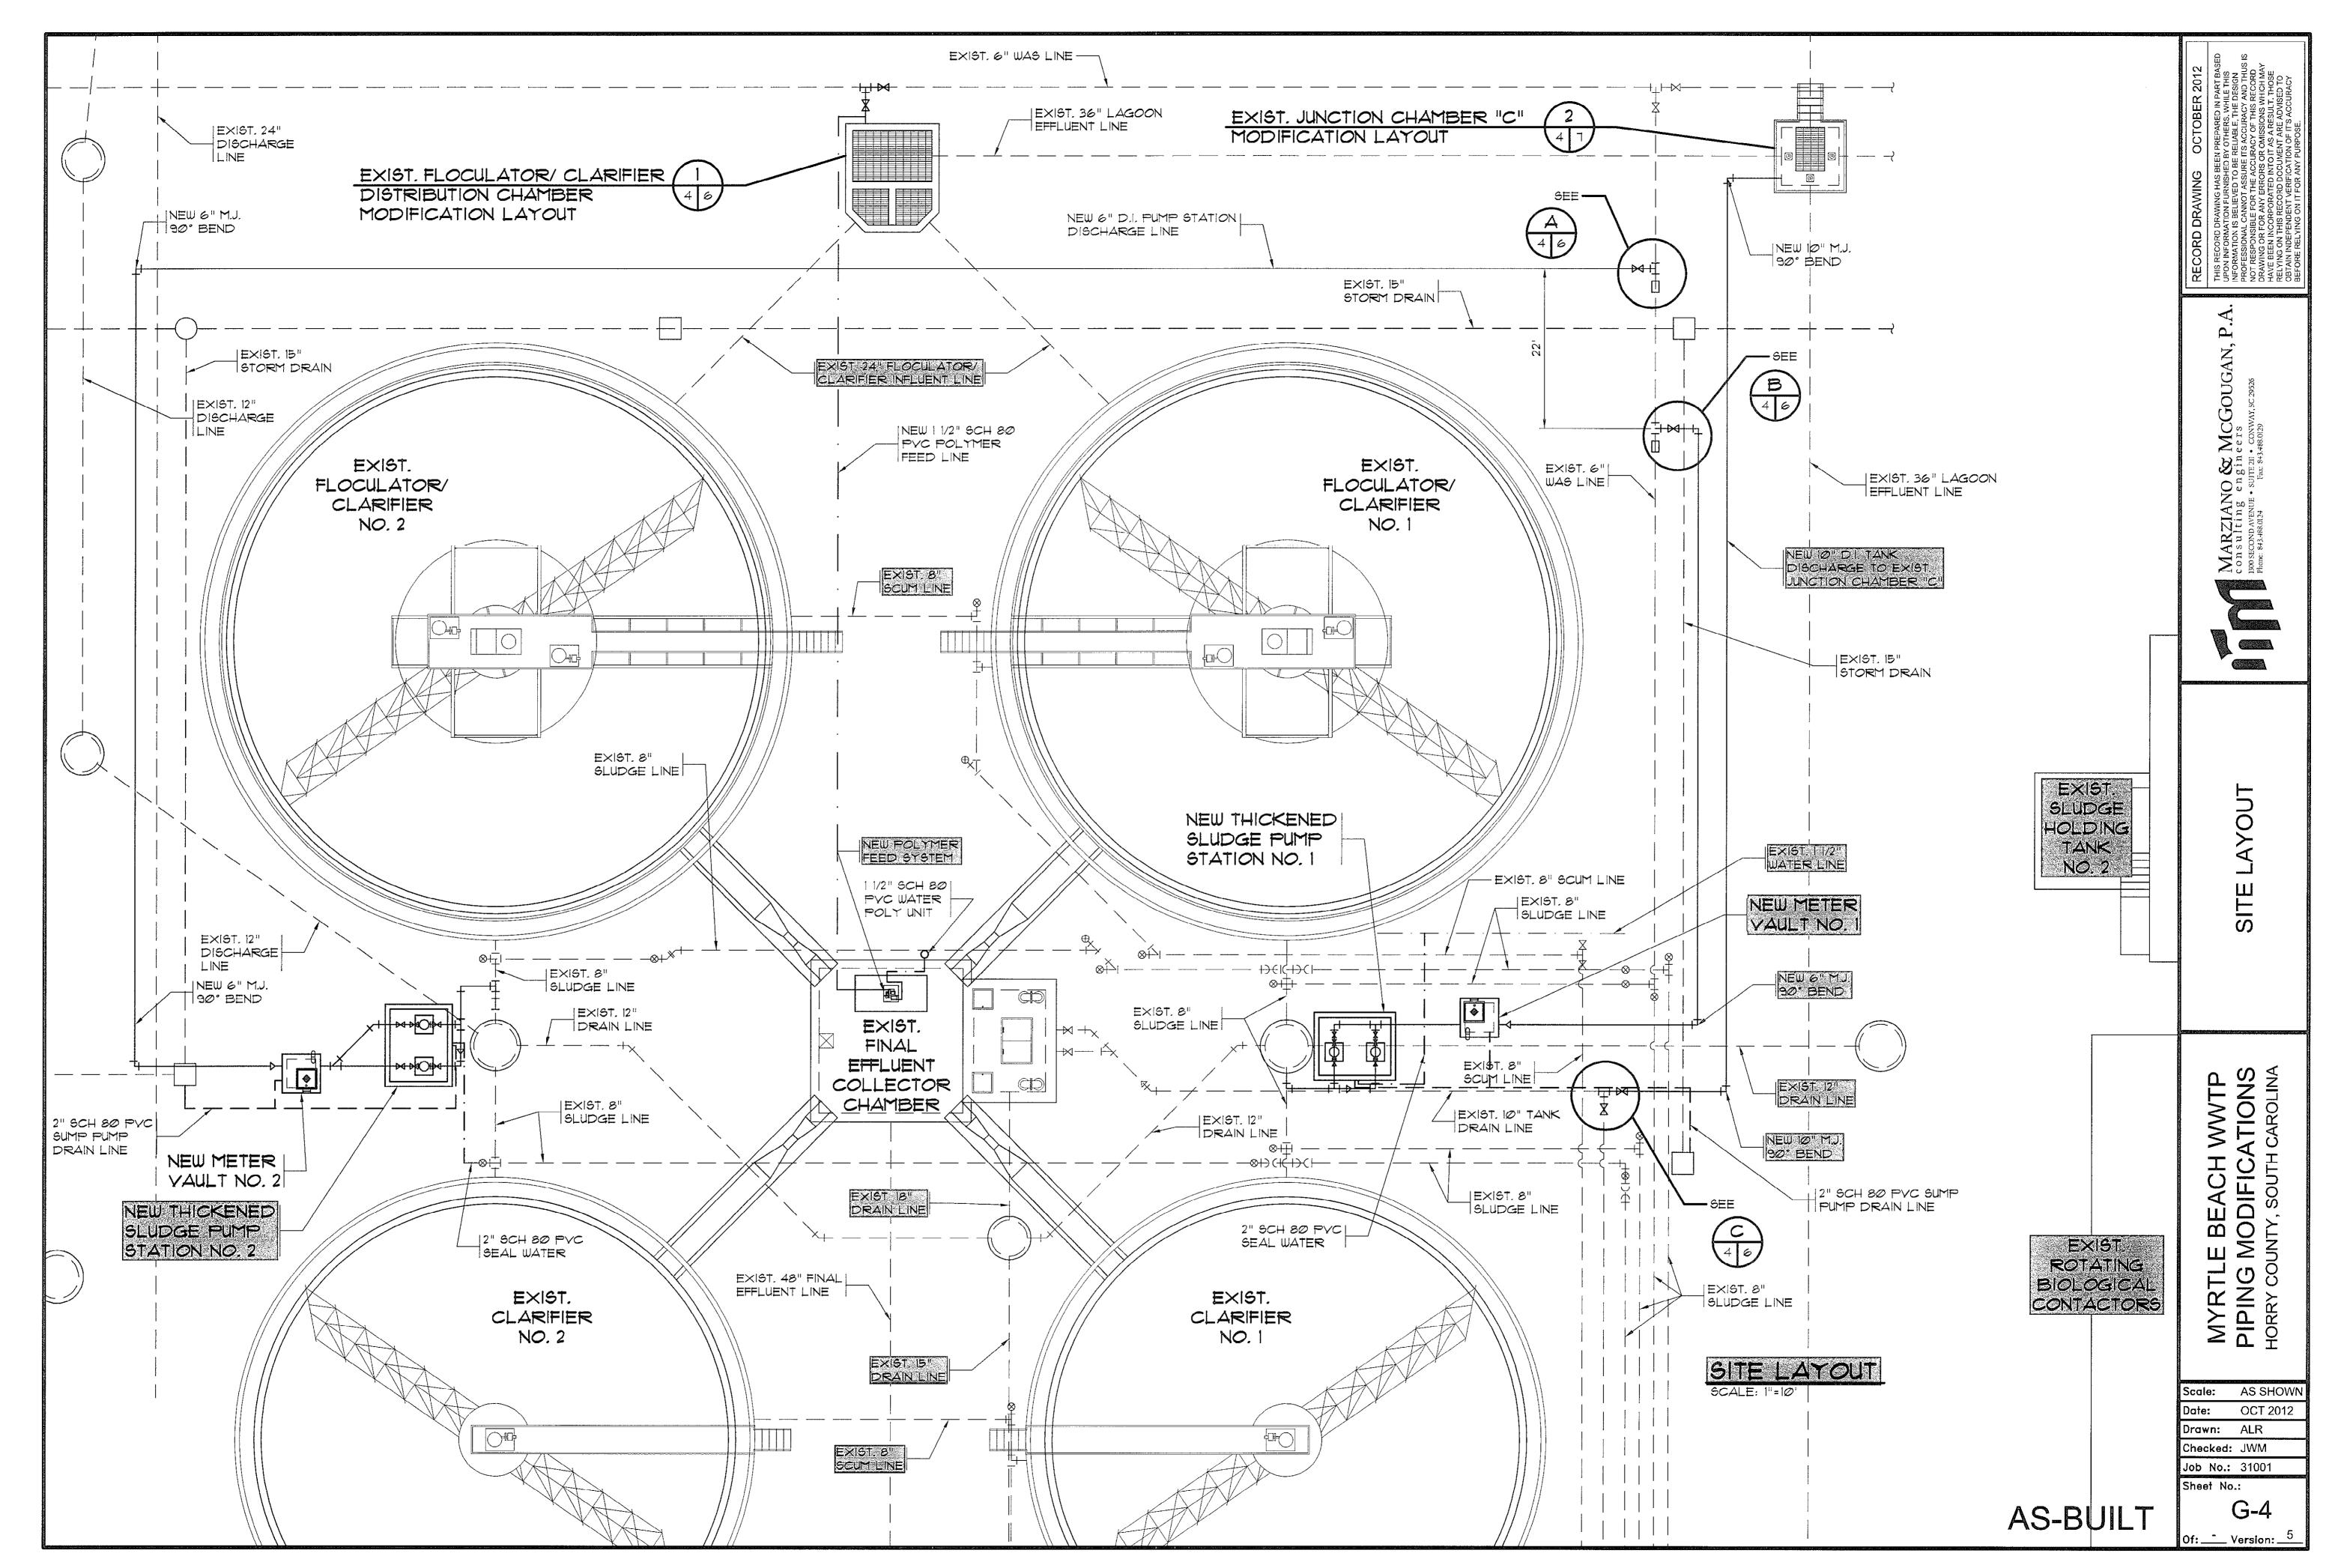


51-014-004 [17

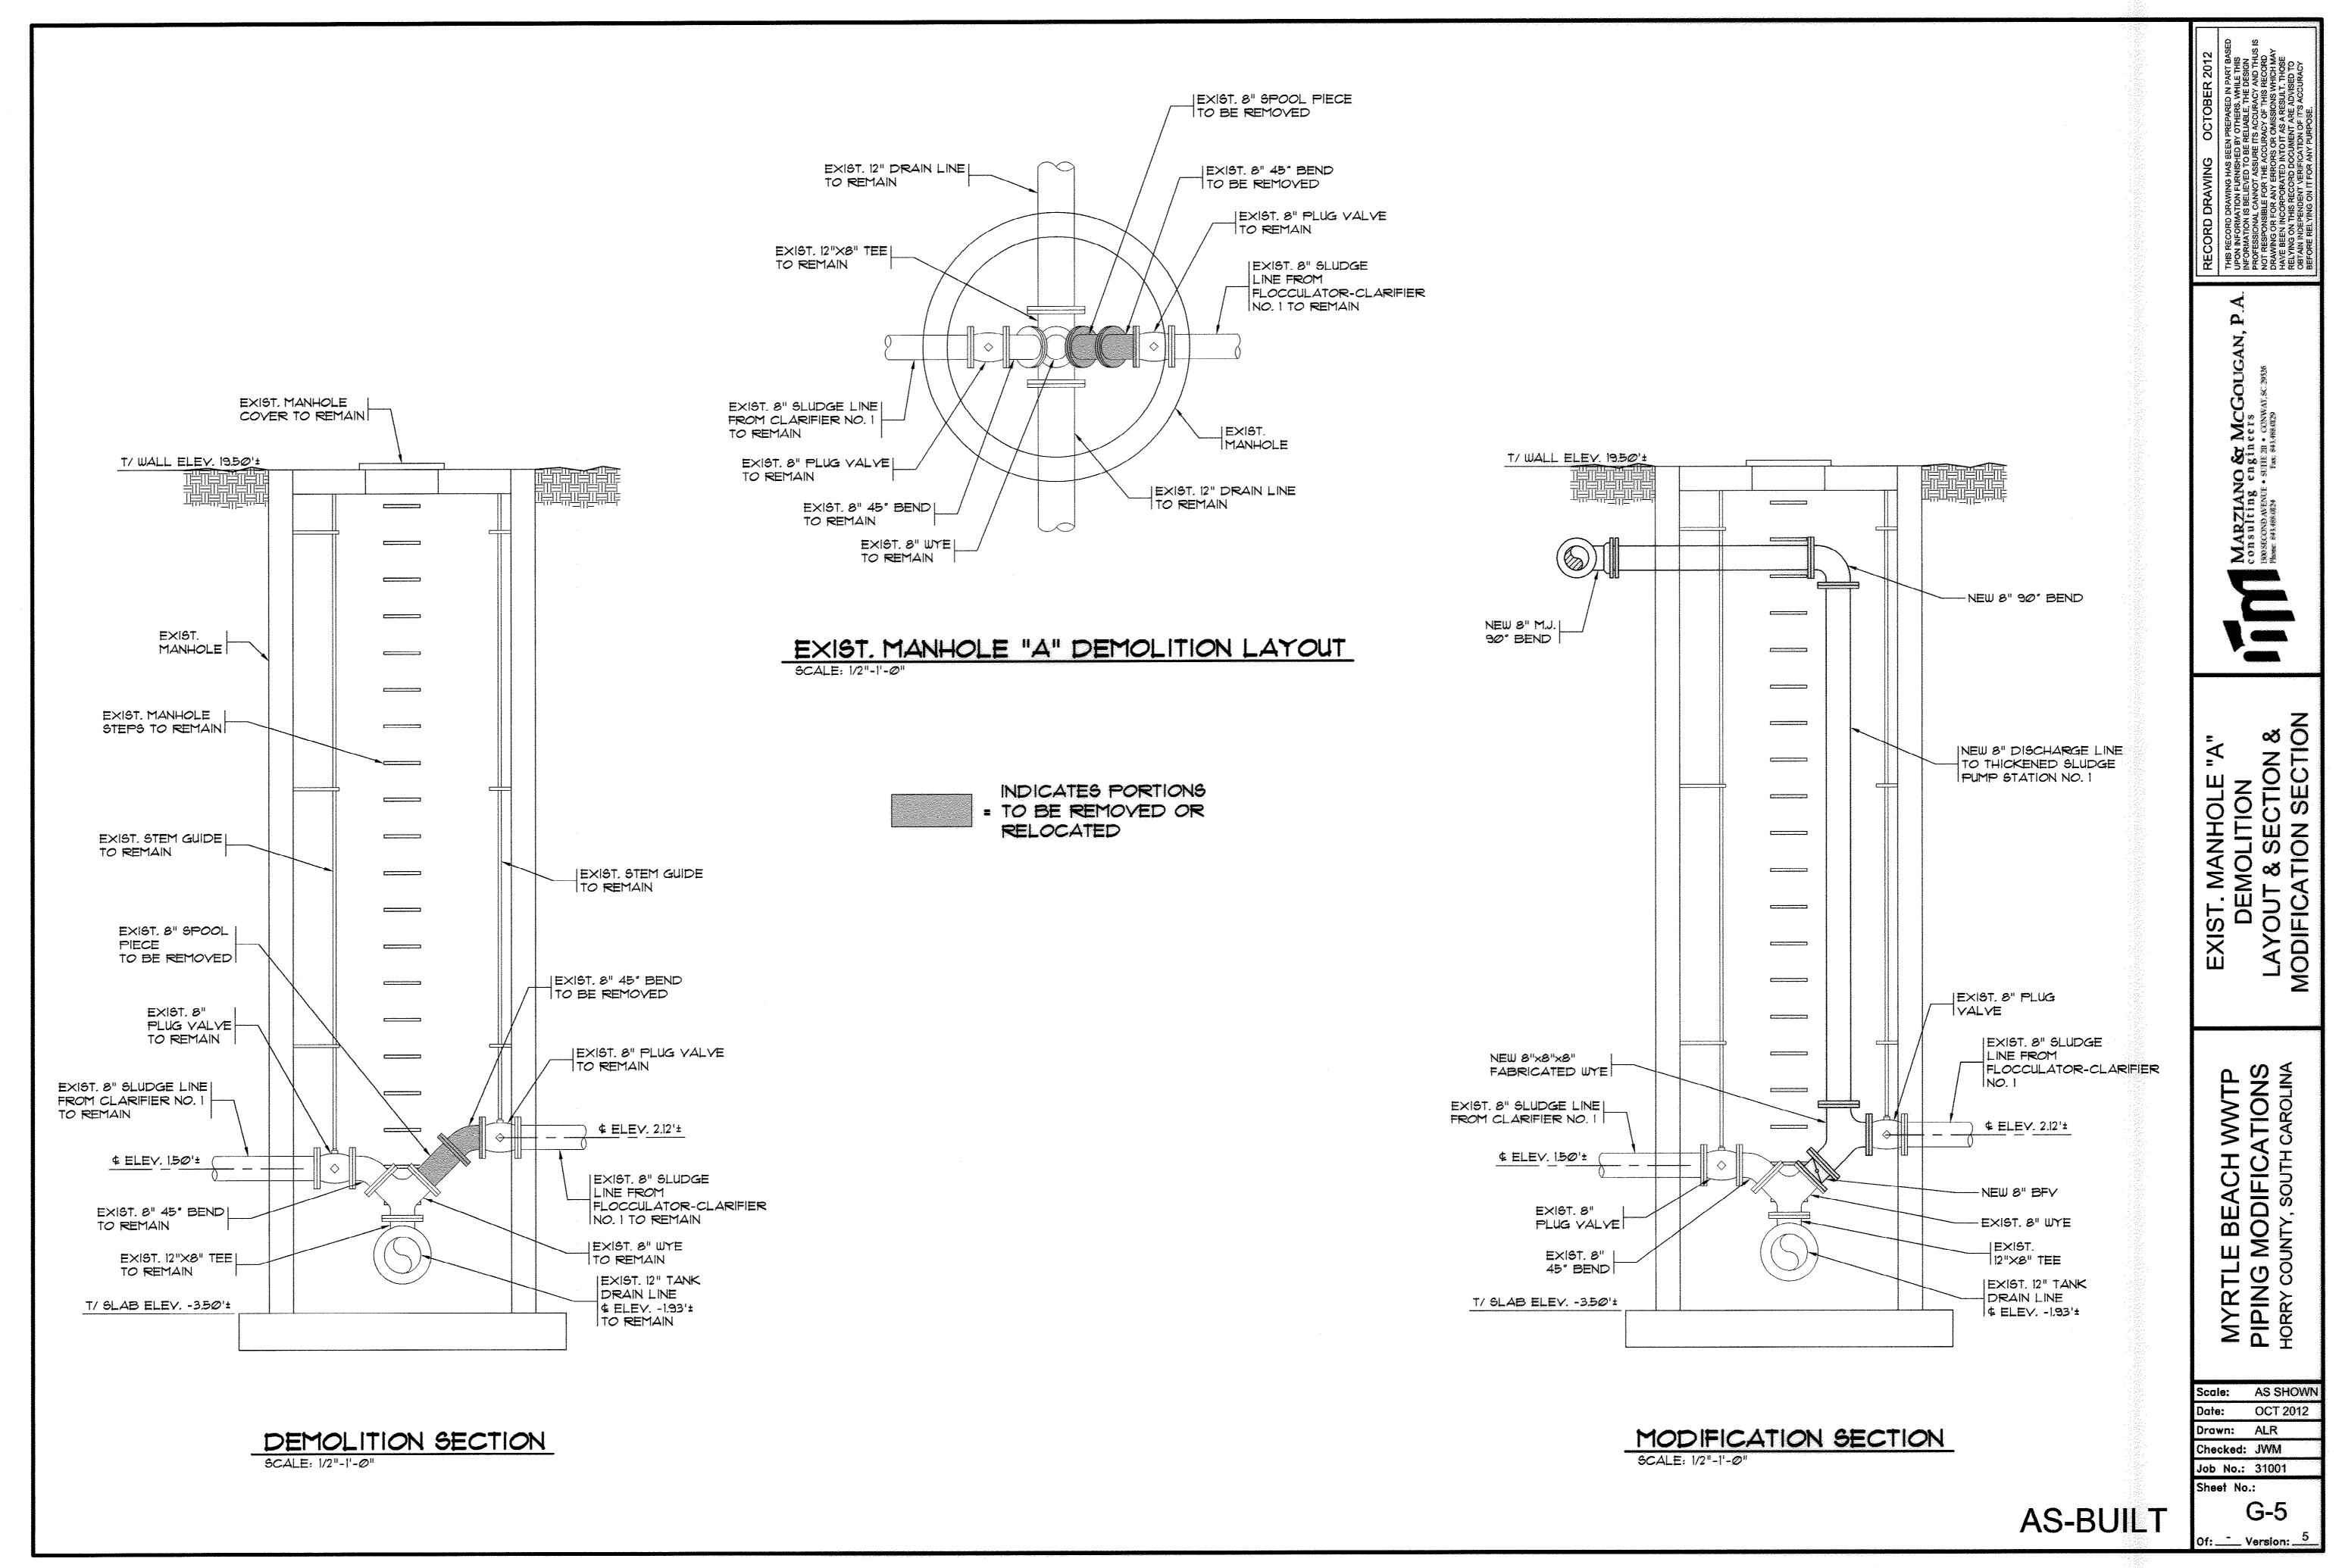


51-014-005/17

Of: \_\_\_ Version: \_\_\_\_5

**AS-BUILT** 

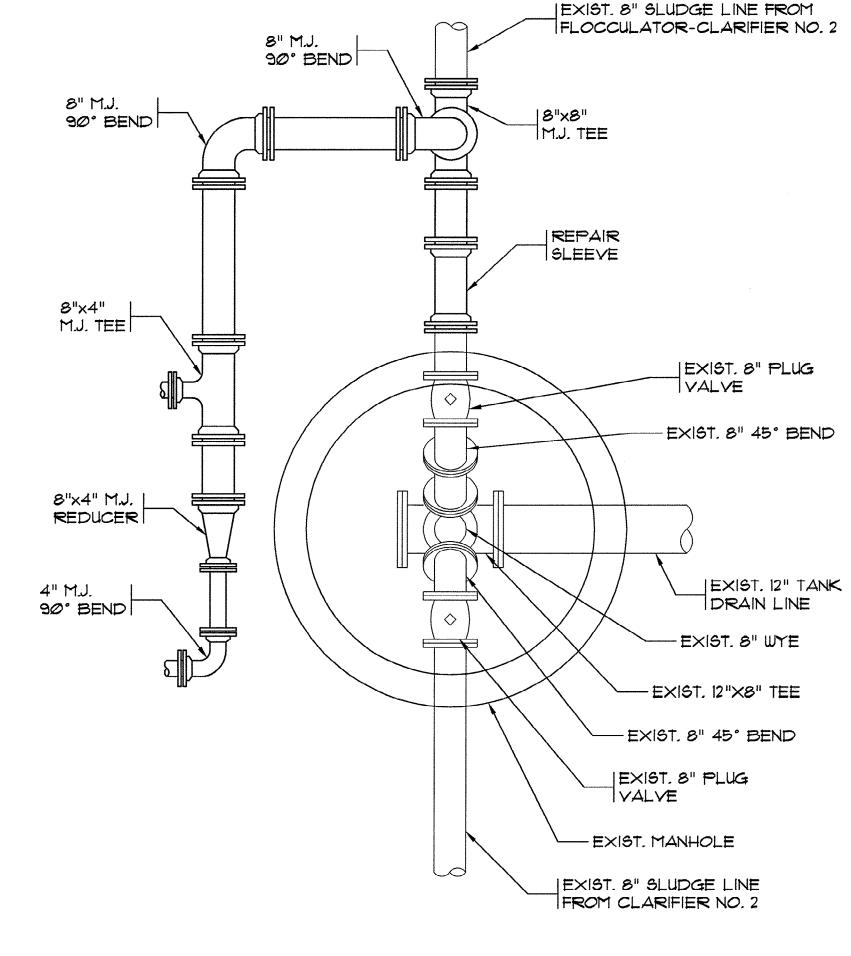


EXIST. MANHOLE "B" LAYOUT

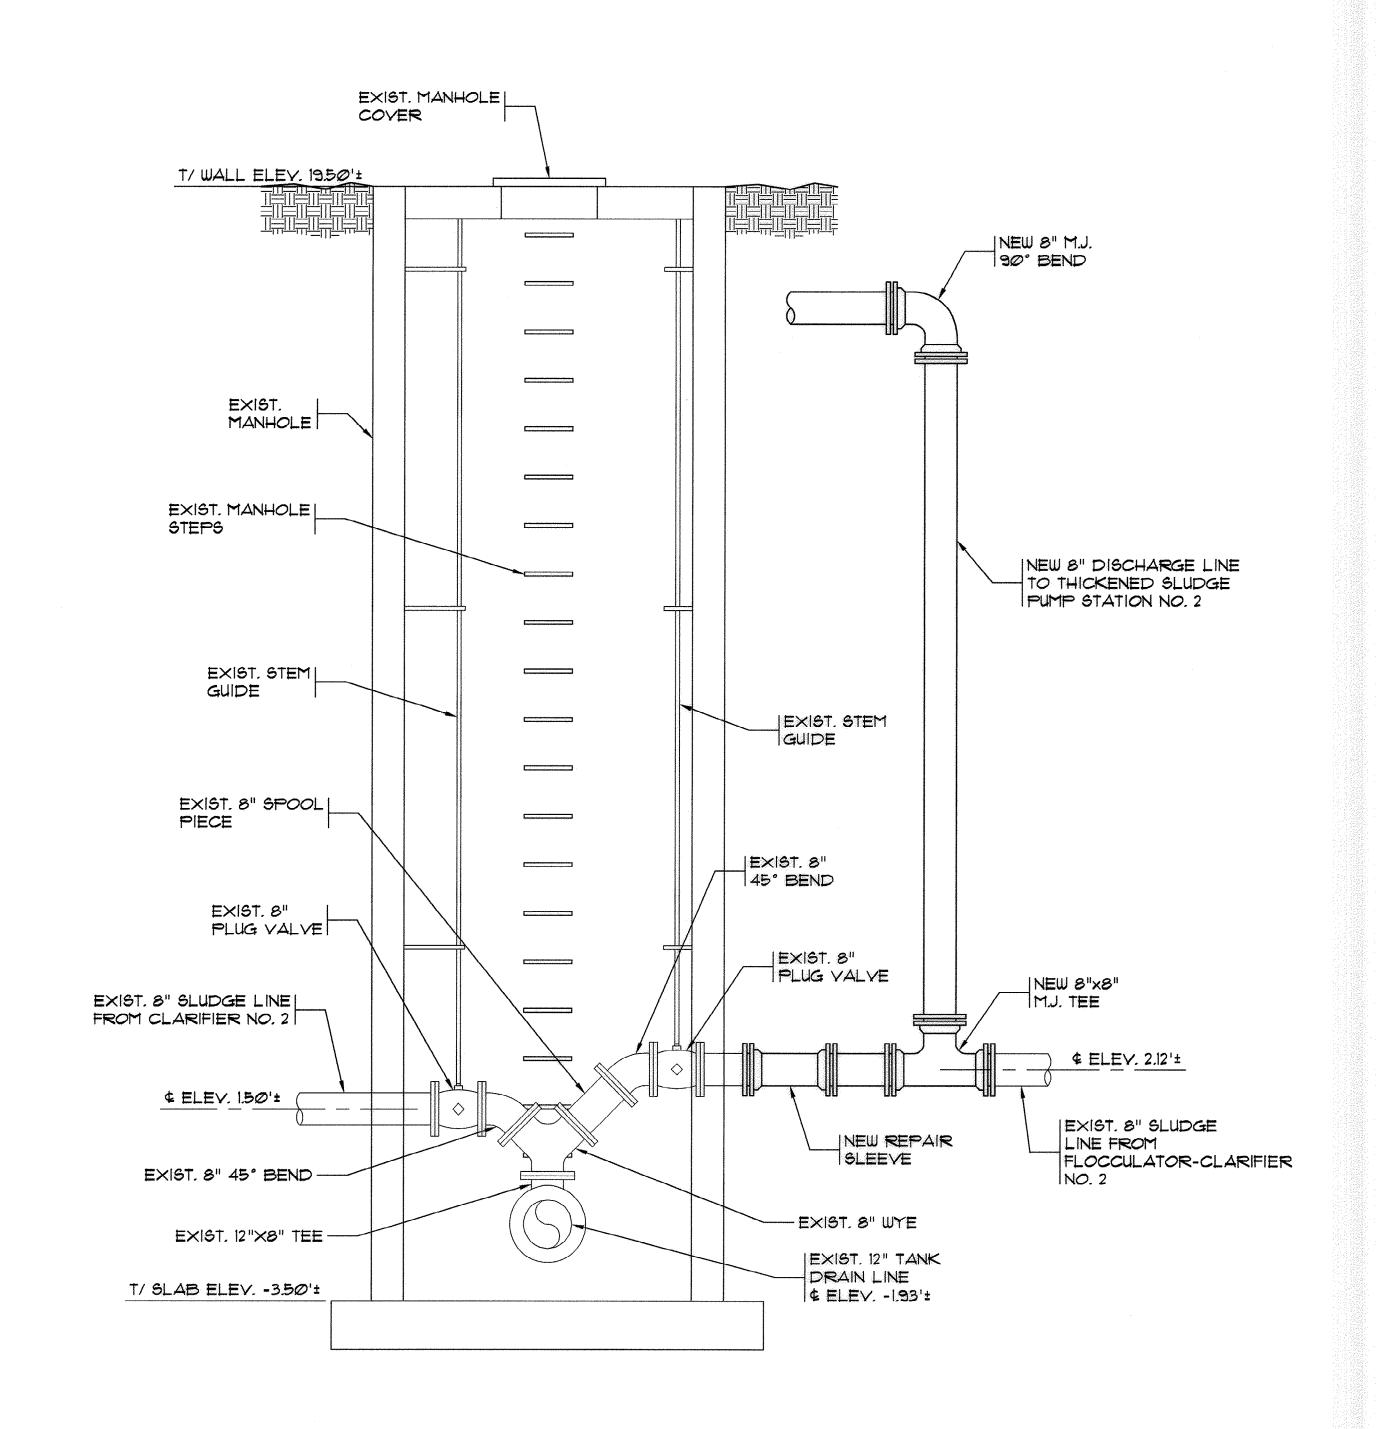



MODIFICATION SECTION
SCALE: 1/2"-1'-0"

Job No.: 31001
Sheet No.: **G-6** 


Of: \_\_\_\_ Version: \_\_5

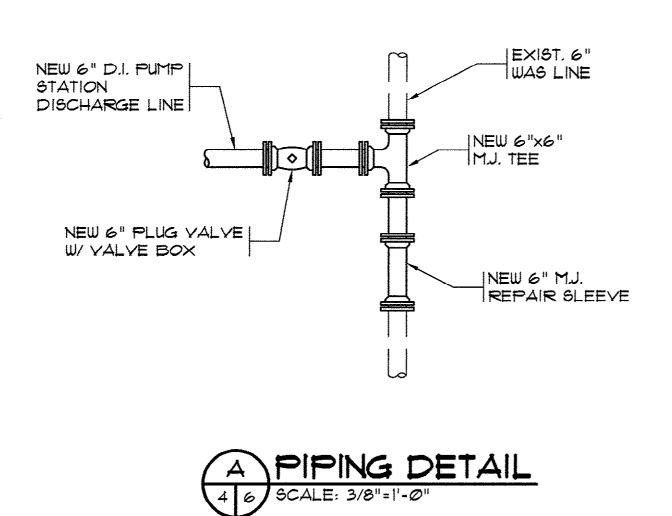

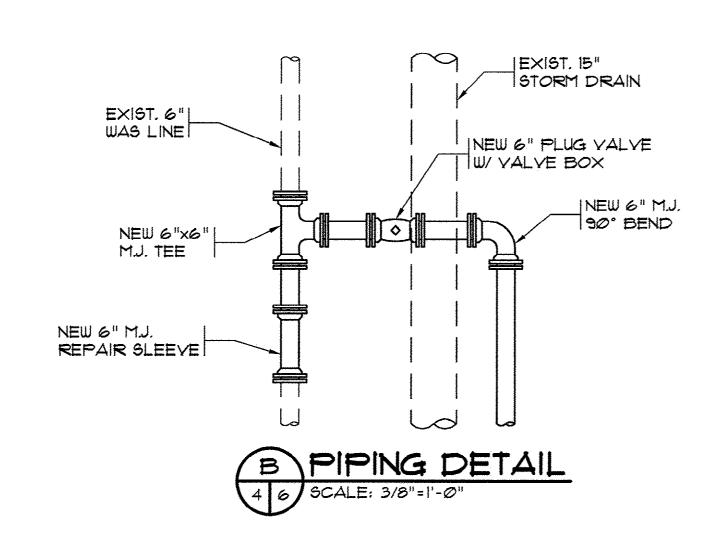

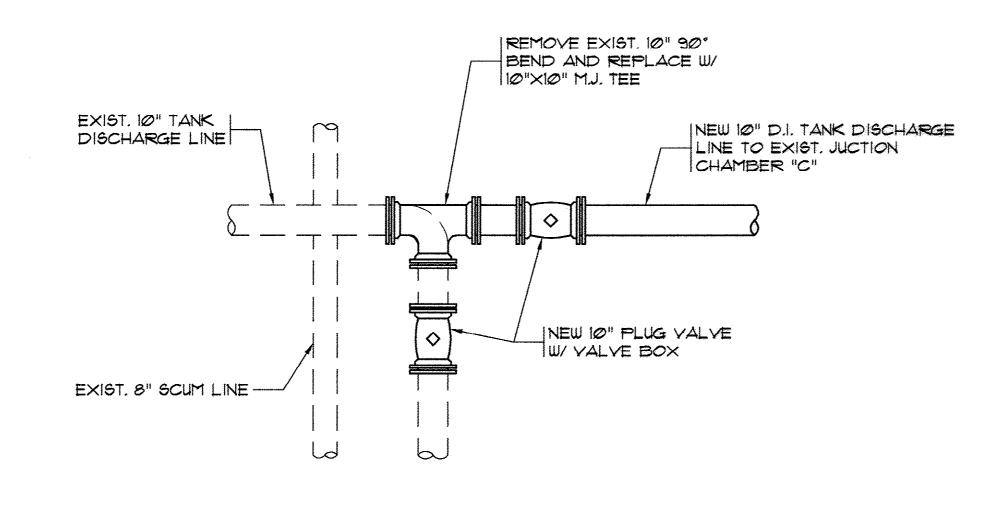




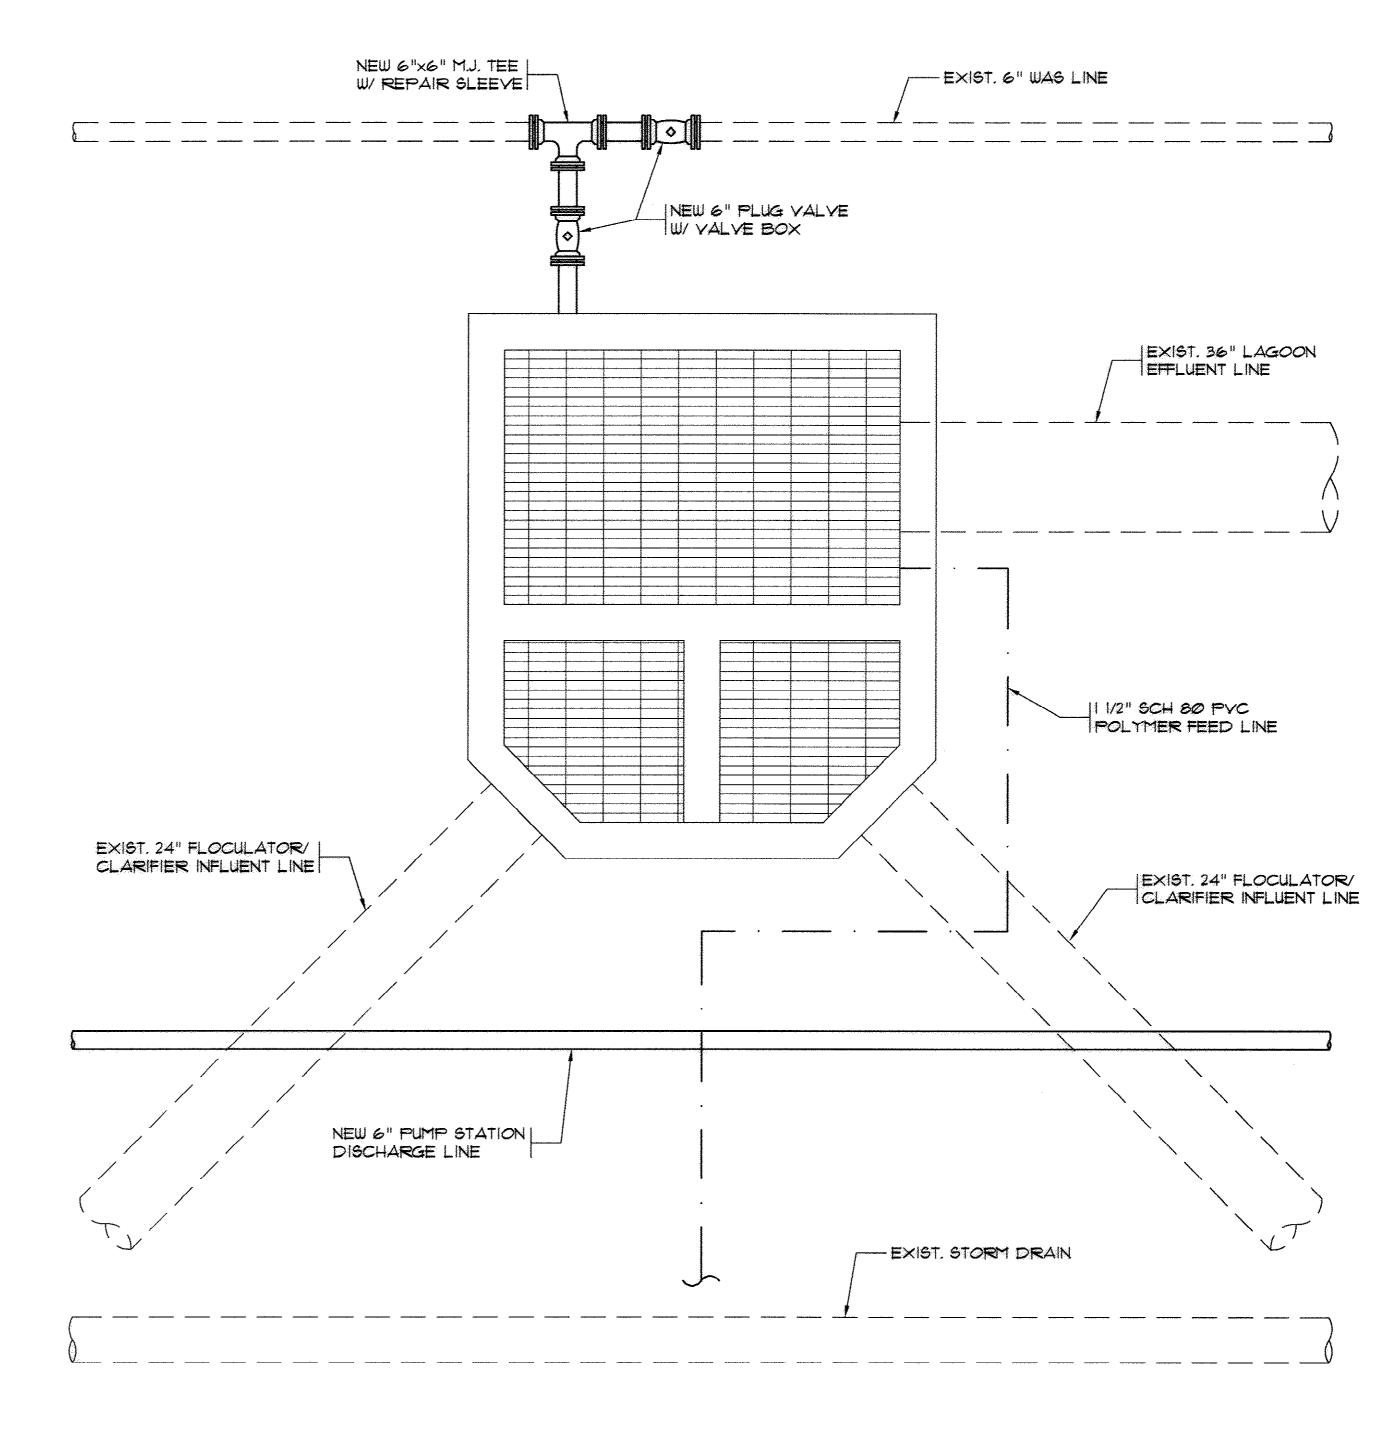

1 EXIST. FLOCULATOR/ CLARIFIER

4 DISTRIBUTION CHAMBER LAYOUT

SCALE: 3/8"=1'-0"

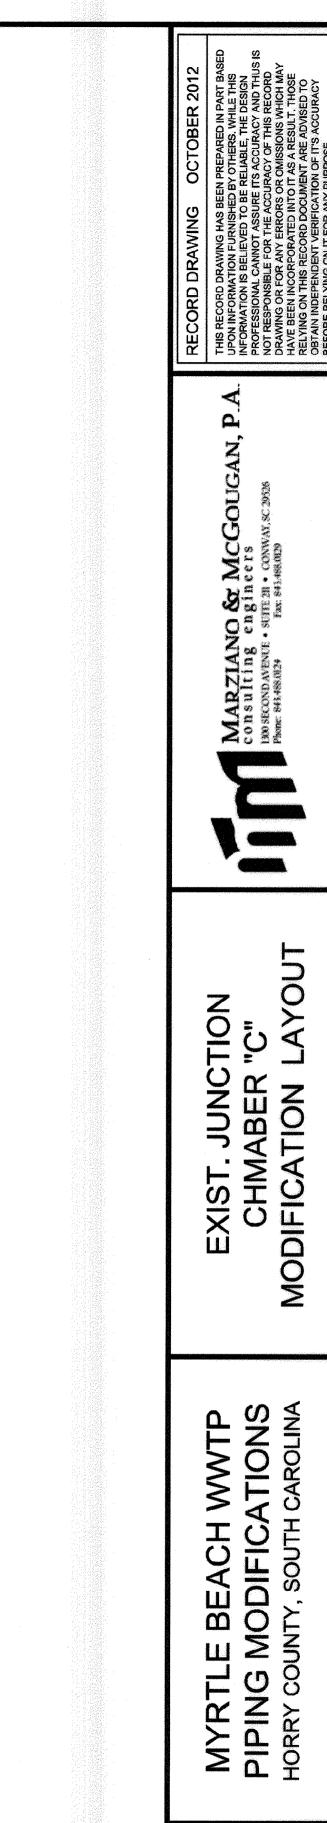

AS SHOWN

OCT 2012


Drawn: ALR
Checked: JWM


Job No.: 31001

G-7

Of: \_\_\_ Version: \_\_5

Sheet No.:

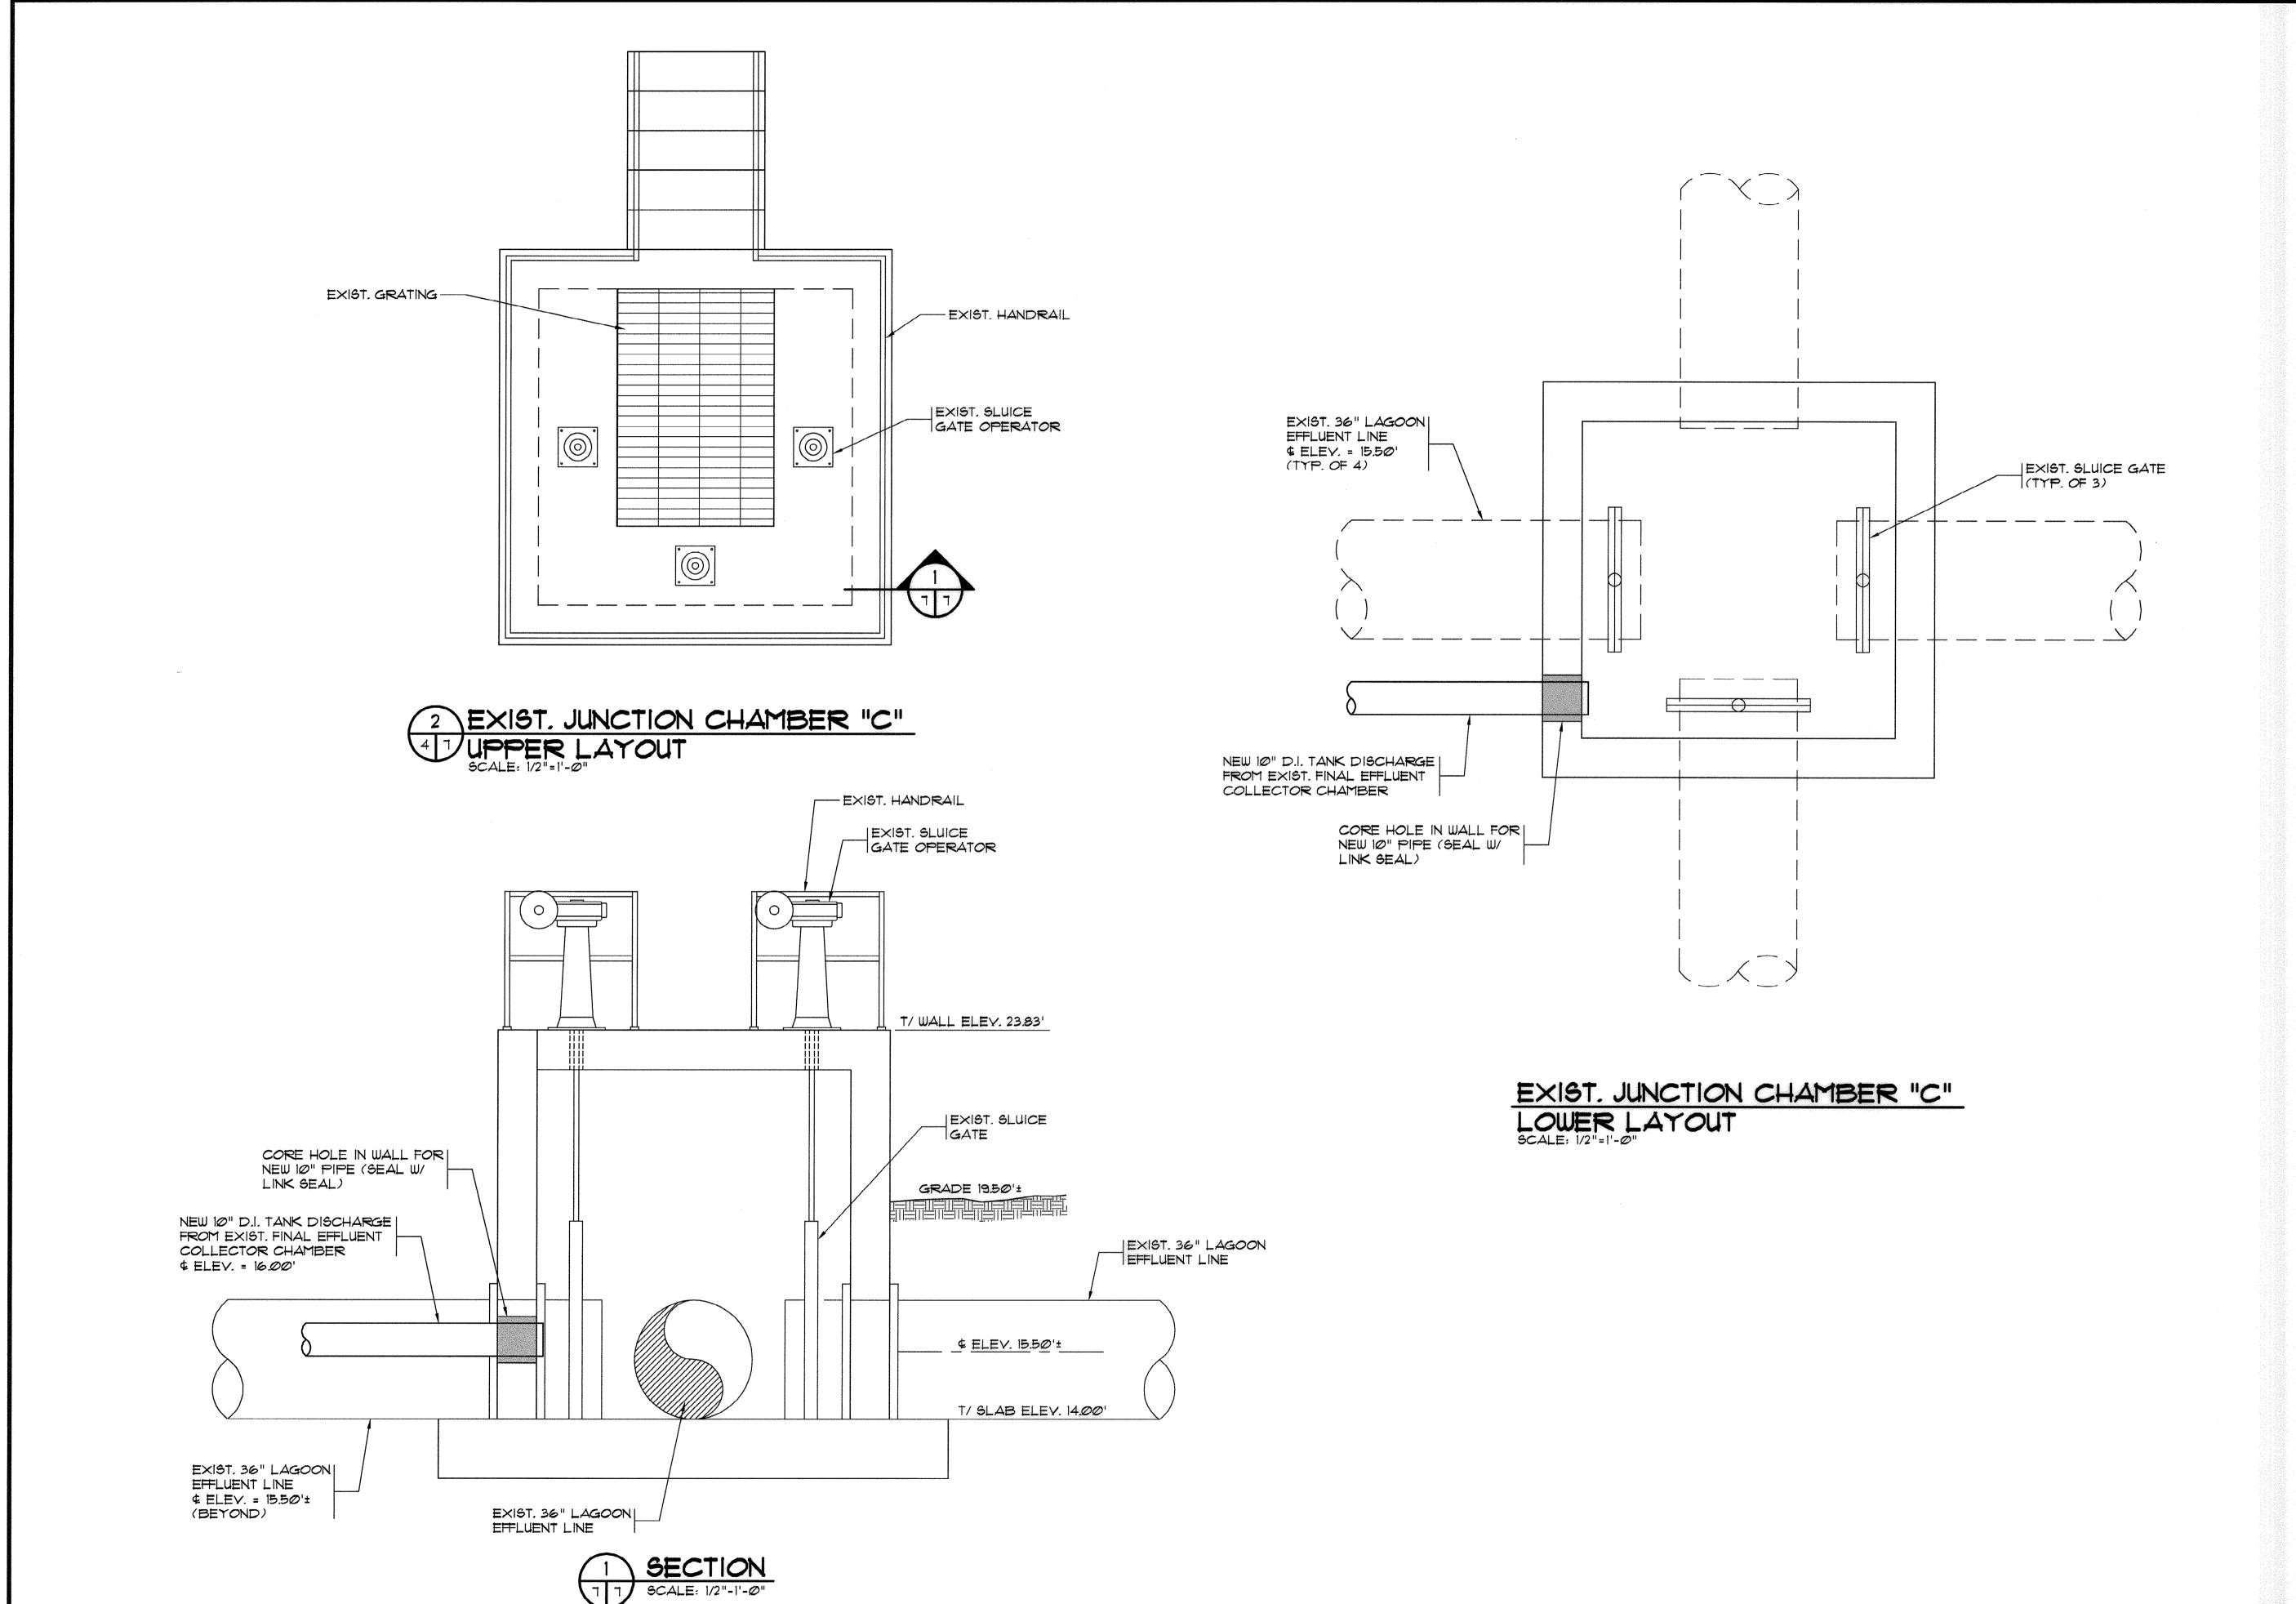

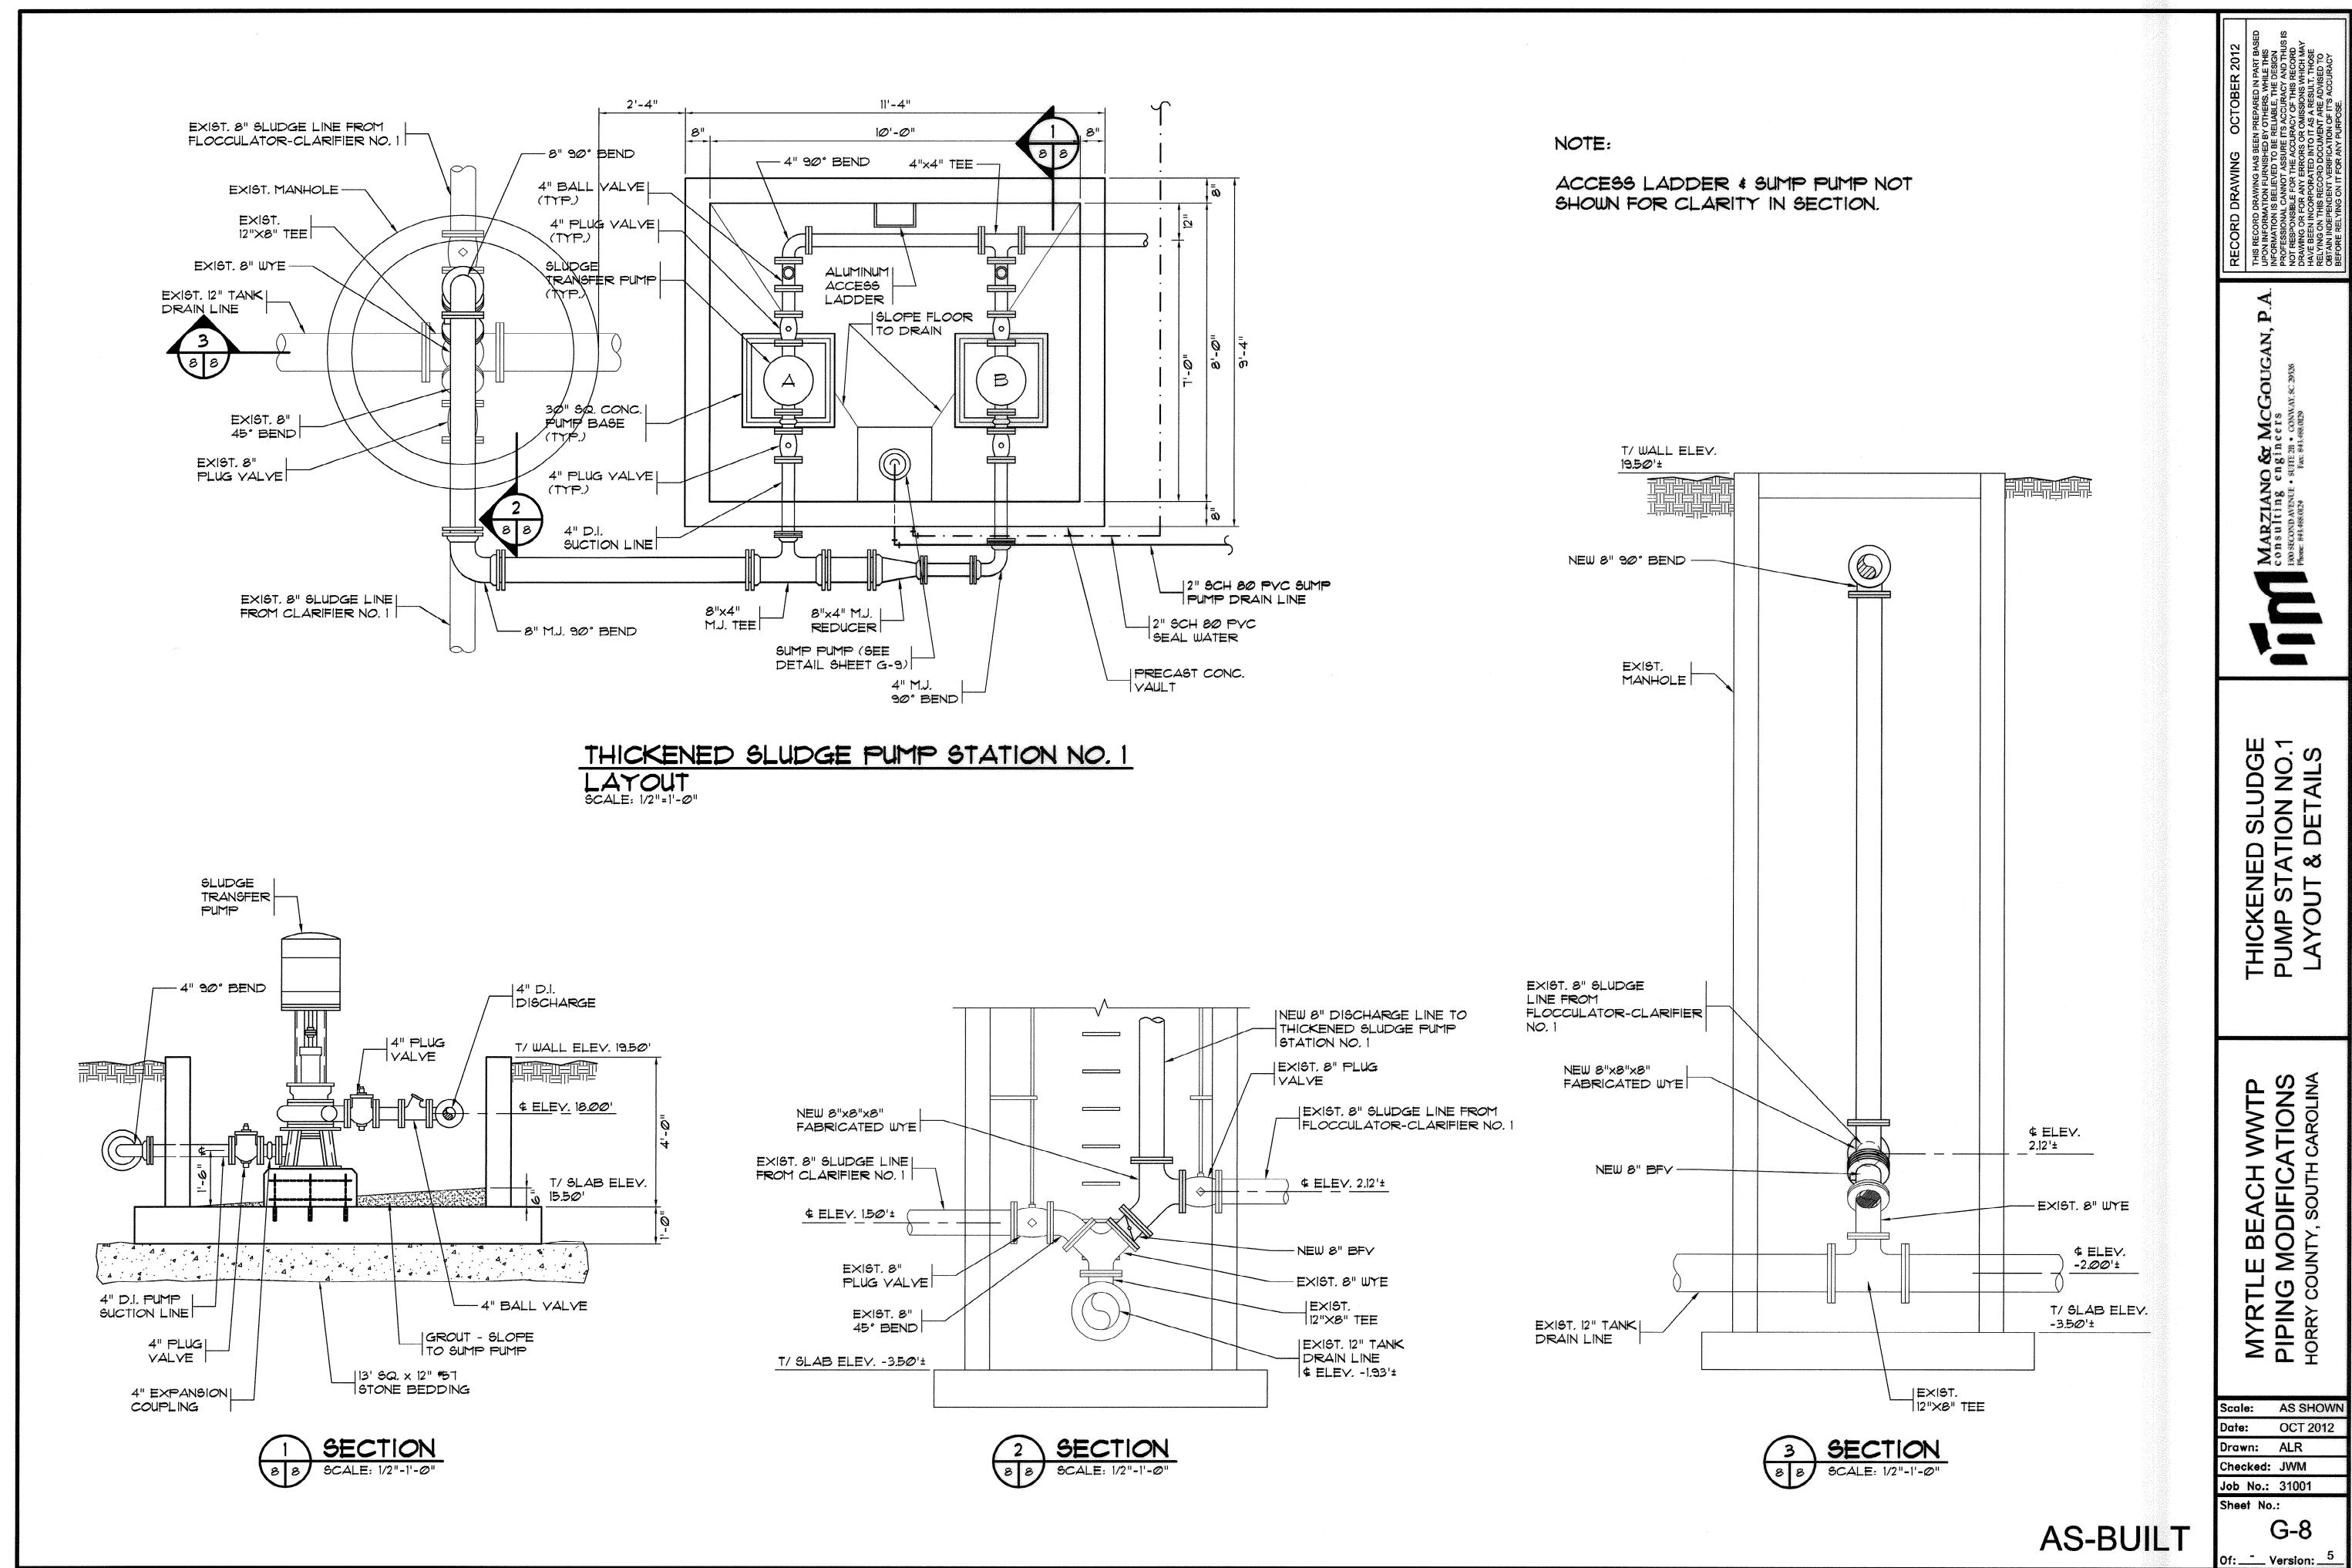


51-014-009/17


Checked: JWM Job No.: 31001 Sheet No.: G-8A

Of: \_\_\_ Version: \_\_5

**AS-BUILT** 

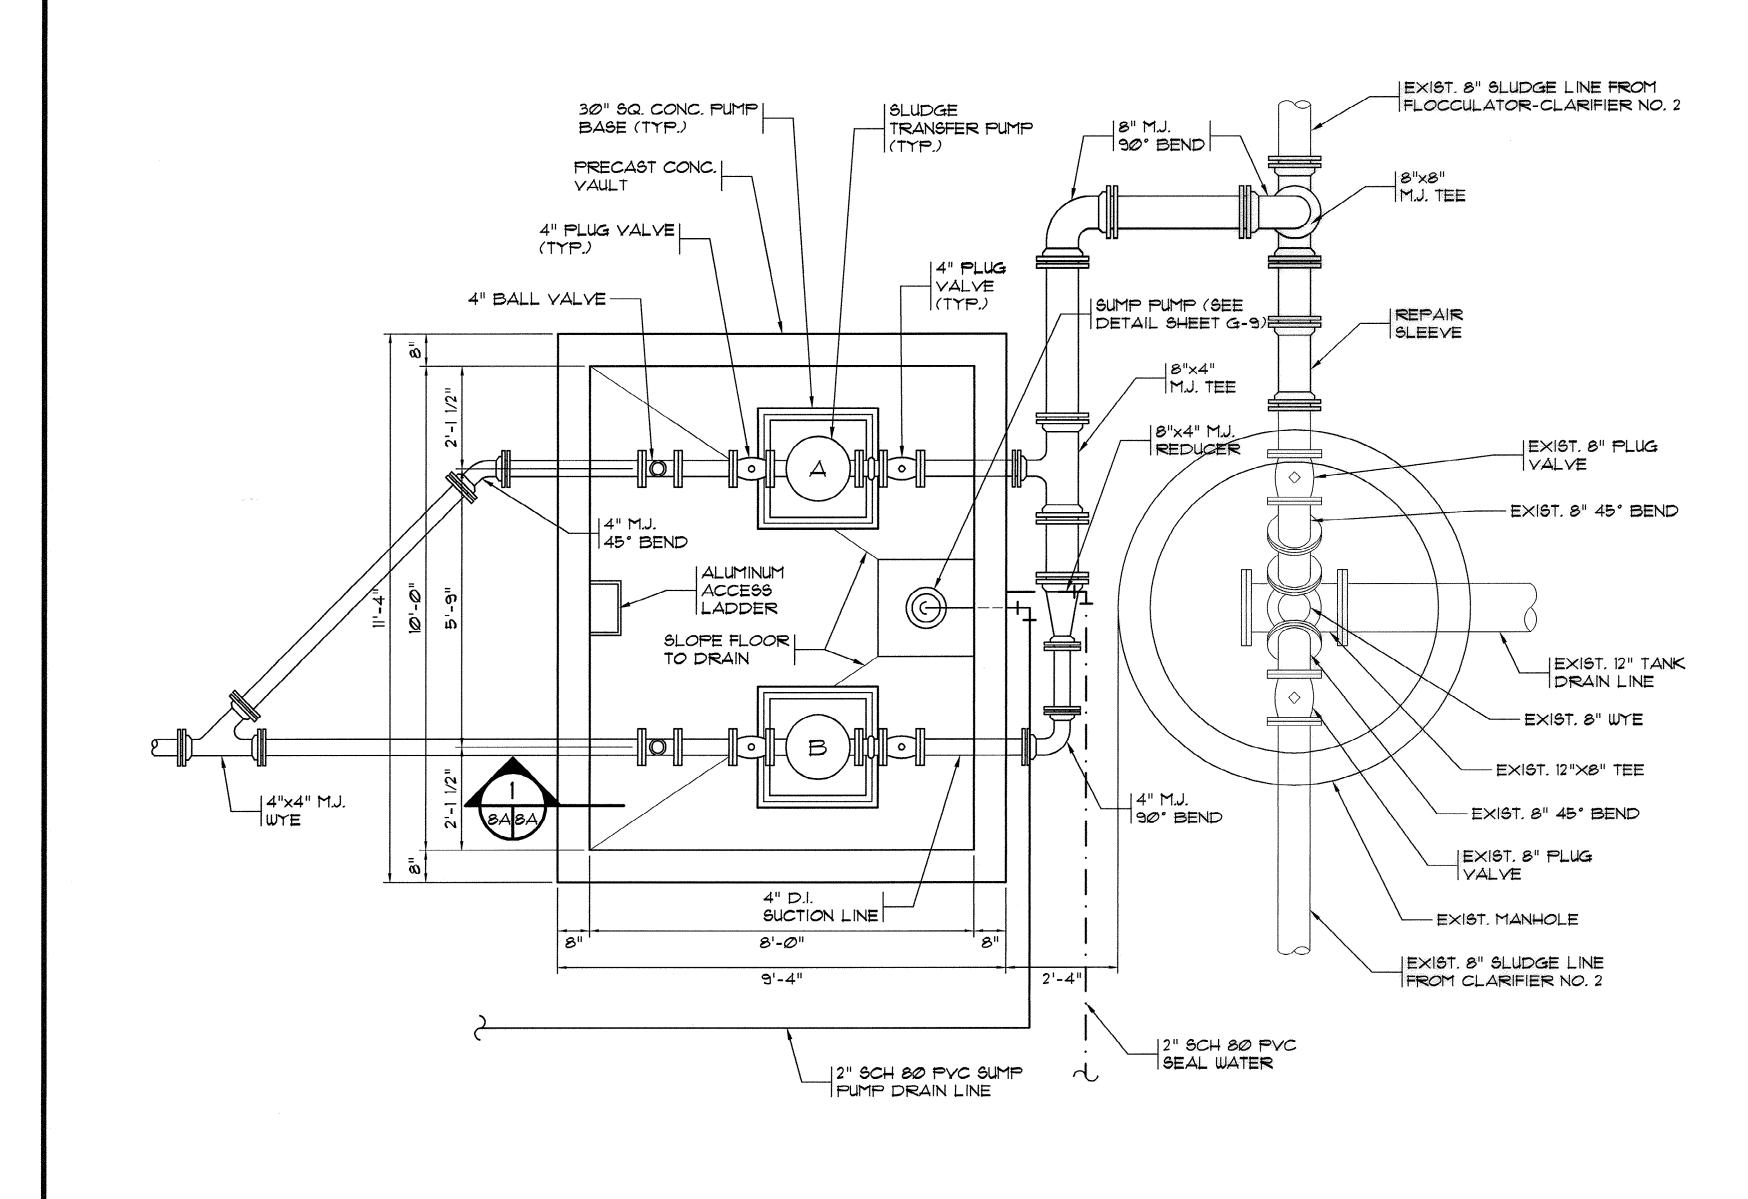

THICKENED SLUDGE PUMP STATION NO. 2 LAYOUT SCALE: 1/2"=1'-0"

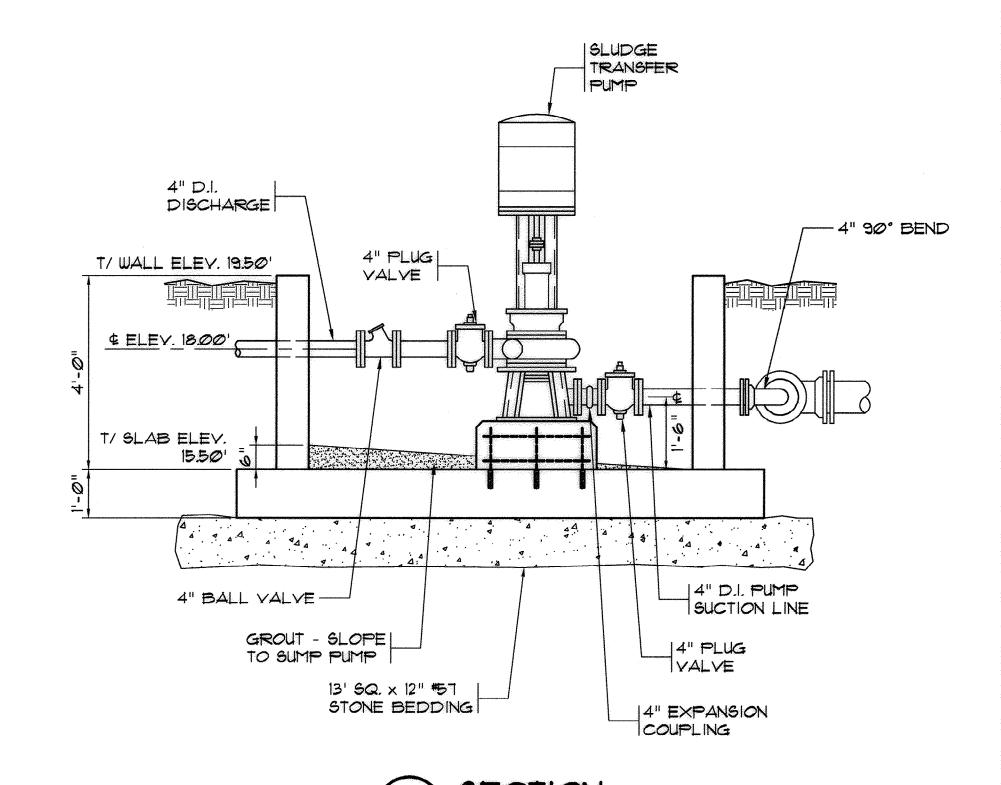



SECTION SABA SCALE: 1/2"-1"-@"

NOTE:

ACCESS LADDER & SUMP PUMP NOT SHOWN FOR CLARITY IN SECTION.


Sheet No.: G-9Of:  $\frac{-}{}$  Version:  $\frac{5}{}$ 

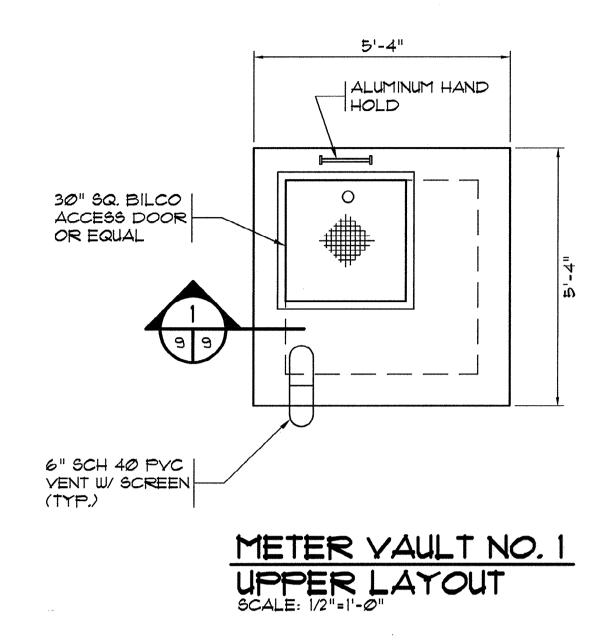


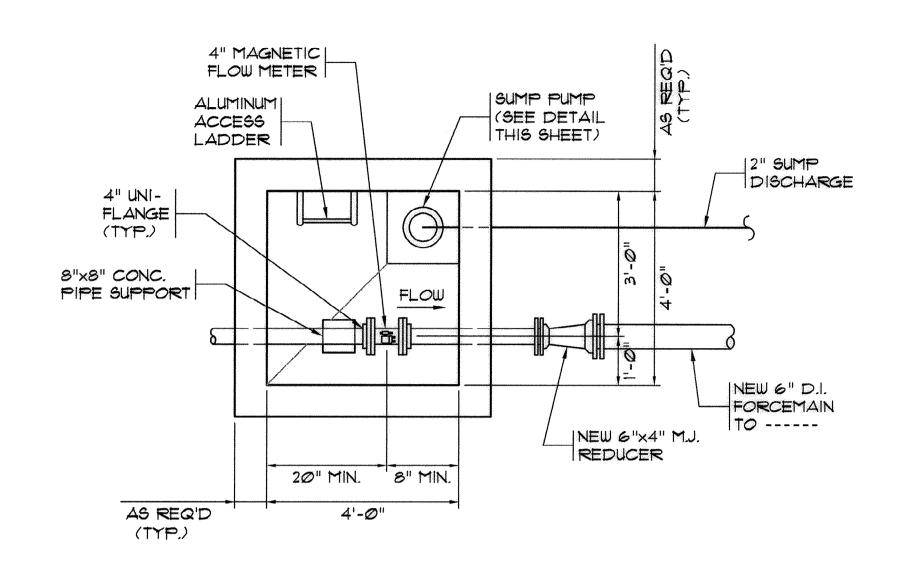

METER VAULT NO. 1
LOWER LAYOUT
SCALE: 1/2"=1'-@"

NOTE: METER VAULT NO. 2 IS A MIRROR IMAGE OF NO. 1. SEE SITE PLAN FOR ORIENTATION.

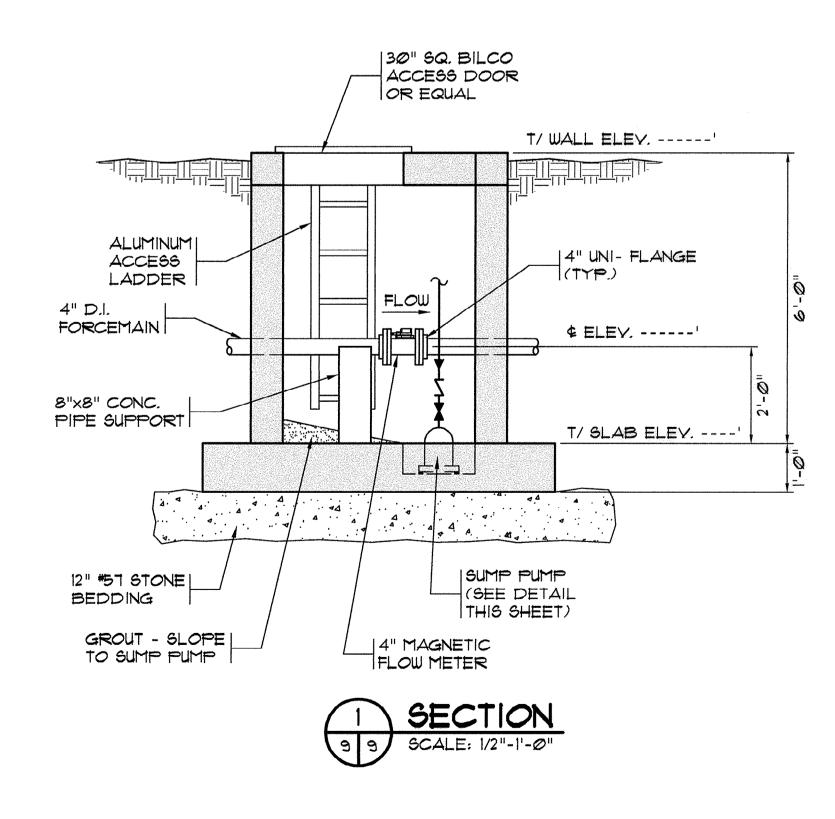


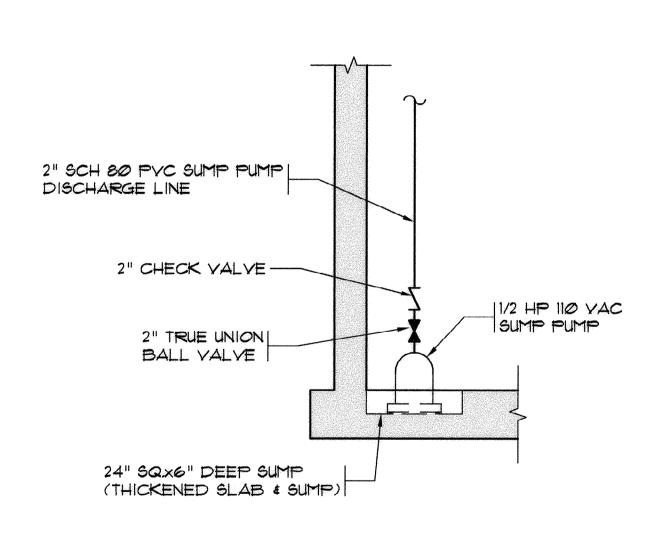


SUMP PUMP DETAIL
N.T.S.

Of:  $\frac{-}{}$  Version:  $\frac{5}{}$ 

AS SHOWN

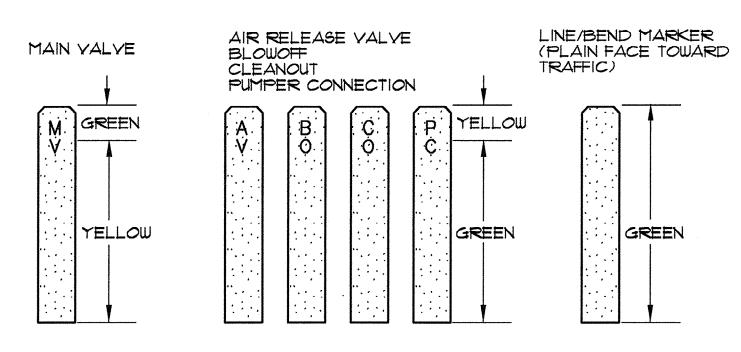



### CONCRETE MARKER PAINT CODES

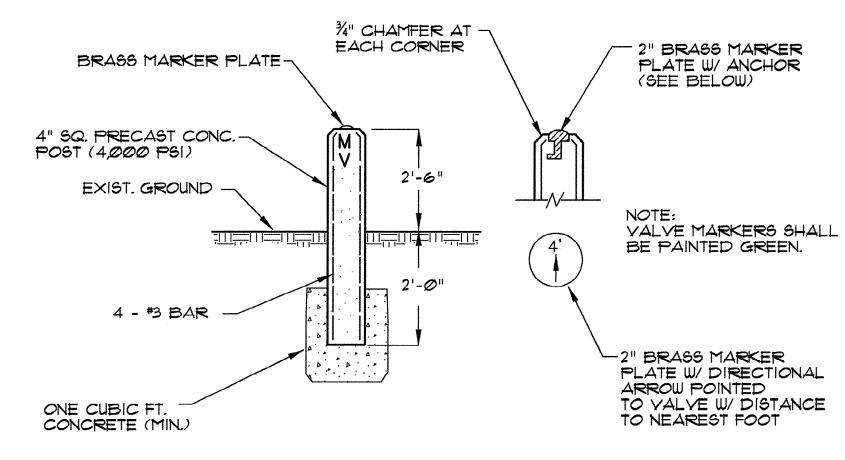

## TYPICAL CONCRETE MARKERS


(YALVE, ARV, BLOWOFF, CLEANOUT, PUMPER CONNECTION, LINE/BEND)
N.T.S.

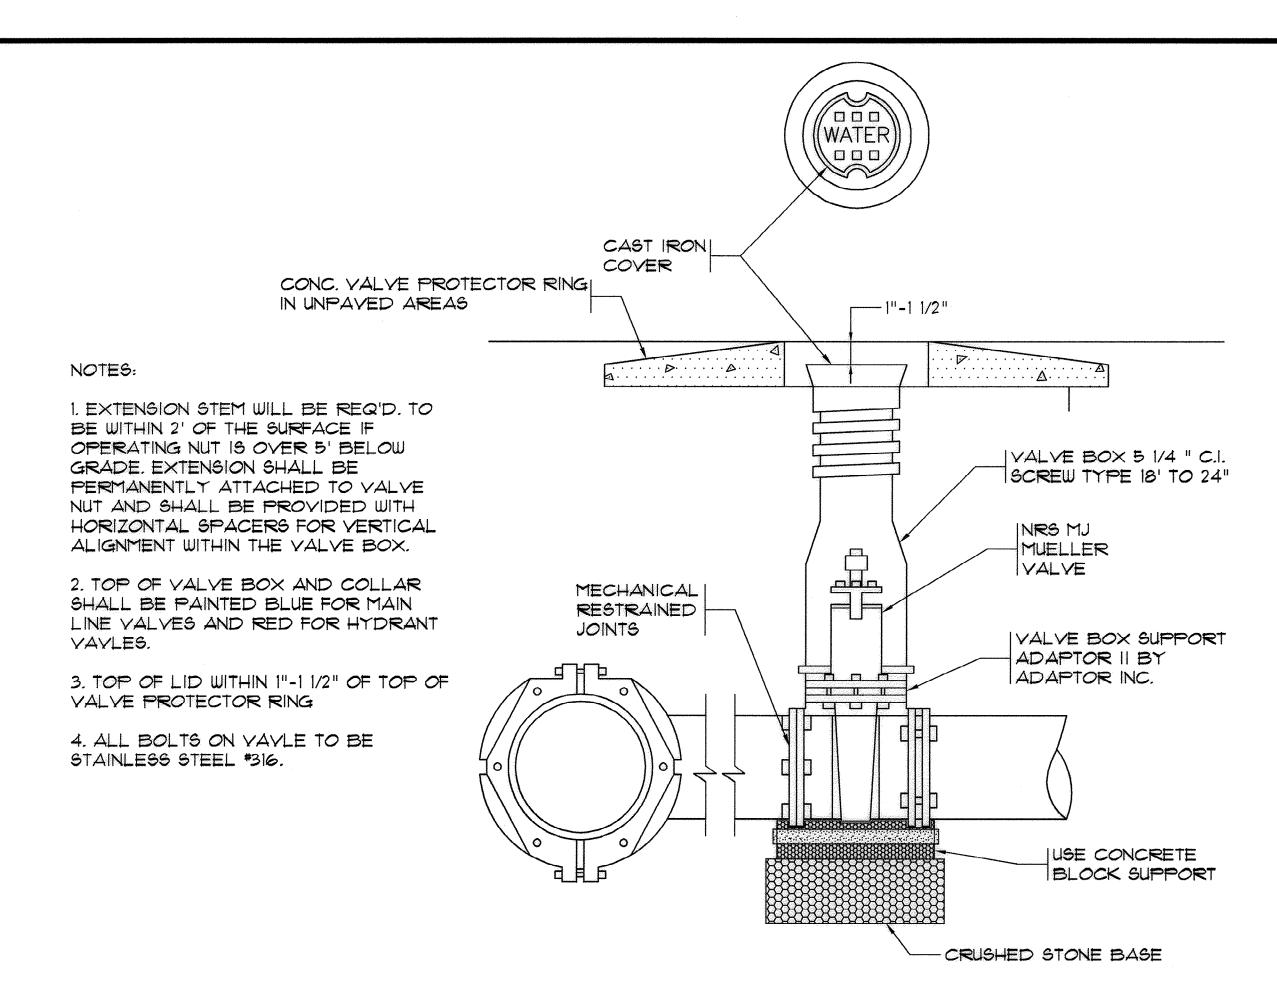

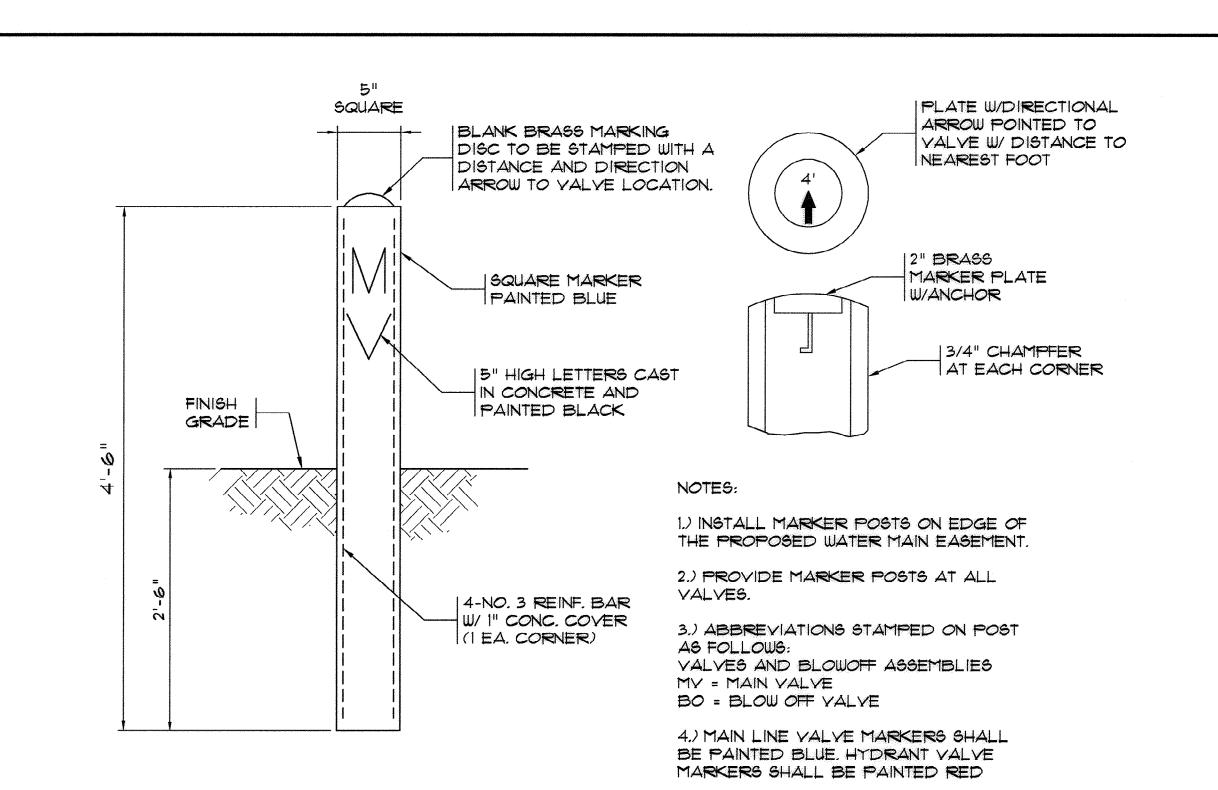

VALVE MARKER POST DETAIL

TYPICAL VALVE AND VALVE BOX

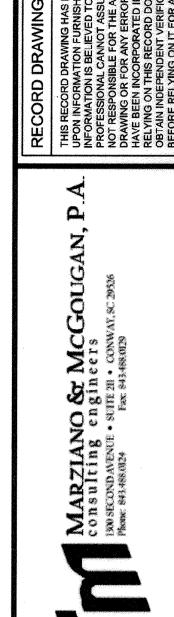




MYRTLE BEACH WWTP PIPING MODIFICATIONS HORRY COUNTY, SOUTH CAROLINA


Scale: AS SHOWN
Date: OCT 2012
Drawn: ALR
Checked: JWM
Job No.: 31001

Checked: JWM
Job No.: 31001
Sheet No.:
G-11

Of:  $\frac{-}{}$  Version:  $\frac{5}{}$ 

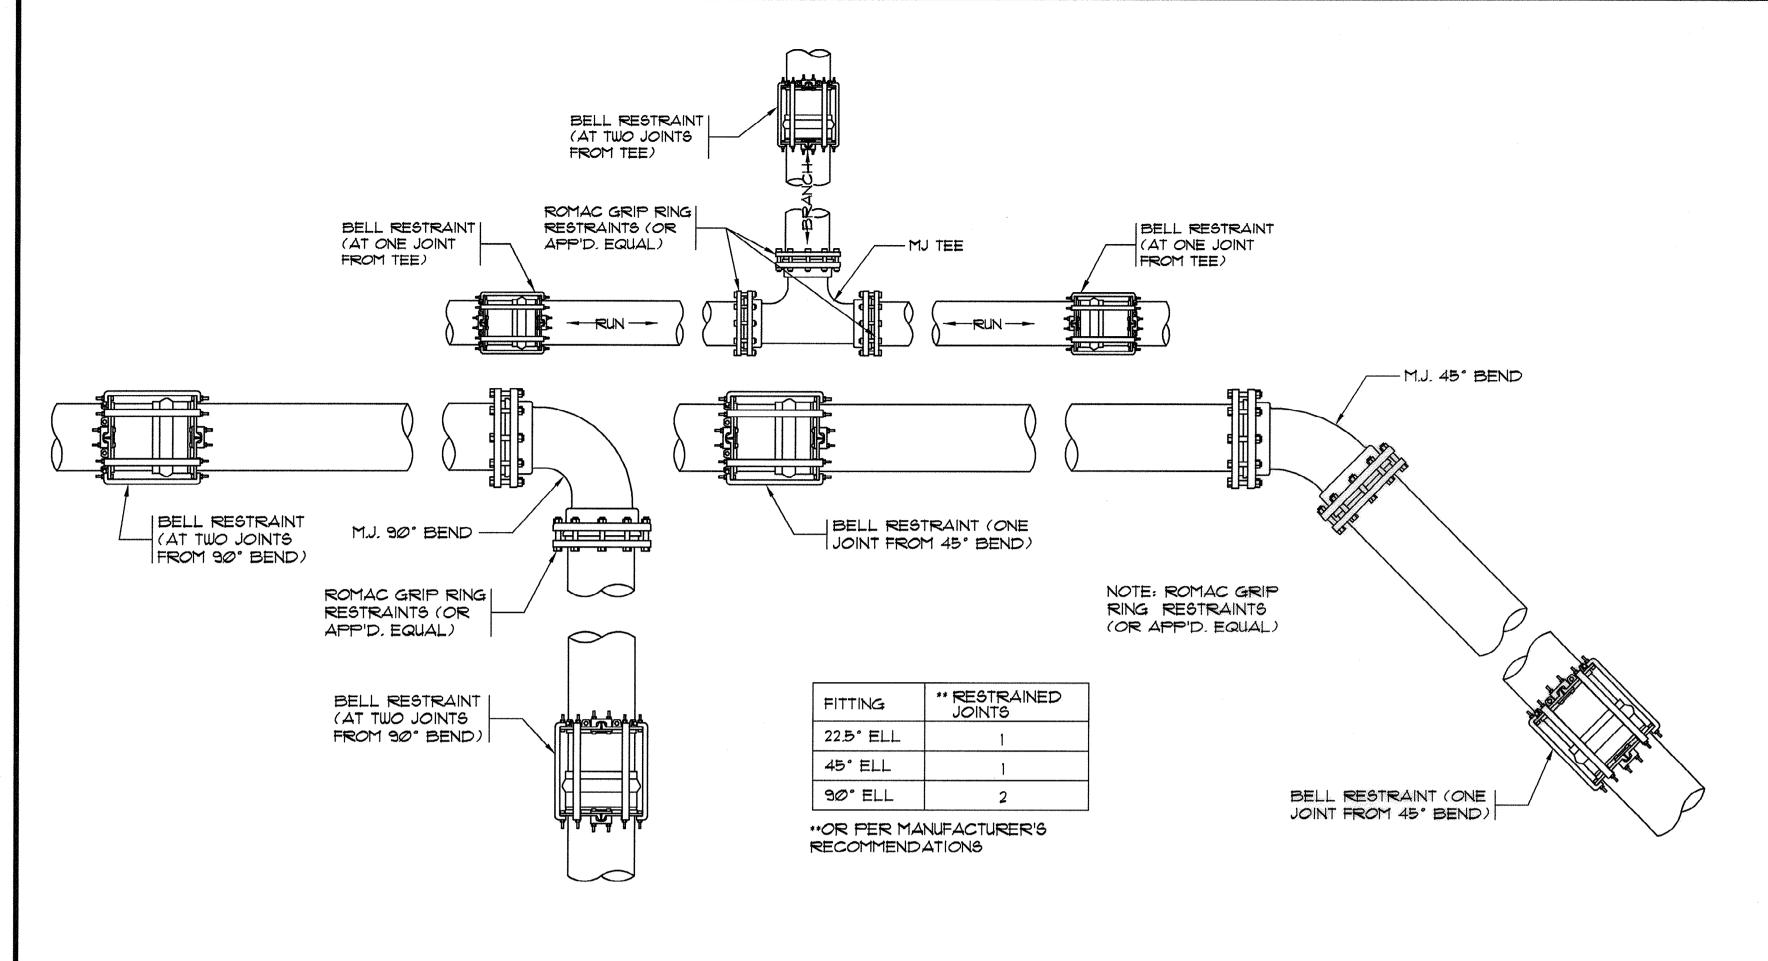





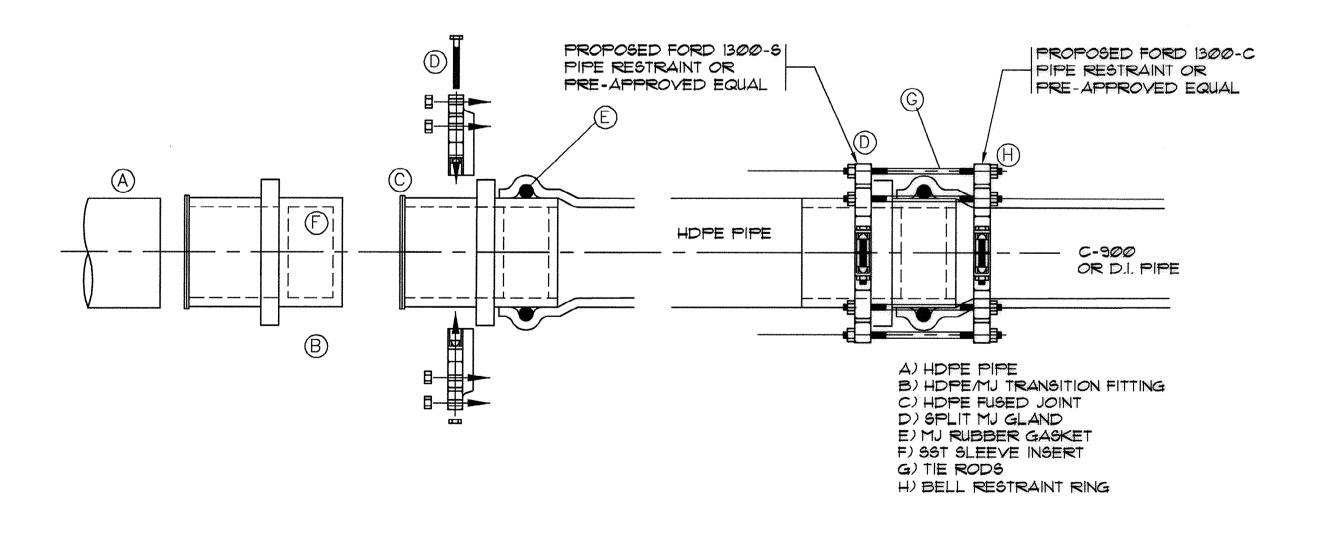


HDPE/PYC TRANSITION ASSEMBLY

N.T.S.

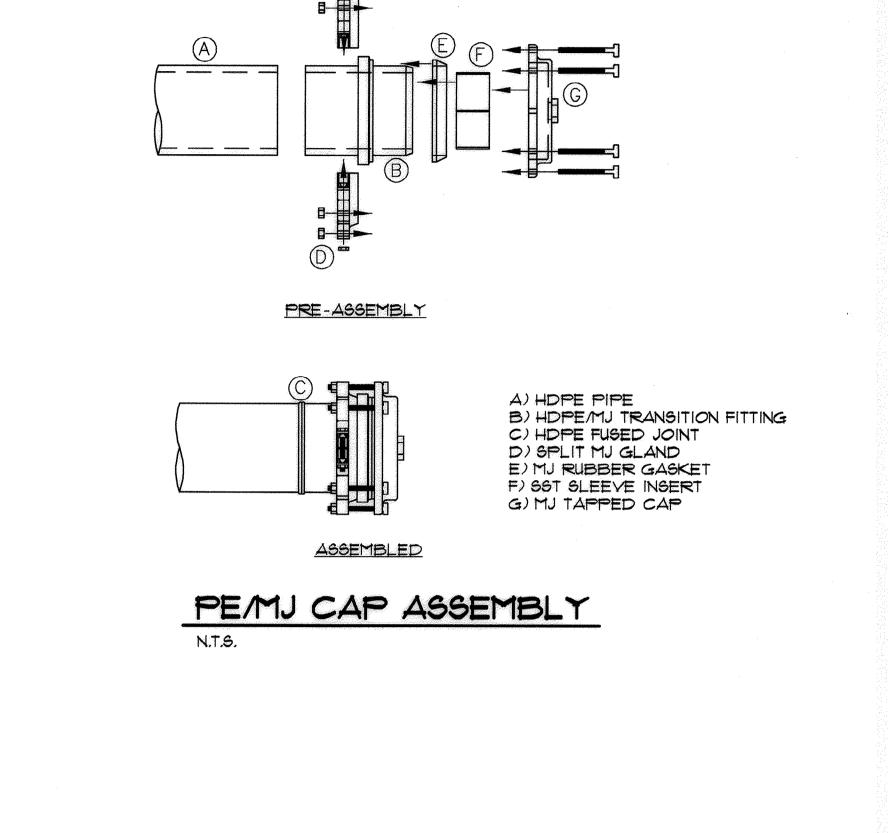

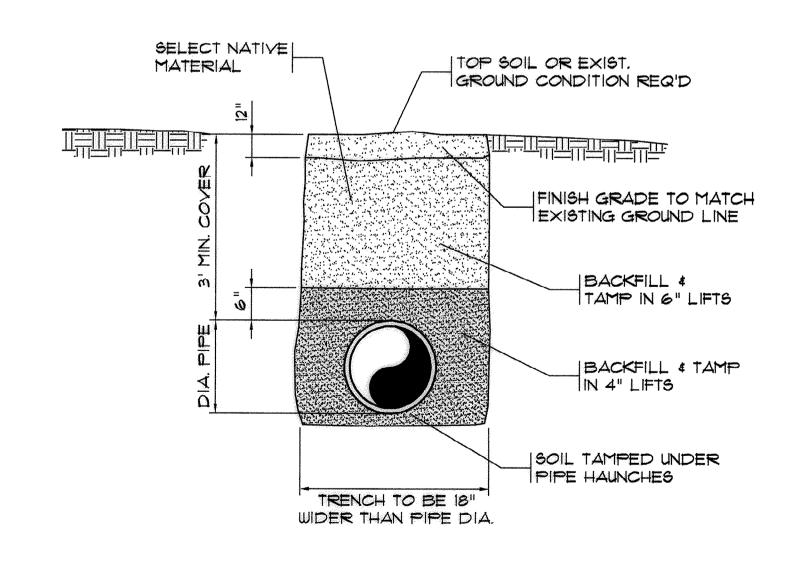


TYPICAL PIPE BEDDING DETAIL

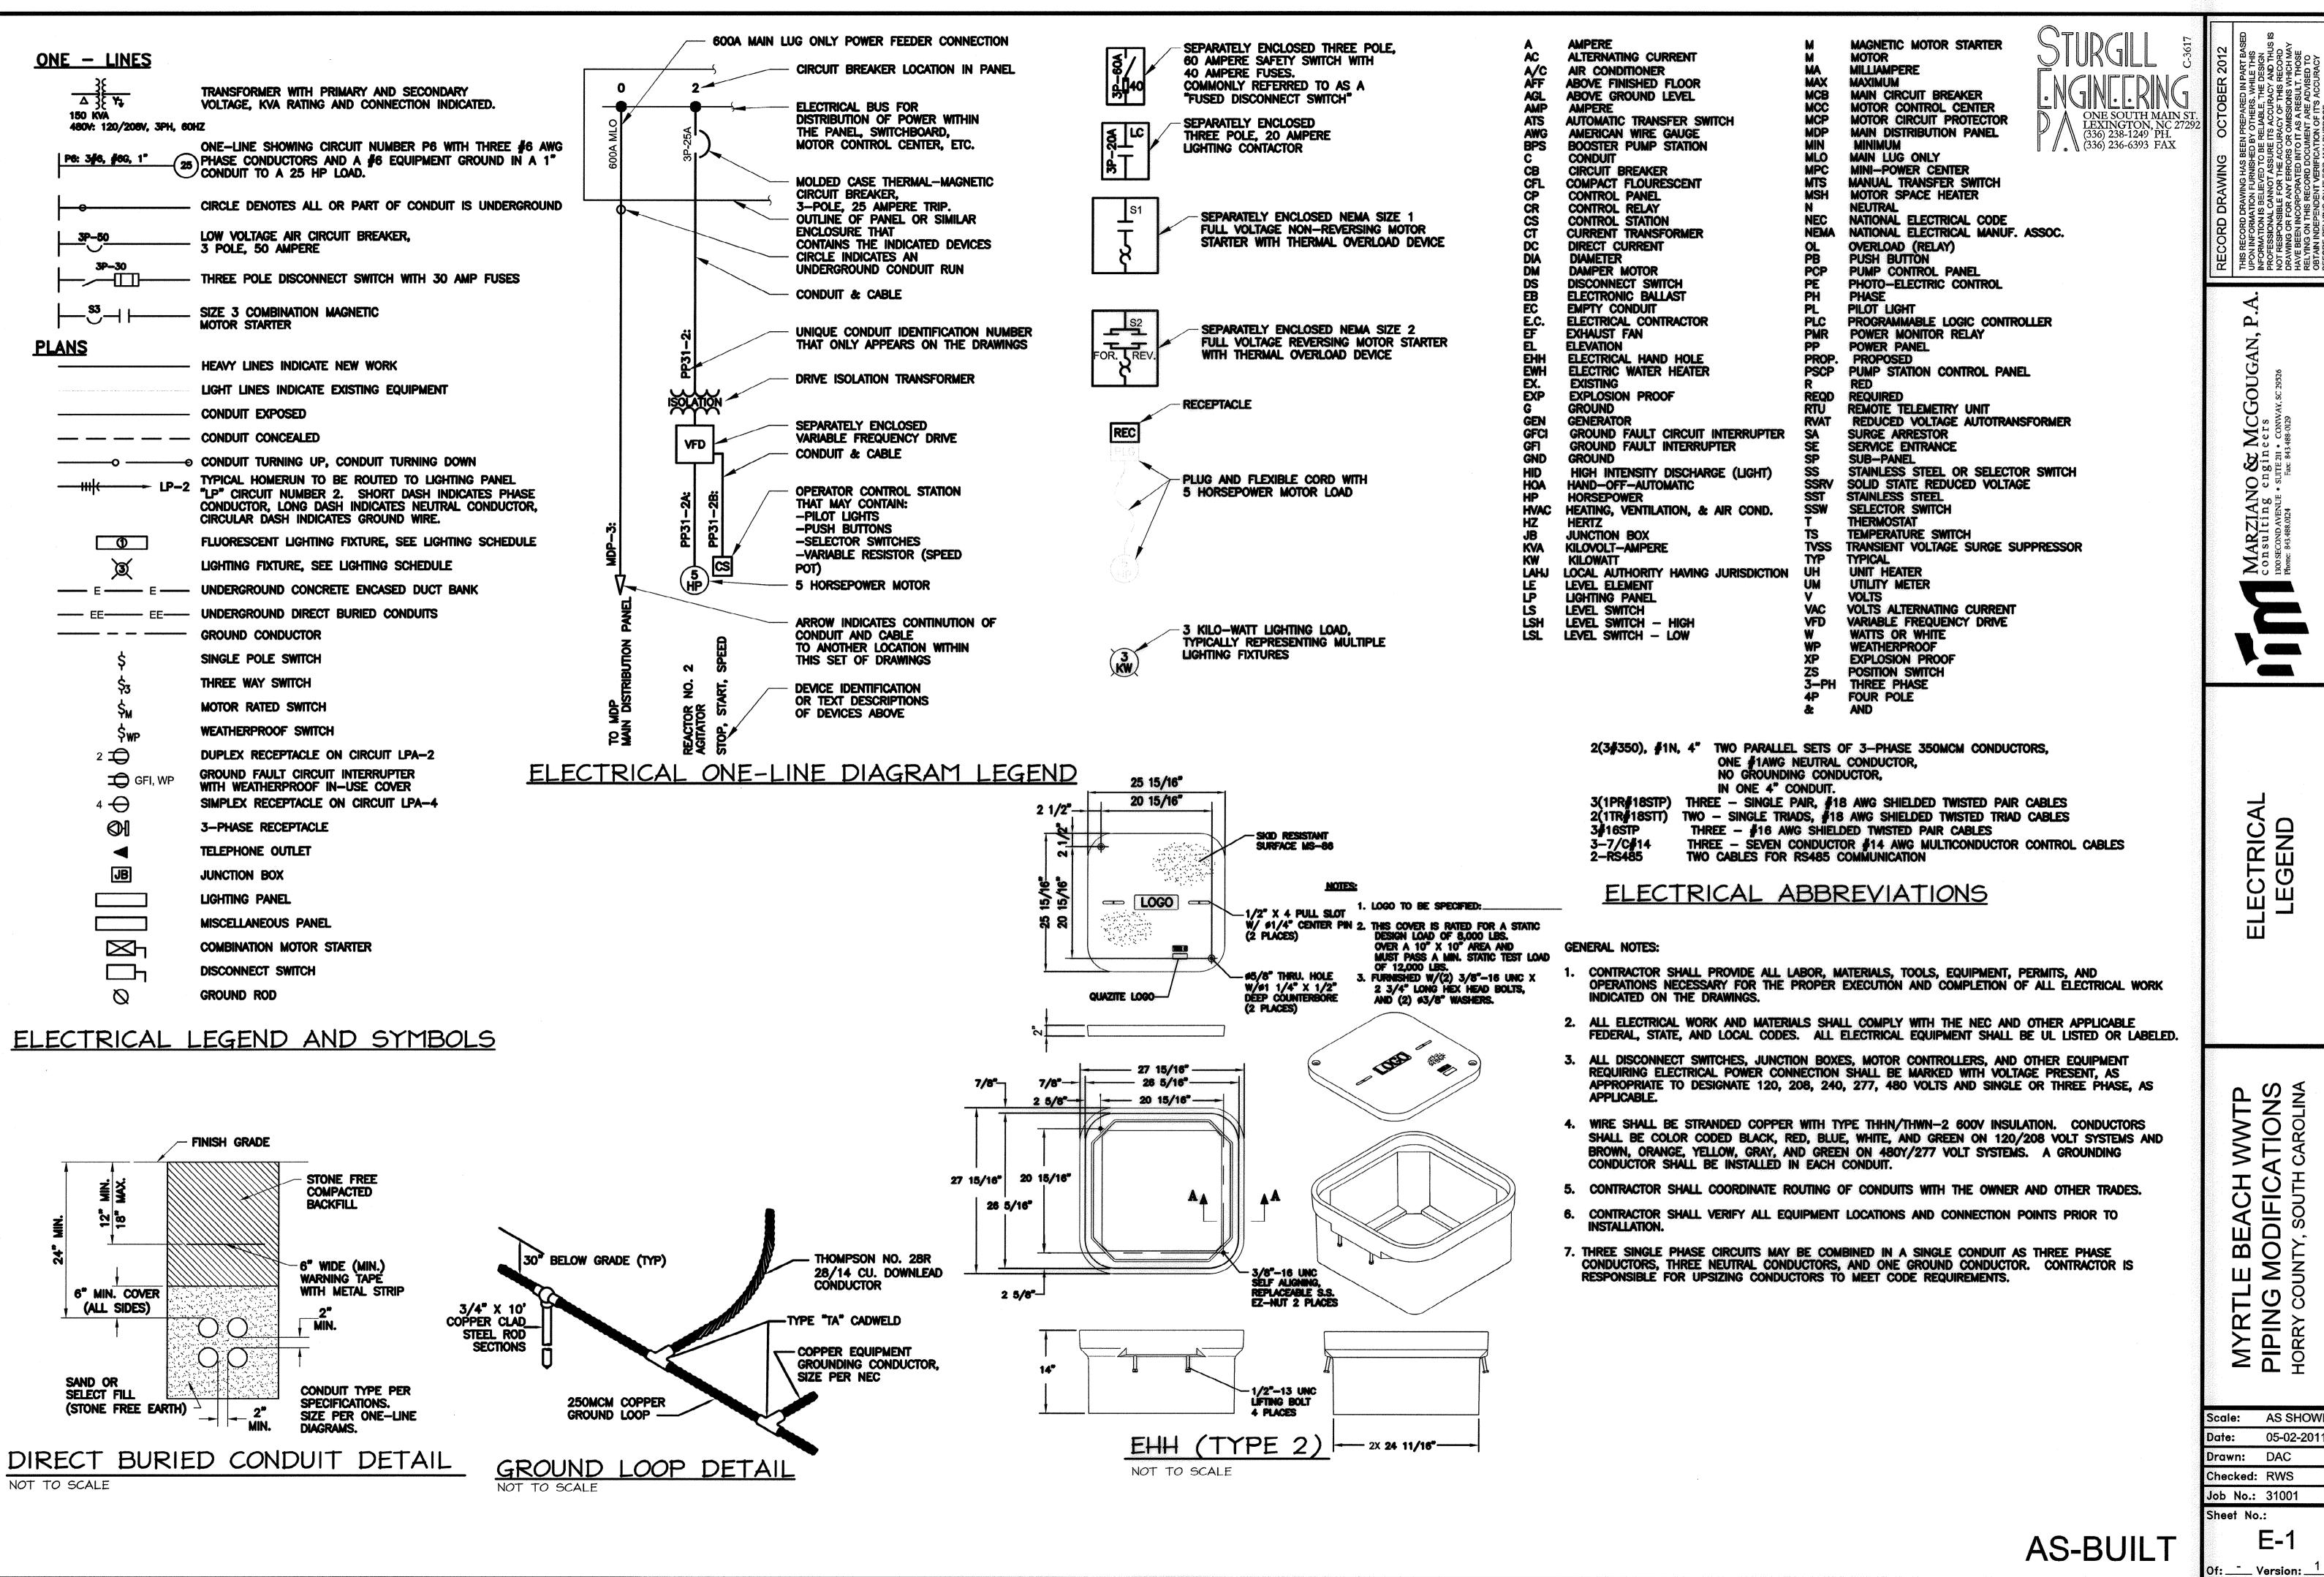


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BEACH WWTP AODIFICATIONS NTY, SOUTH CAROLINA

AS SHOWN 05-02-2011

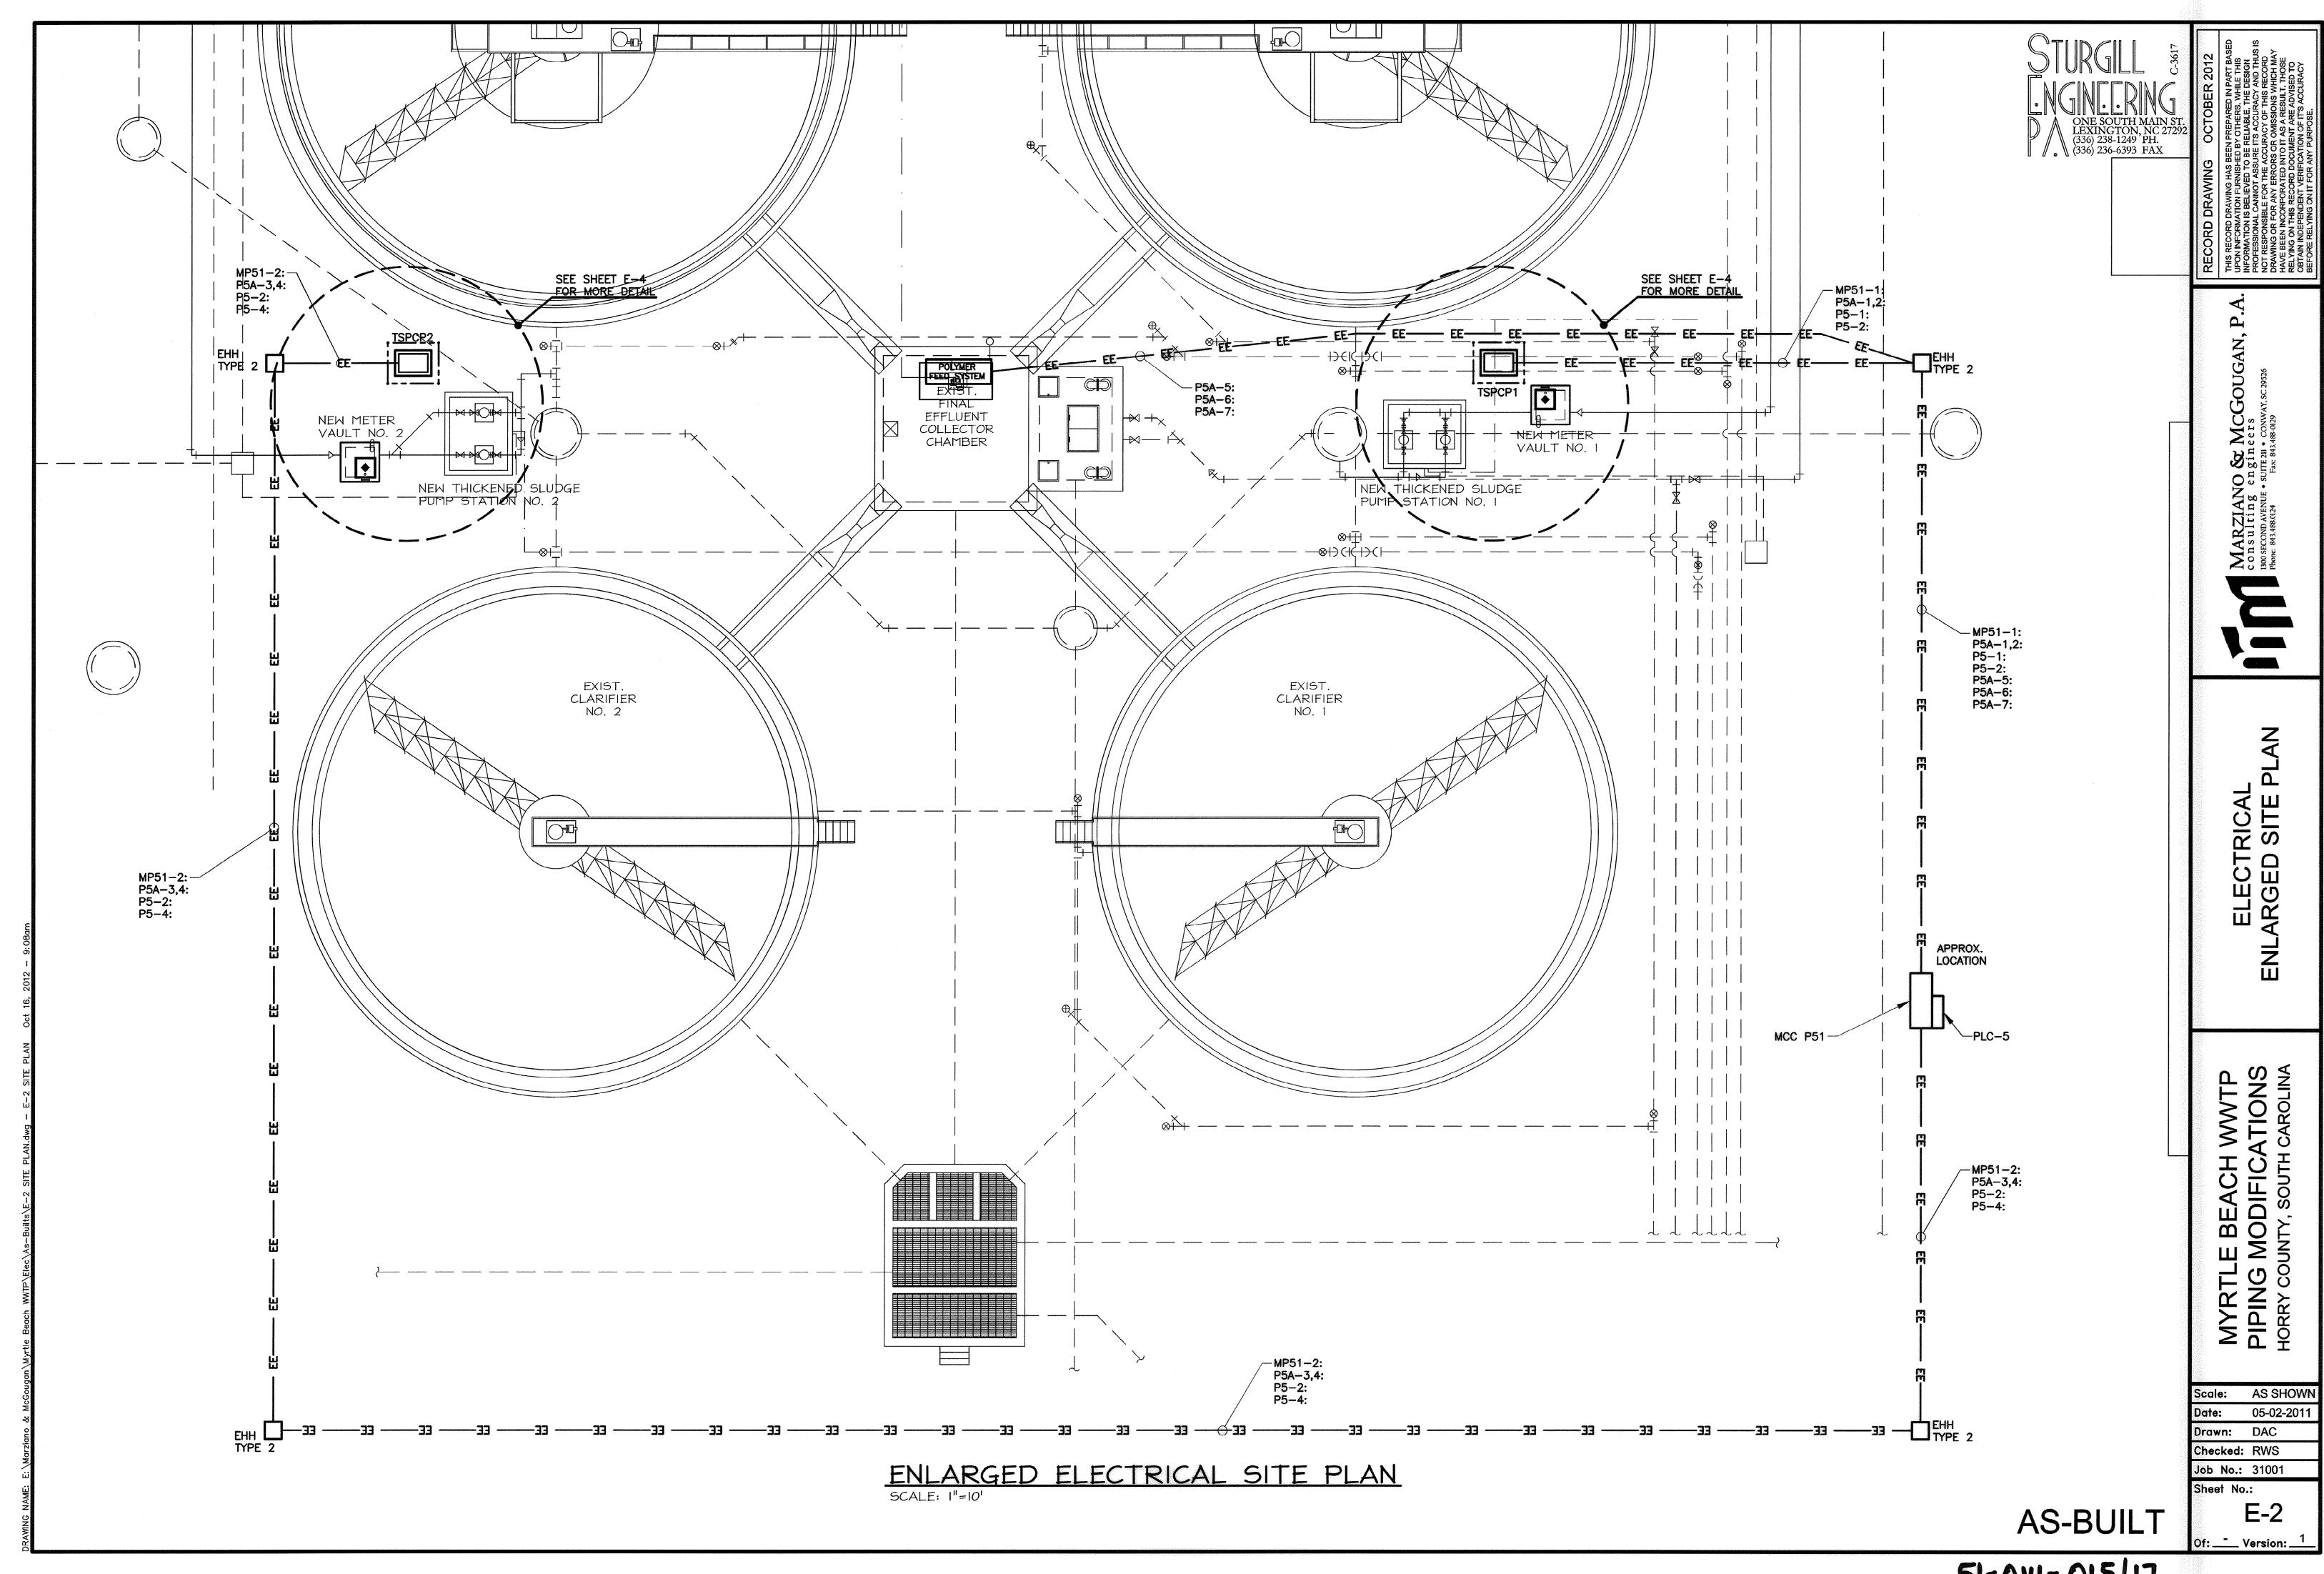

51-014-015/17

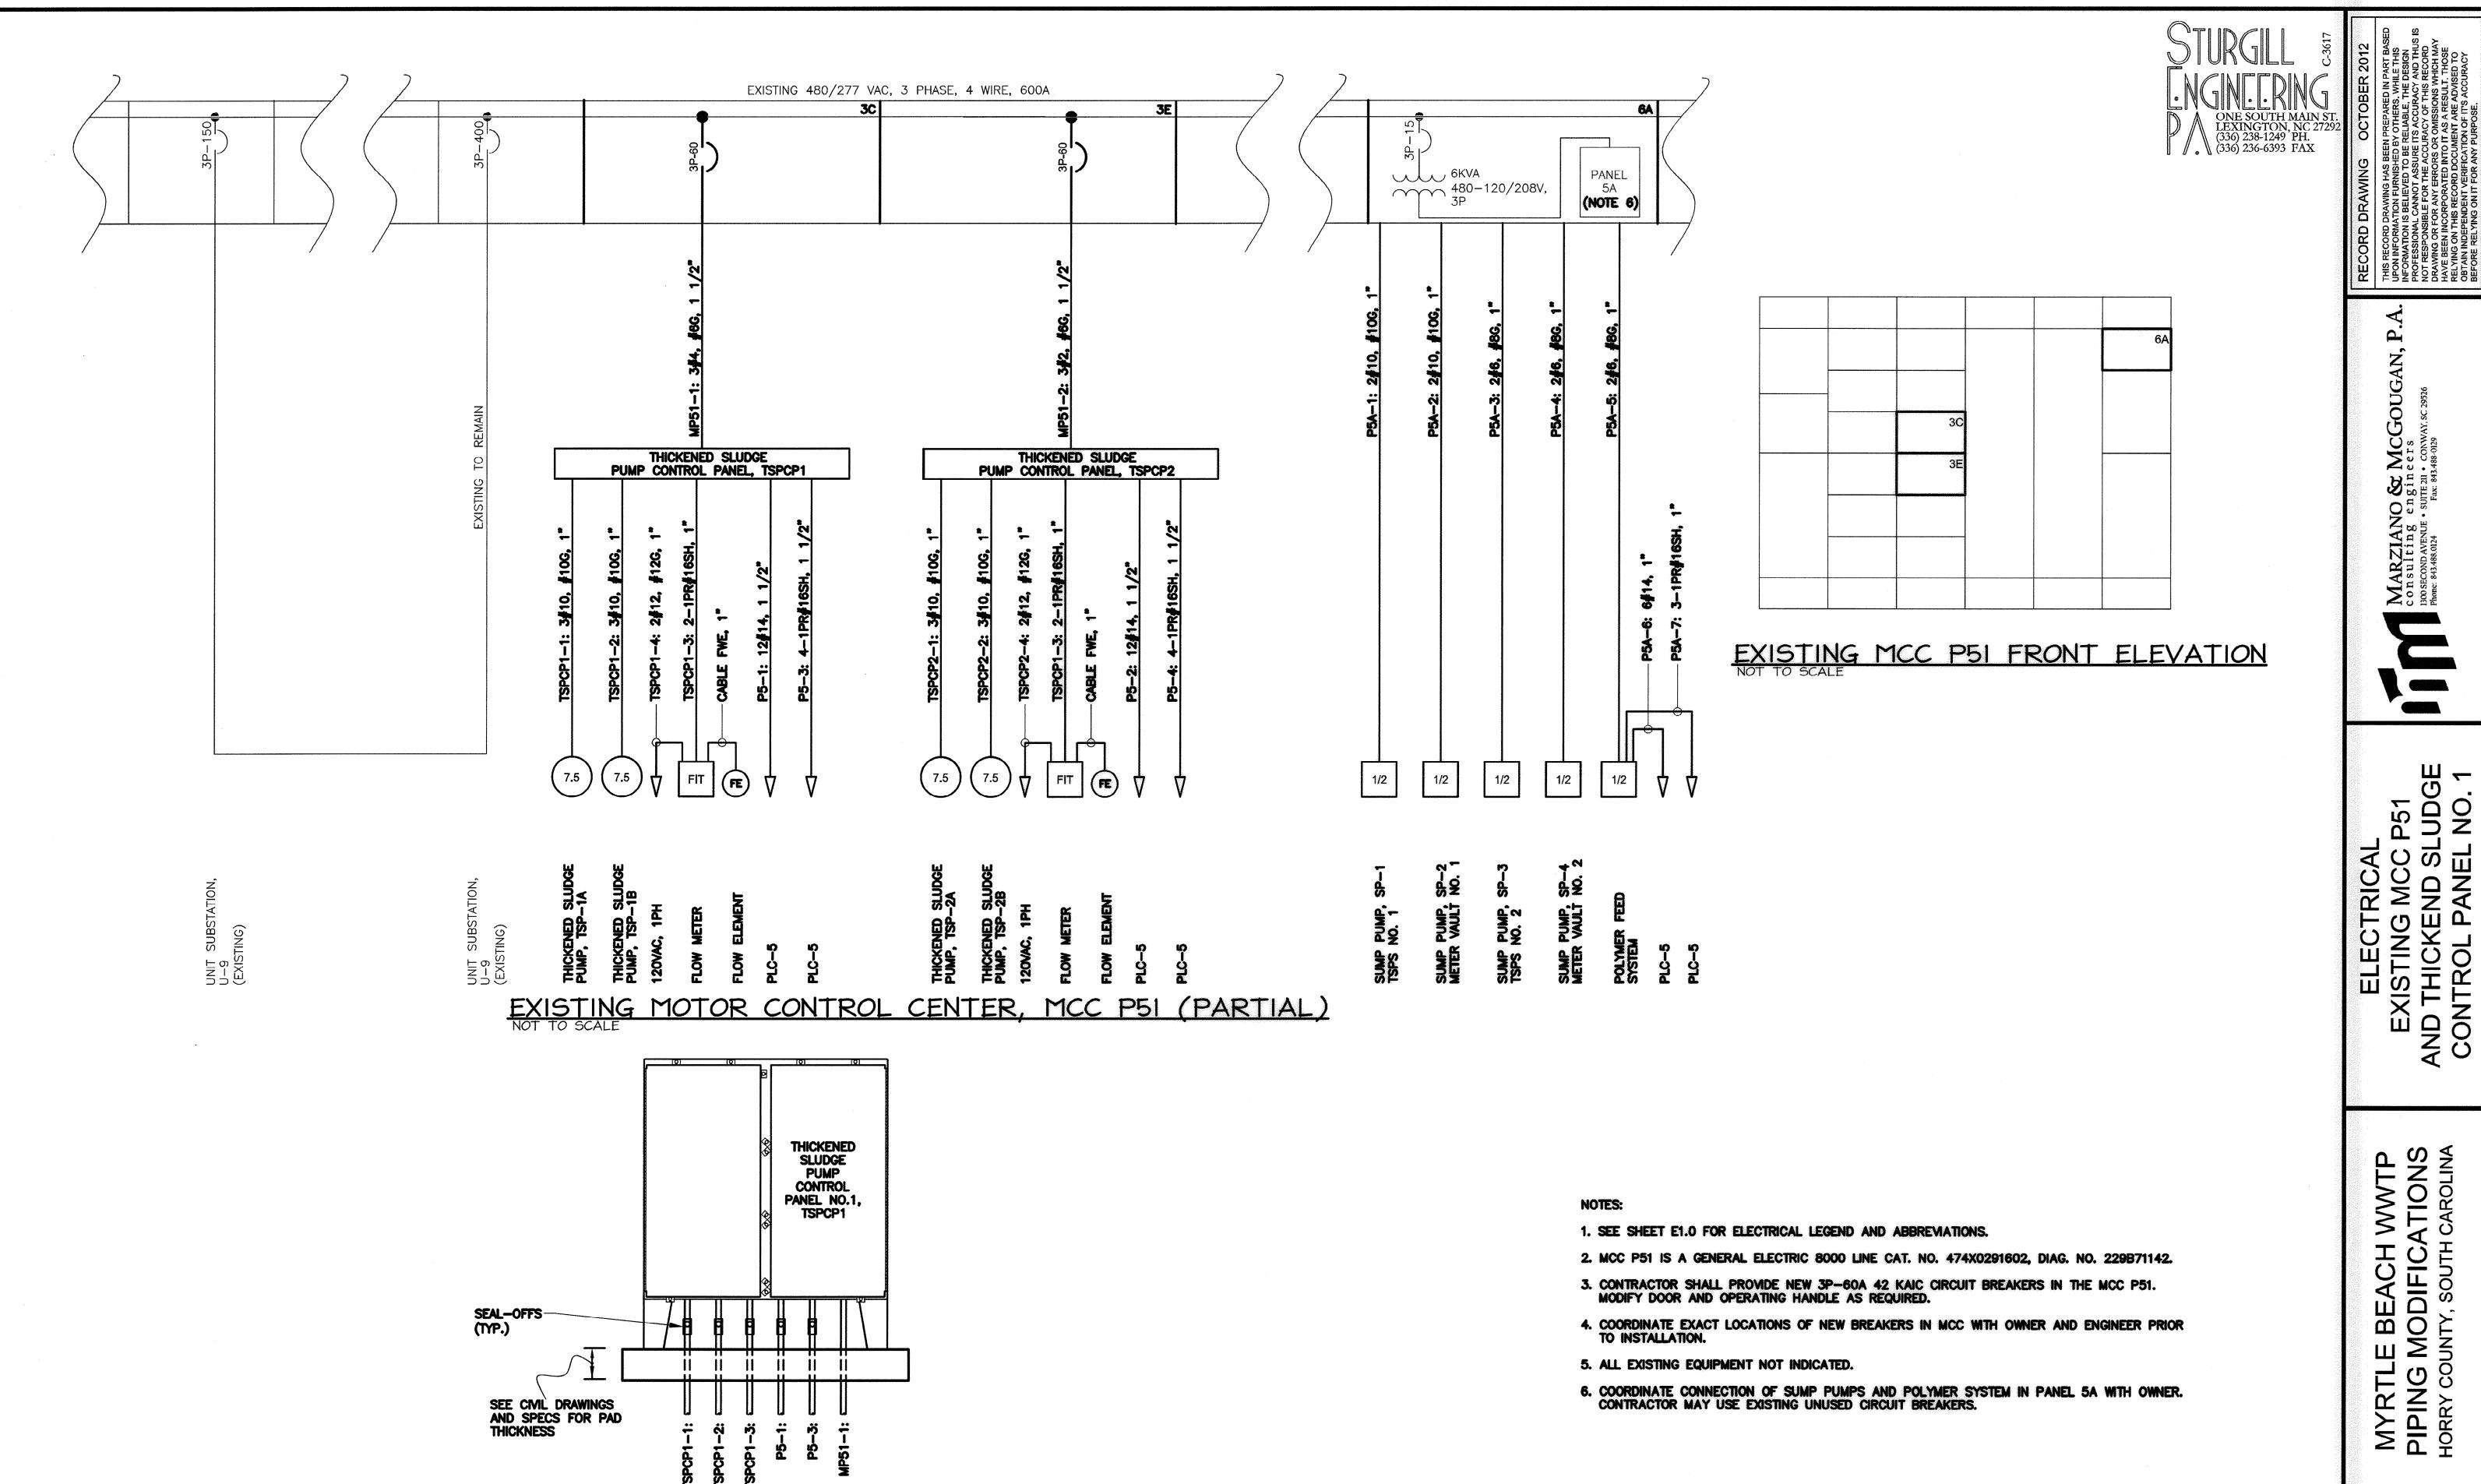

THICKENED SLUDGE PUMP CONTROL PANEL NO.1

1. SEE SHEET E-1 FOR ELECTRICAL LEGEND AND ABBREVIATIONS.

2. CONTRACTOR TO VERIFY PAD SIZE WITH PANEL SUPPLIER PRIOR TO POURING PAD.

NO TO SCALE (TYPICAL FOR TSPCP NO. 2)

Checked: RWS Job No.: 31001 Sheet No.: E-3 **AS-BUILT** 


51-014-016/17

MYRTLE BEACH WWTP PIPING MODIFICATIONS HORRY COUNTY, SOUTH CAROLINA

AS SHOWN 05-02-2011

Drawn: DAC

Of: \_\_\_\_ Version: \_

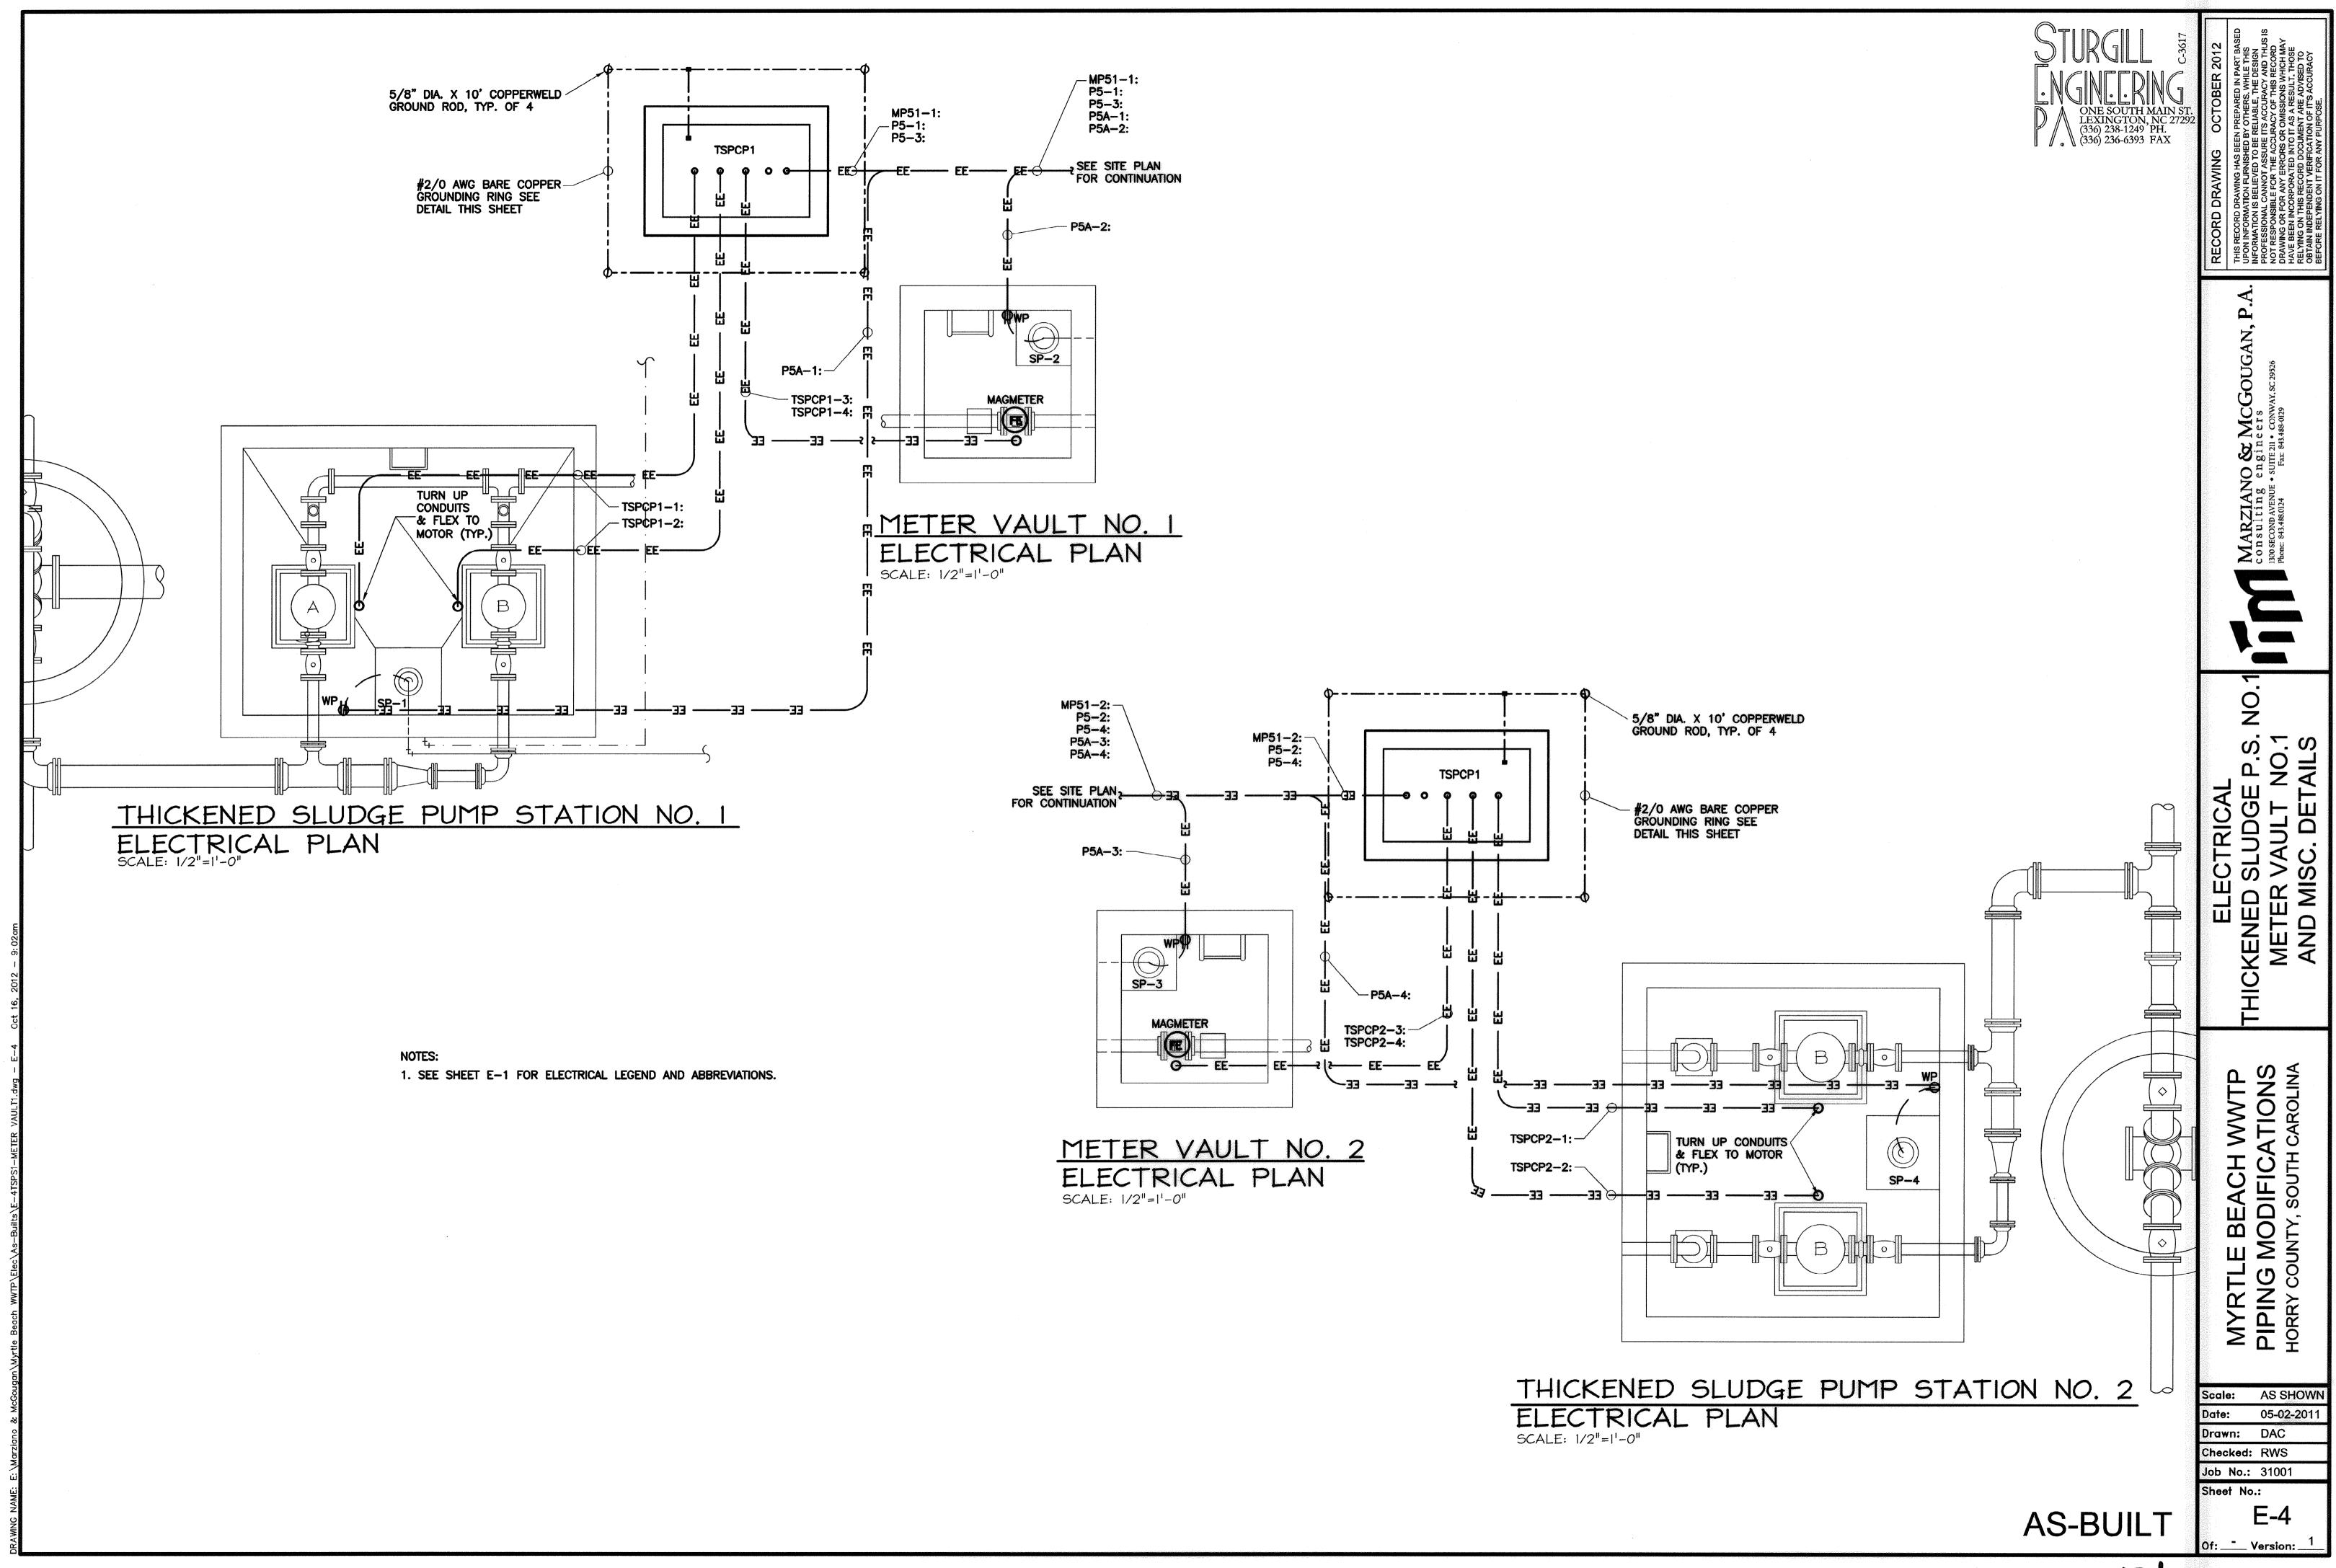

51-014-017/17