
TURF FARM FORCE MAIN DIVERSION

PROJECT NO. 805-02 AS BUILTS



GRAND STRAND WATER AND SEWER AUTHORITY



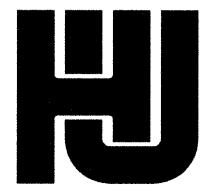

HOBBS, UPCHURCH & ASSOCIATES, P.A.

CONSULTING ENGINEERS

MYRTLE BEACH, SOUTH CAROLINA 29577

14-106-001/16-8


VICINITY MAP

INDEX OF SHEETS					
SHEET NO.	SHEET TITLE				
1	COVER SHEET				
2	VICINITY MAP AND INDEX				
3	TURF FARM FORCE MAIN LAYOUT MAP				
4 THRU 10	TURF FARM PLAN AND PROFILE SHEETS				
114 AND 11B	PUMP STATION PLAN AND DETAILS				
12	EFFLUENT FORCE MAIN LAYOUT MAP				
13	EFFLUENT PLAN AND PROFILE SHEET				
14	MISCELLANEOUS DETAILS				
15	MISCELLANEOUS DETAILS				
16	EROSION DETAILS				

NOTES:

- 1. WORK WITHIN PUBLIC RIGHT OF WAYS OR PRIVATE EASEMENTS SHALL BE ACCOMPLISHED BY THE CONTRACTOR ACCORDING TO THE REQUIREMENTS OR CONDITIONS OF THE ENCROACHMENT PERMIT OR OTHER LEGAL DOCUMENTS AS THOUGH THE DOCUMENTS WERE ISSUED IN THE CONTRACTORS NAME. THE CONTRACTOR SHALL MAINTAIN COPIES OF THESE DOCUMENTS ON THE SITE AT ALL TIMES, THE CONTRACTOR SHALL BE RESPONSIBLE FOR THE MAINTENANCE OF PUBLIC RIGHT-OFWAYS DURING CONSTRUCTION OF THE PROJECT AND UNTIL THE CONTRACTOR OBTAINS AND DELIVERS TO THE OWNER A WRITTEN SIGN-OFF FROM HORRY COUNTY AND/OR THE S.C.D.O.T. THAT THE PUBLIC AGENCY HAS ACCEPTED THE RIGHT-OF-WAY BACK FOR MAINTENANCE, FINAL PAYMENT AND RELEASE OF RETAINAGE WILL NOT BE MADE TO THE CONTRACTOR UNTIL WRITTEN SIGN-OFF HAS BEEN OBTAINED FROM THE APPROPRIATE PUBLIC AGENCY AND PROVIDED TO THE OWNER.
- 2. PROVISIONS SHALL BE MADE TO PREVENT EROSION AND SILTRATION CAUSED BY CONSTRUCTION. TEMPORARY GRASSING, HAY BALES, SILT FENCES OR OTHER METHODS CALLED FOR ON THE PLANS OR AS MAY BE REQUIRED, SHALL BE USED.
- 3. THE CONTRACTOR WILL BE RESPONSIBLE FOR VERIFYING THE LOCATION AND EXISTENCE OF ALL UNDERGROUND UTILITIES. LOCATION OF UTILITIES ON THE PLANS, WHETHER FULLY AND CORRECTLY LOCATED OR OMITTED WILL NOT RELIEVE THE CONTRACTOR OF THE RESPONSIBILITY OR LIABILITY FOR DAMAGE TO UTILITIES. THE CONTRACTOR WILL BE RESPONSIBLE FOR CONTACTING LOCAL UTILITIES FOR ASSISTANCE IN LOCATING UTILITIES. THE CONTRACTOR MUST FULLY COMPLY WITH THE SOUTH CAROLINA UNDERGROUND UTILITIES DAMAGE PREVENTION ACT, GENERAL STATUTES 58-35, SECTIONS 20 THROUGH 120.
- 4. WHEN THE CONTRACTOR IS UNABLE TO COMPLETE HIS WORK AS SHOWN ON THE PLANS BECAUSE OF AN EXISTING UTILITY, THE CONTRACTOR SHALL STAKE THE LOCATION OF THE UTILITY PRIOR TO PROCEEDING AND CONTACT THE ENGINEER.
- 5. THE CONTRACTOR SHALL NOTIFY ALL PUBLIC AGENCIES, THE OWNER,
 THE ENGINEER AND ALL OTHER CONCERNED PARTIES WHEN CONSTRUCTION
 IS TO COMMENCE SO THAT INSPECTIONS AND OTHER SITE VISITS MAY
 BE SCHEDULED.
- 6. DATA REQUIRED FOR PREPARATION OF ASBUILT DRAWINGS SHALL BE OBTAINED BY THE CONTRACTOR AT THE TIME OF INSTALLATION. THIS DATA SHALL BE ACCUMULATED BY THE CONTRACTOR AND COORDINATED WITH THE PROJECT INSPECTOR ON A DAILY BASIS DURING THE CONSTRUCTION PERIOD AND BE SUBMITTED TO THE PROJECT INSPECTOR IN A NEAT AND LEGIBLE MANNER AFTER COMPLETION OF THE PROJECT.
- T. ALL WORK SHALL BE IN ACCORDANCE WITH THE APPLICABLE FEDERAL, STATE AND LOCAL ORDINANCES, REGULATIONS, SPECIFICATIONS, AND PERMITS.
- 8. SPECIAL NOTE: PRIOR TO ANY EXCAVATION THE CONTRACTOR IS REQUIRED TO CONTACT HORRY TELEPHONE COOPERATIVE FOR CABLE LOCATIONS AT 365-2151. THIS PROJECT INVOLVES SEVERAL CABLE LINES LOCATED ADJACENT TO THE ROADWAY THAT THE CONTRACTOR WILL BE REQUIRED TO LOCATE AND EXPOSE PRIOR TO THE INSTALLATION OF ANY MATERIALS.
- 9. REPLACE IN KIND ALL AREAS WHERE THE PROPERTY OWNER HAS DEVELOPED SPECIAL GRASS, TURF, OR LANDSCAPING. ALL DISTURBED AREAS ARE TO BE RAKED AND SEEDED.
- 10. PIPE SEPARATION: THE FOLLOWING MINIMUM PIPE SEPARATION WILL BE MAINTAINED: 12 INCHES VERTICAL SEPARATION BETWEEN CROSSING OF SANITARY SEWER AND STORM SEWERS. 18 INCHES VERTICAL SEPARATION BETWEEN CROSSING OF SEWER (INCLUDING FORCE MAINS) AND WATER MAINS. AND 10 FEET HORIZONTAL SEPARATION BETWEEN SANITARY SEWER (INCLUDING FORCE MAINS) AND WATER MAINS. IF THESE SEPARATIONS CANNOT BE MAINTAINED. DUCTILE IRON PIPE WILL BE USED 10 FEET EITHER SIDE OF CROSSING AND ALONG ENTIRE LENGTH OF LINE LESS THAN 10 HORIZONTAL FEET FROM WATER MAINS. THE CONTRACTOR SHALL RECEIVE APPROYAL FROM THE ENGINEER BEFORE PAYMENT WILL BE MADE AT DUCTILE IRON PRICES.
- 11. ALL REQUESTS FOR CHANGES AND/OR MODIFICATIONS SHALL BE SUBMITTED THROUGH THE INSPECTOR TO THE ENGINEER AND OWNER FOR APPROVAL PRIOR TO PROCEEDING WITH ANY MODIFICATIONS OR ADDITIONS.
- 12. MECHANICAL RESTRAINTS SHALL BE USED ON FITTINGS AND JOINTS PER GSW&SA STANDARDS.
- 13. ALL DISTURBED DRIVES SHALL BE RECONSTRUCTED ACCORDING TO SCDOT SPECIFICATIONS.

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	DATE	66/90				
REVISIONS	DESCRIPTION	AS BUILTS				
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OBBS, UPCHURCH & ASSOCIATES, P., CONSULTING ENGINEERS MYRTLE BEACH, SOUTH CAROLINA 28577
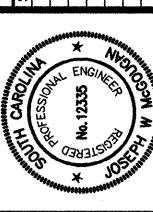
> VICINITY MAP INDEX

TURF FARM

-ORCE MAIN DIVERSION
GRAND STRAND WATER
AND SEWER AUTHORITY

	v
DATE:	1996
DESIGNED:	HUA
DRAWN:	BEB
CHECKED:	JWM
SCALE:	AS SHOWN
SHEET NO.	

16





MARCH, 1998 DESIGNED: WDL/BEB


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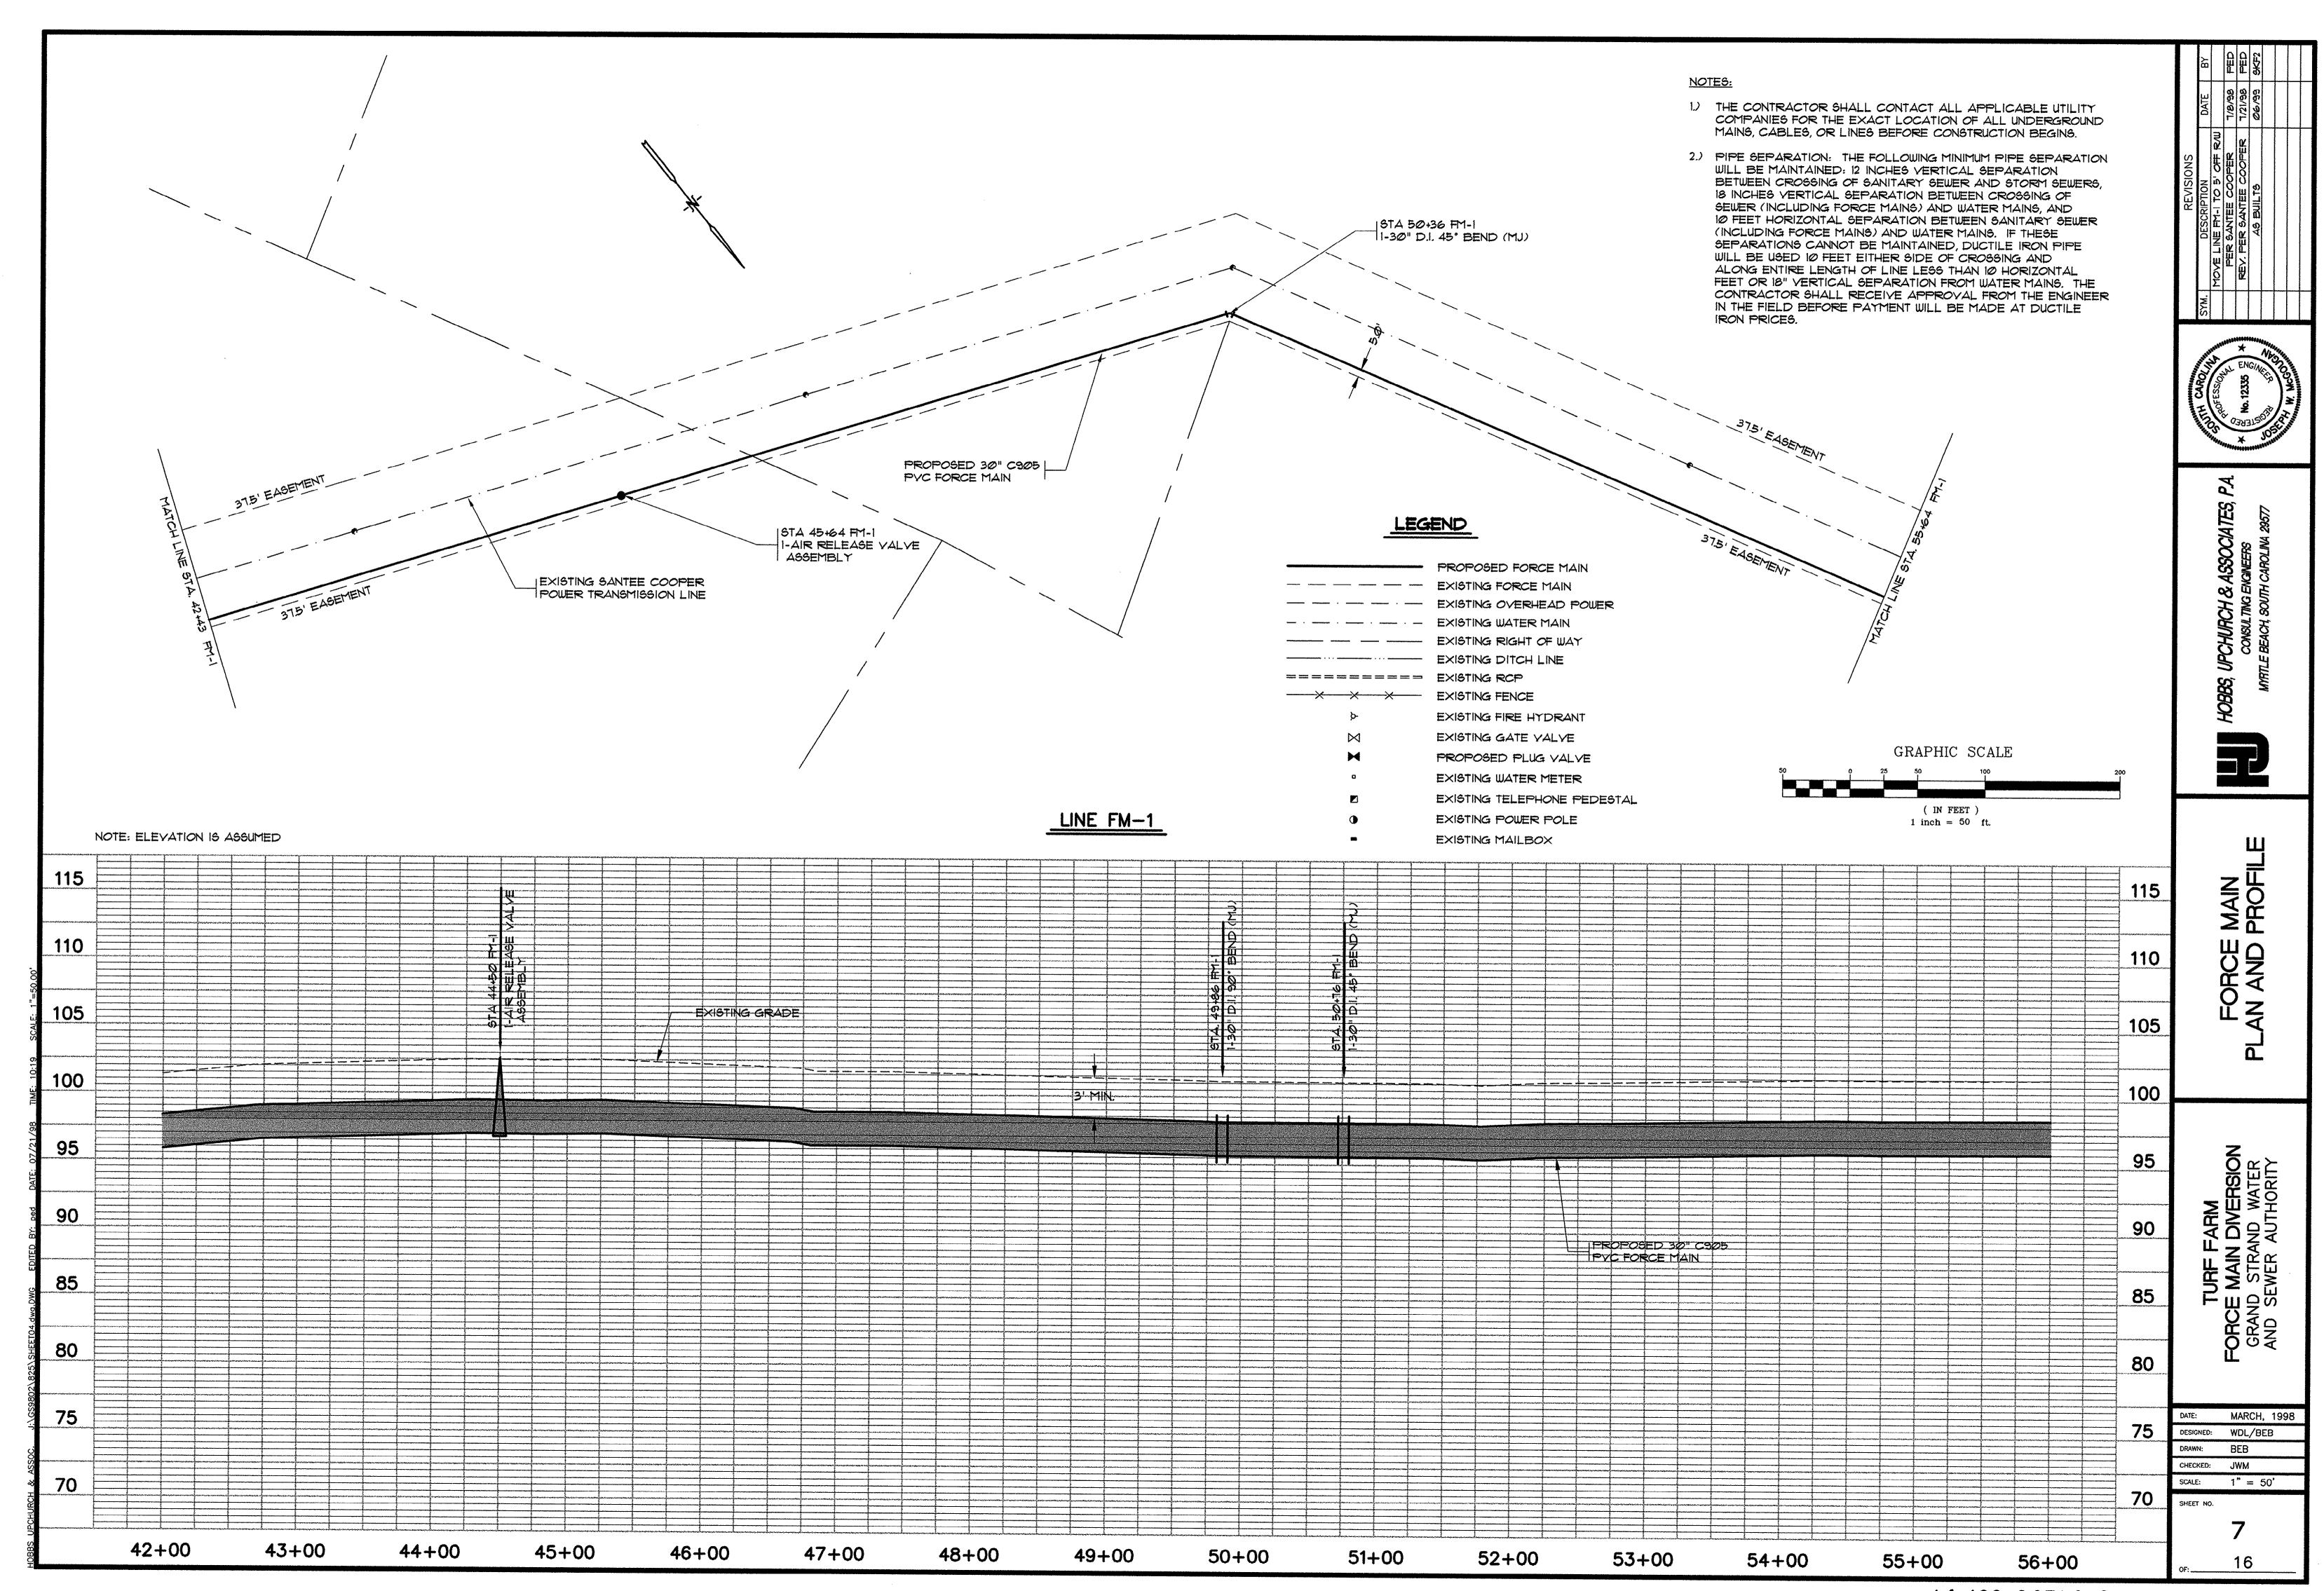
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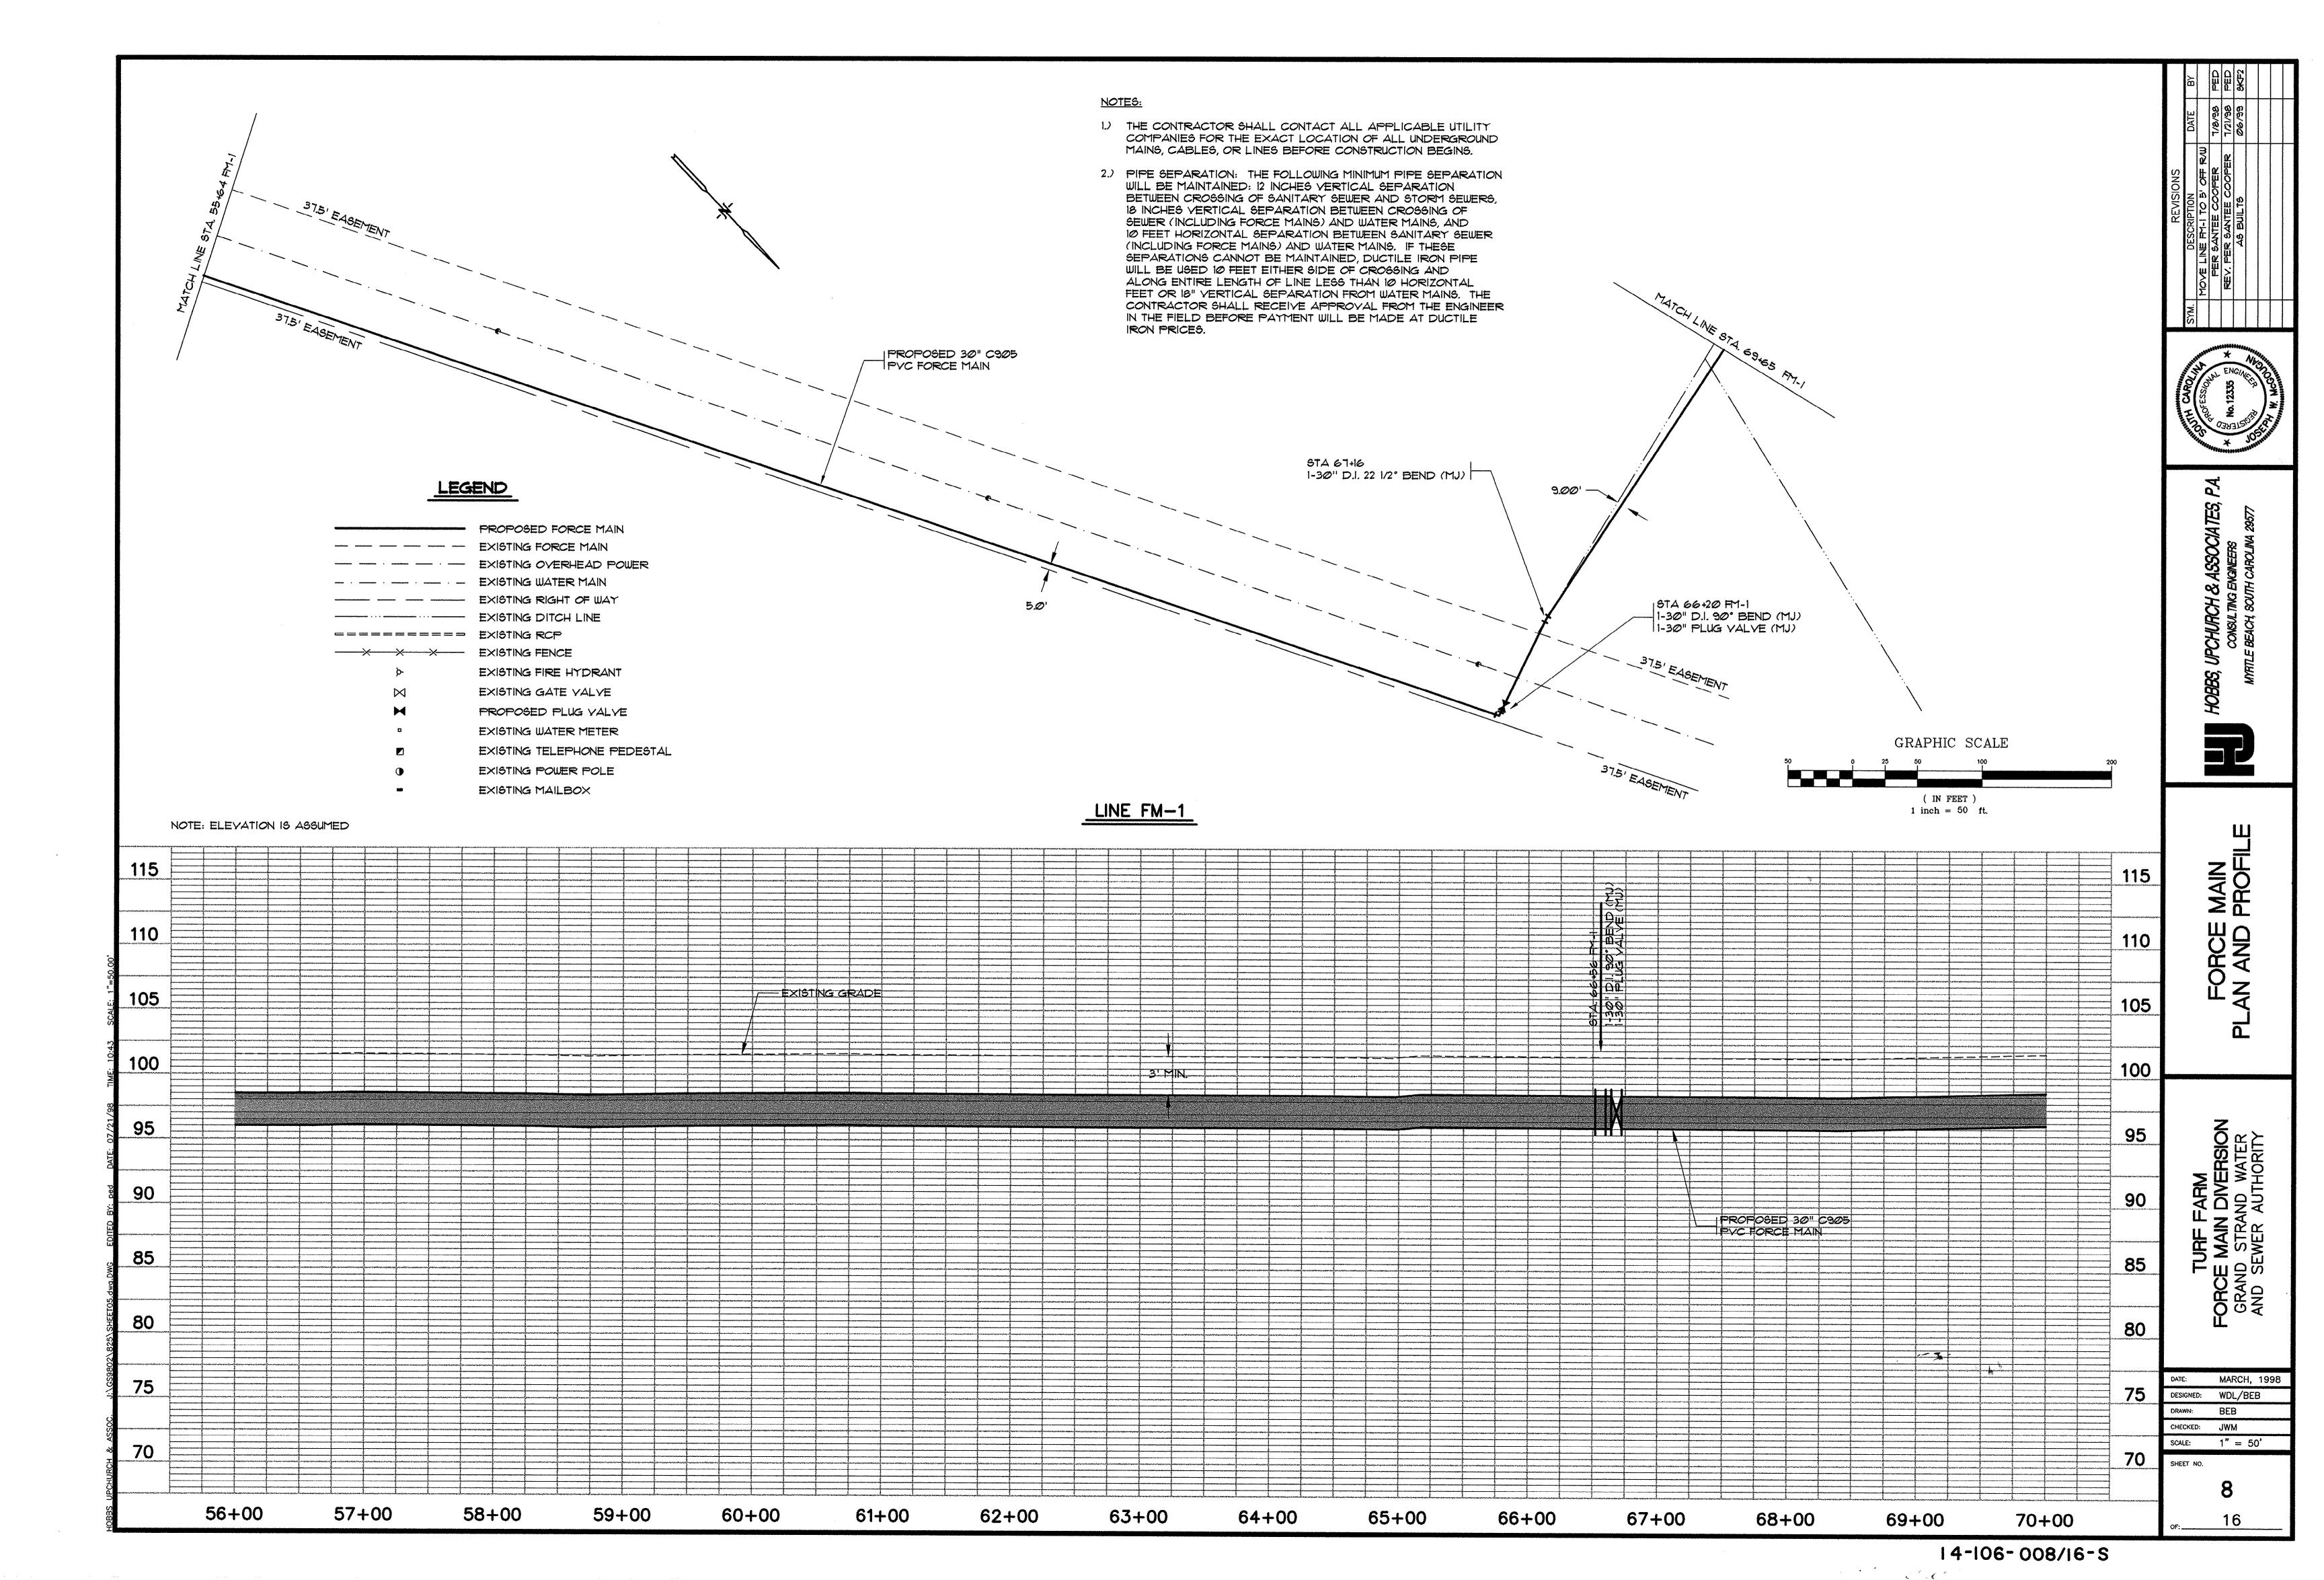
CHECKED: JWM







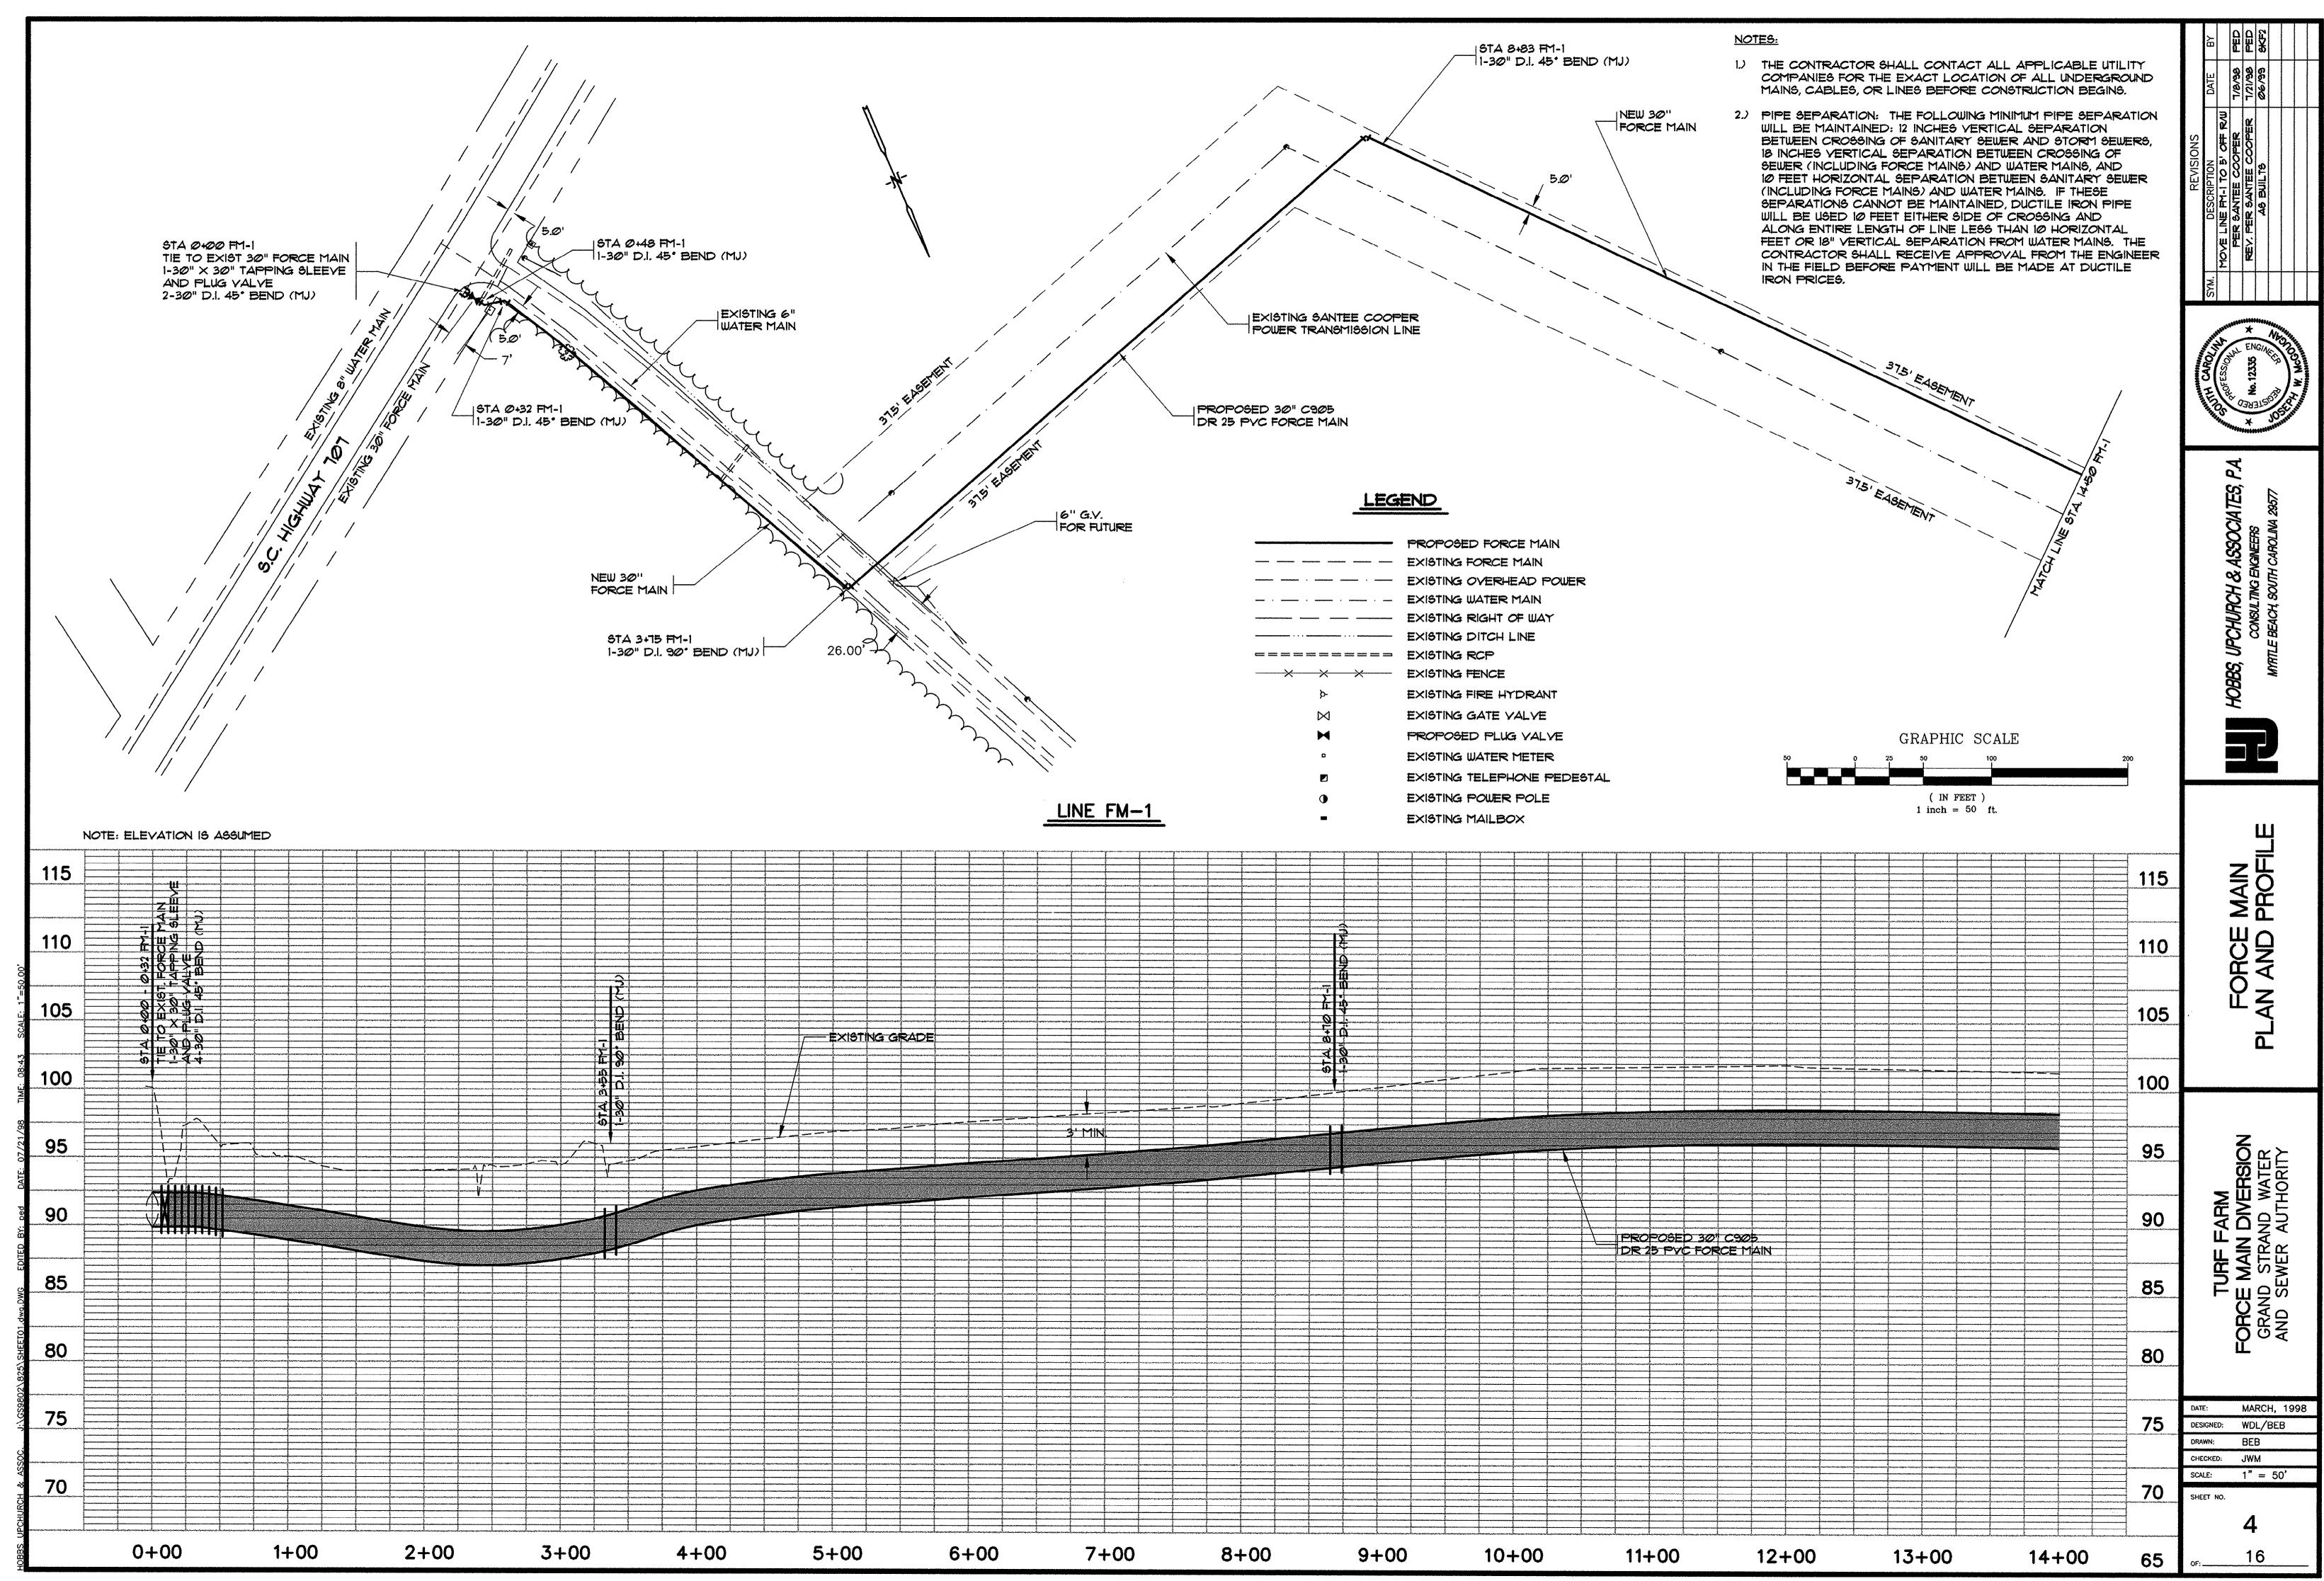


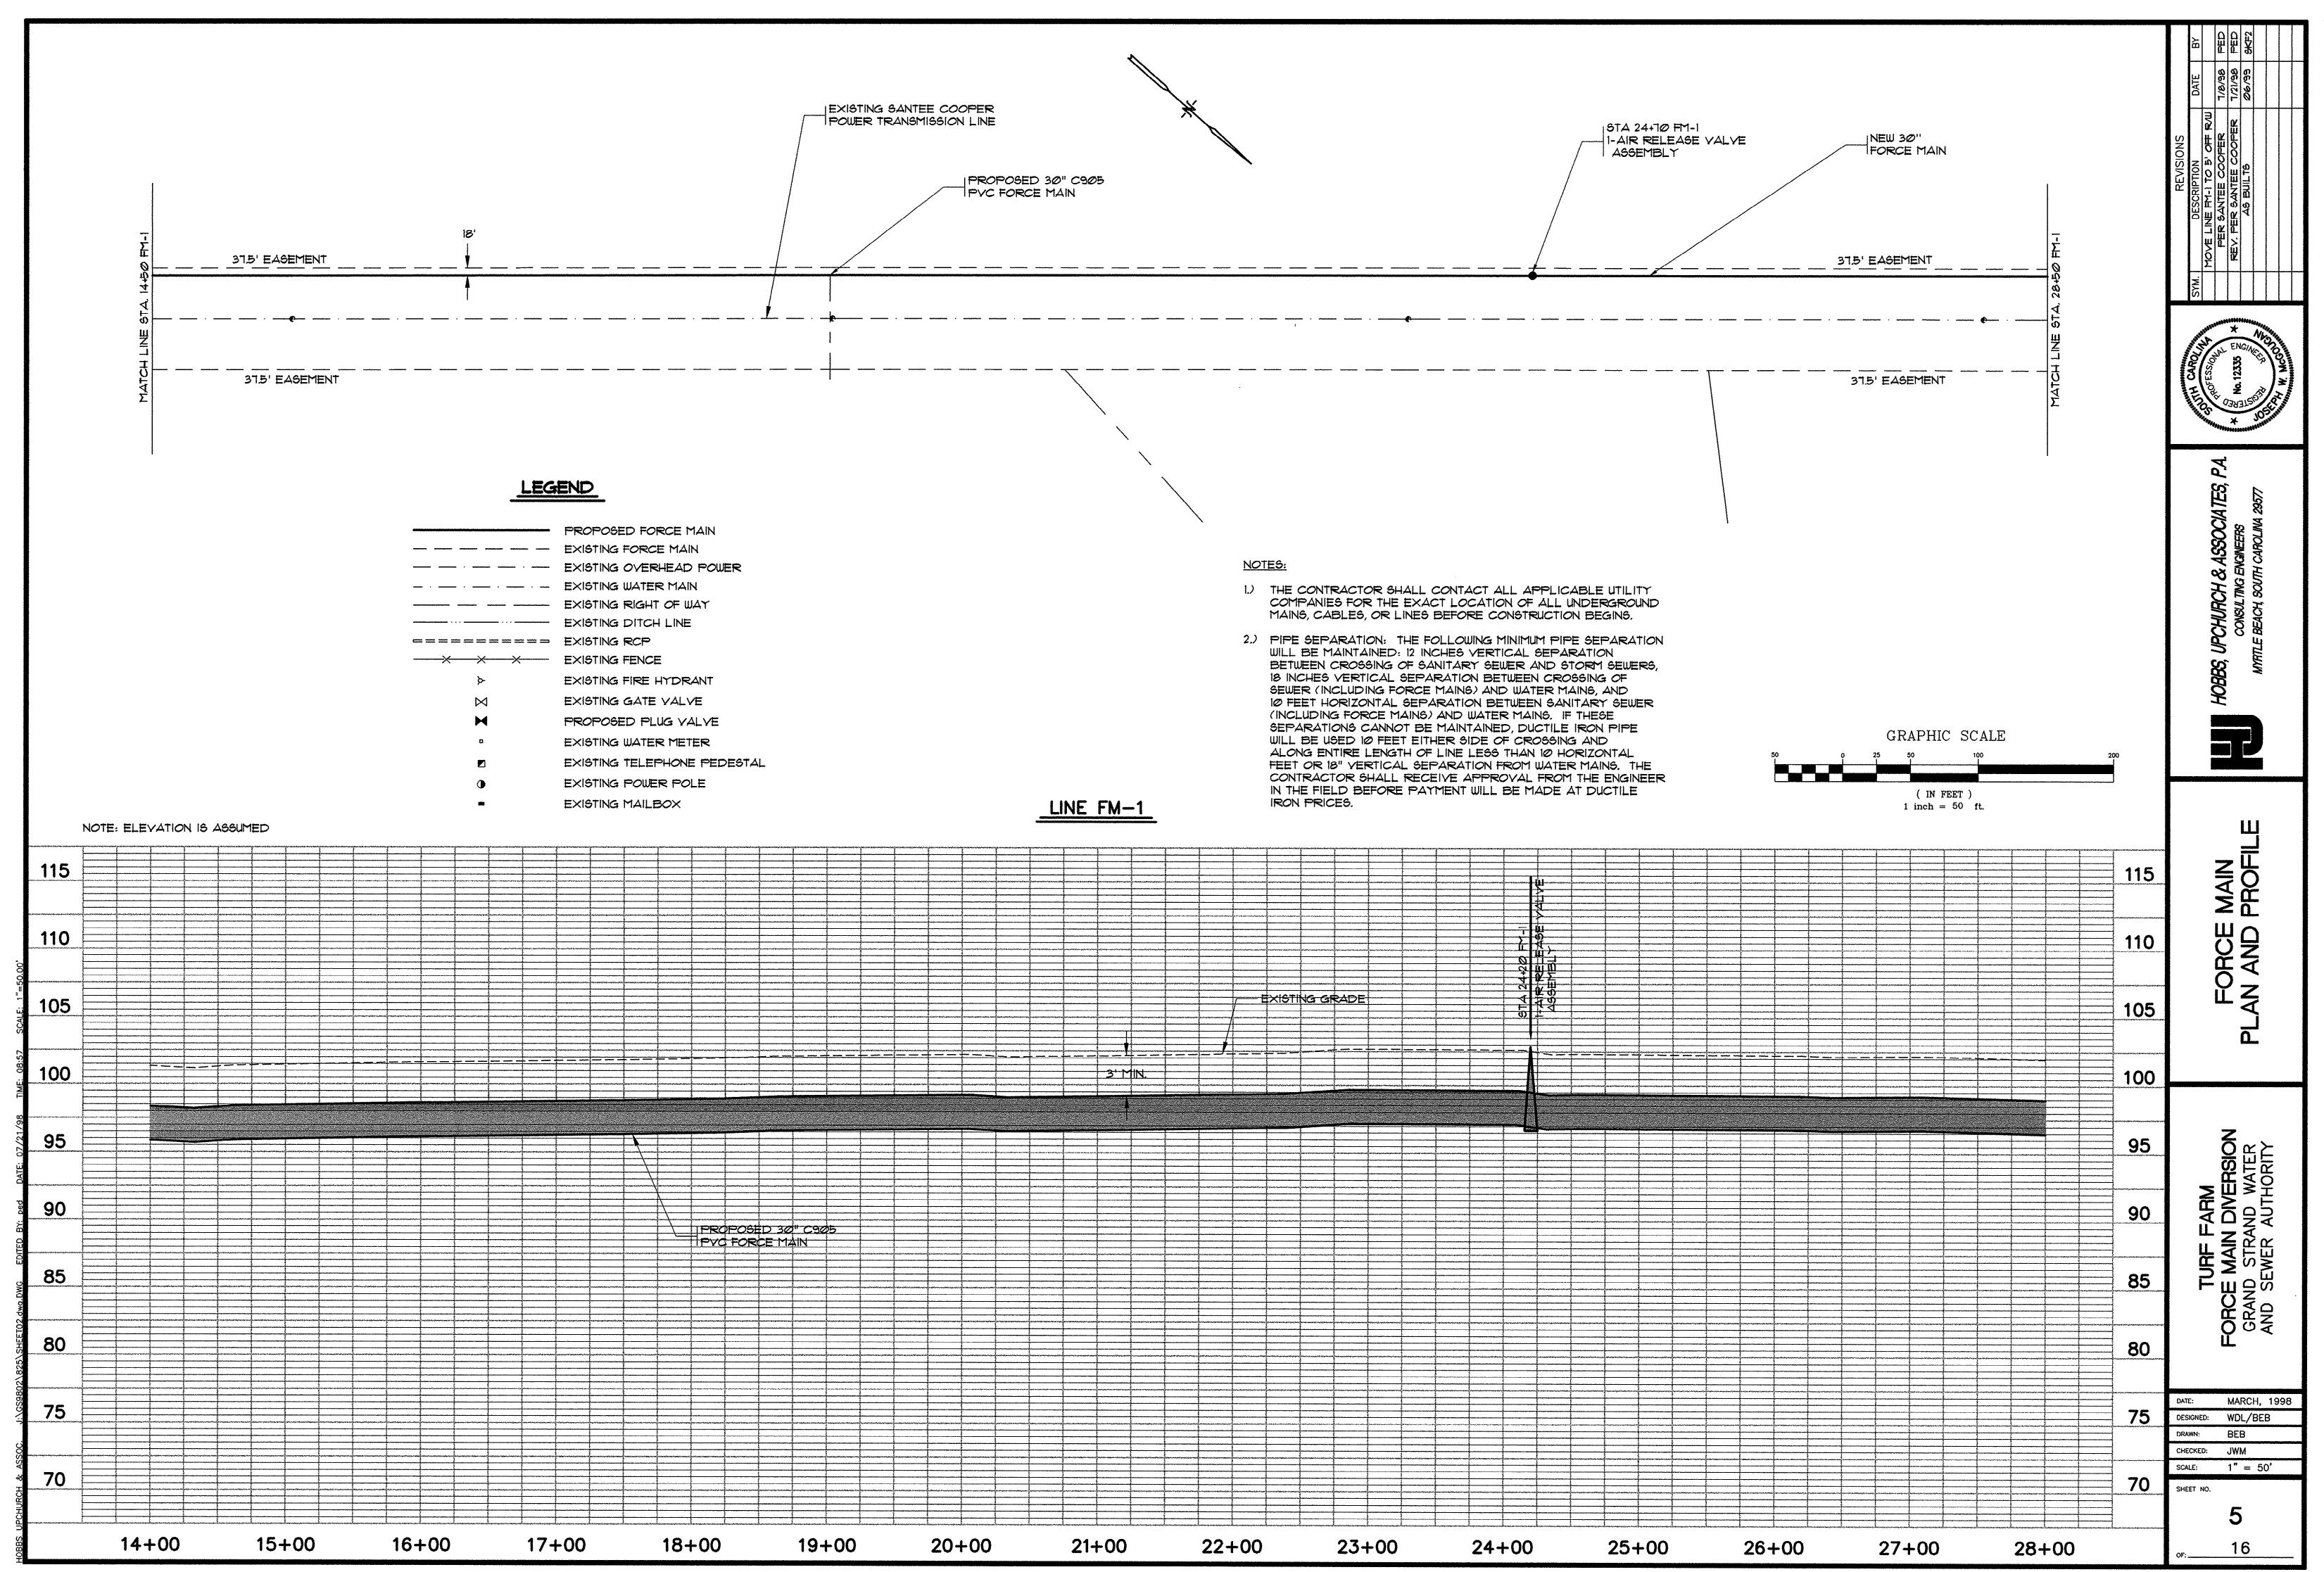

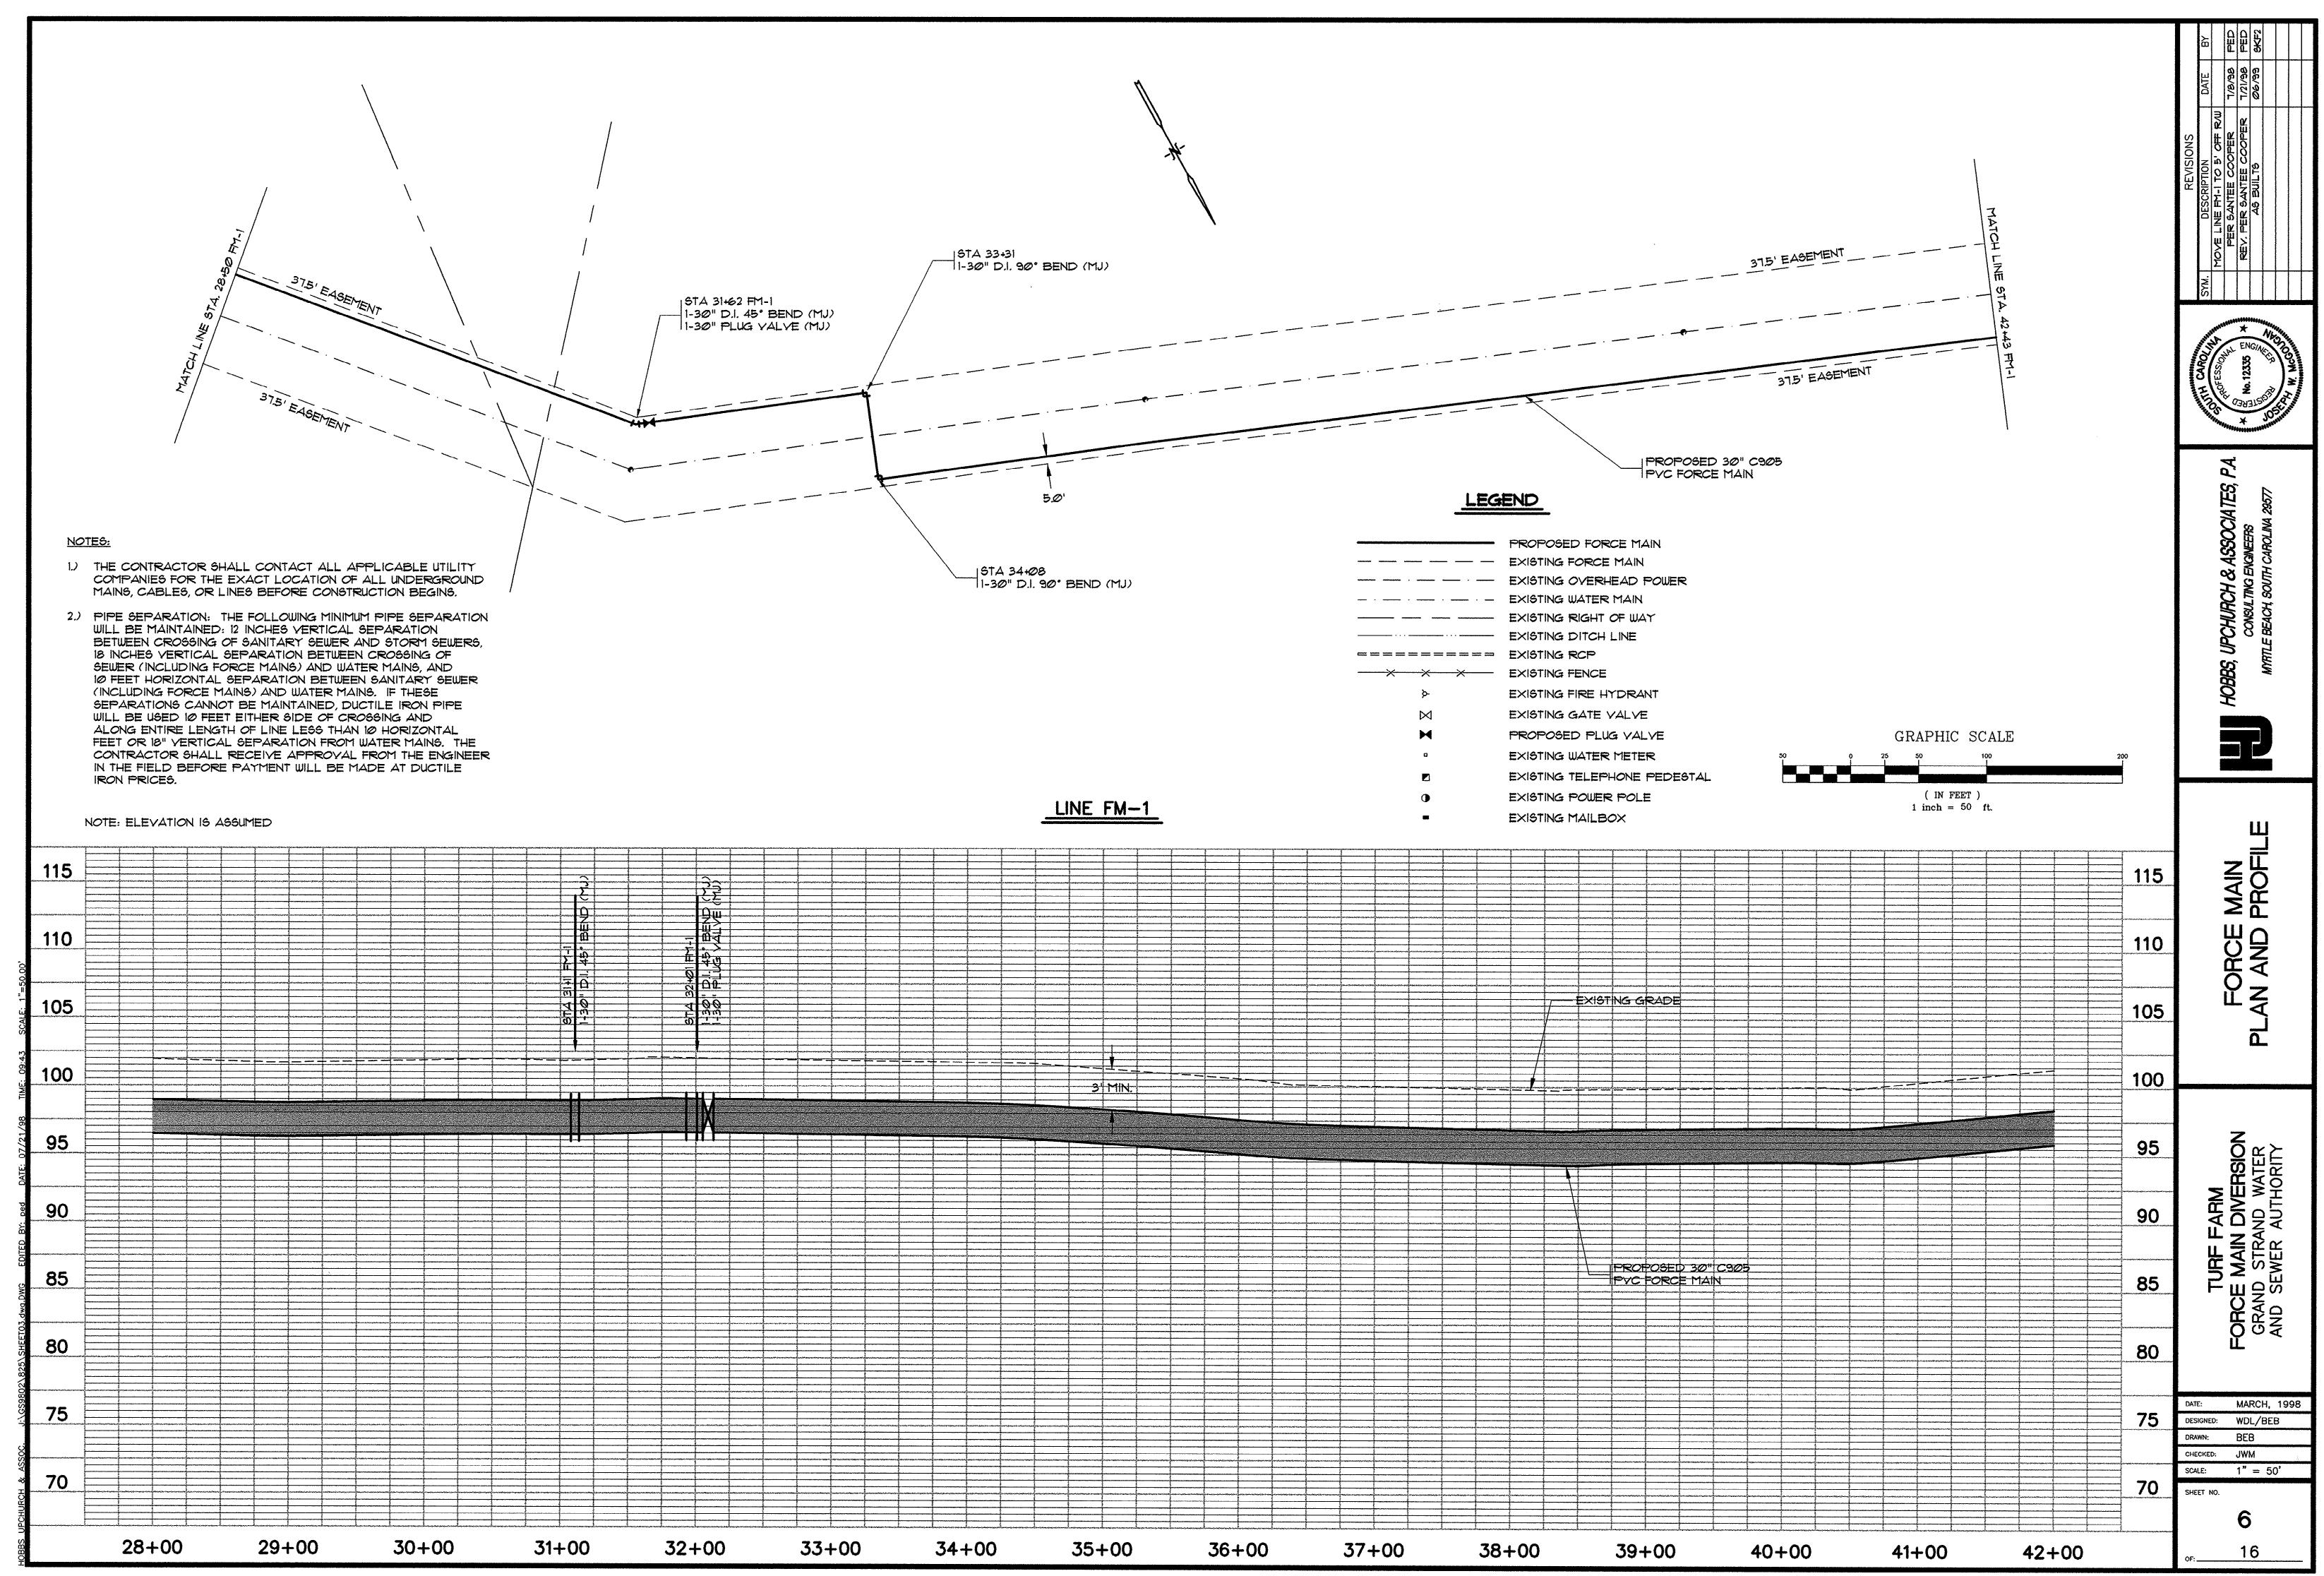


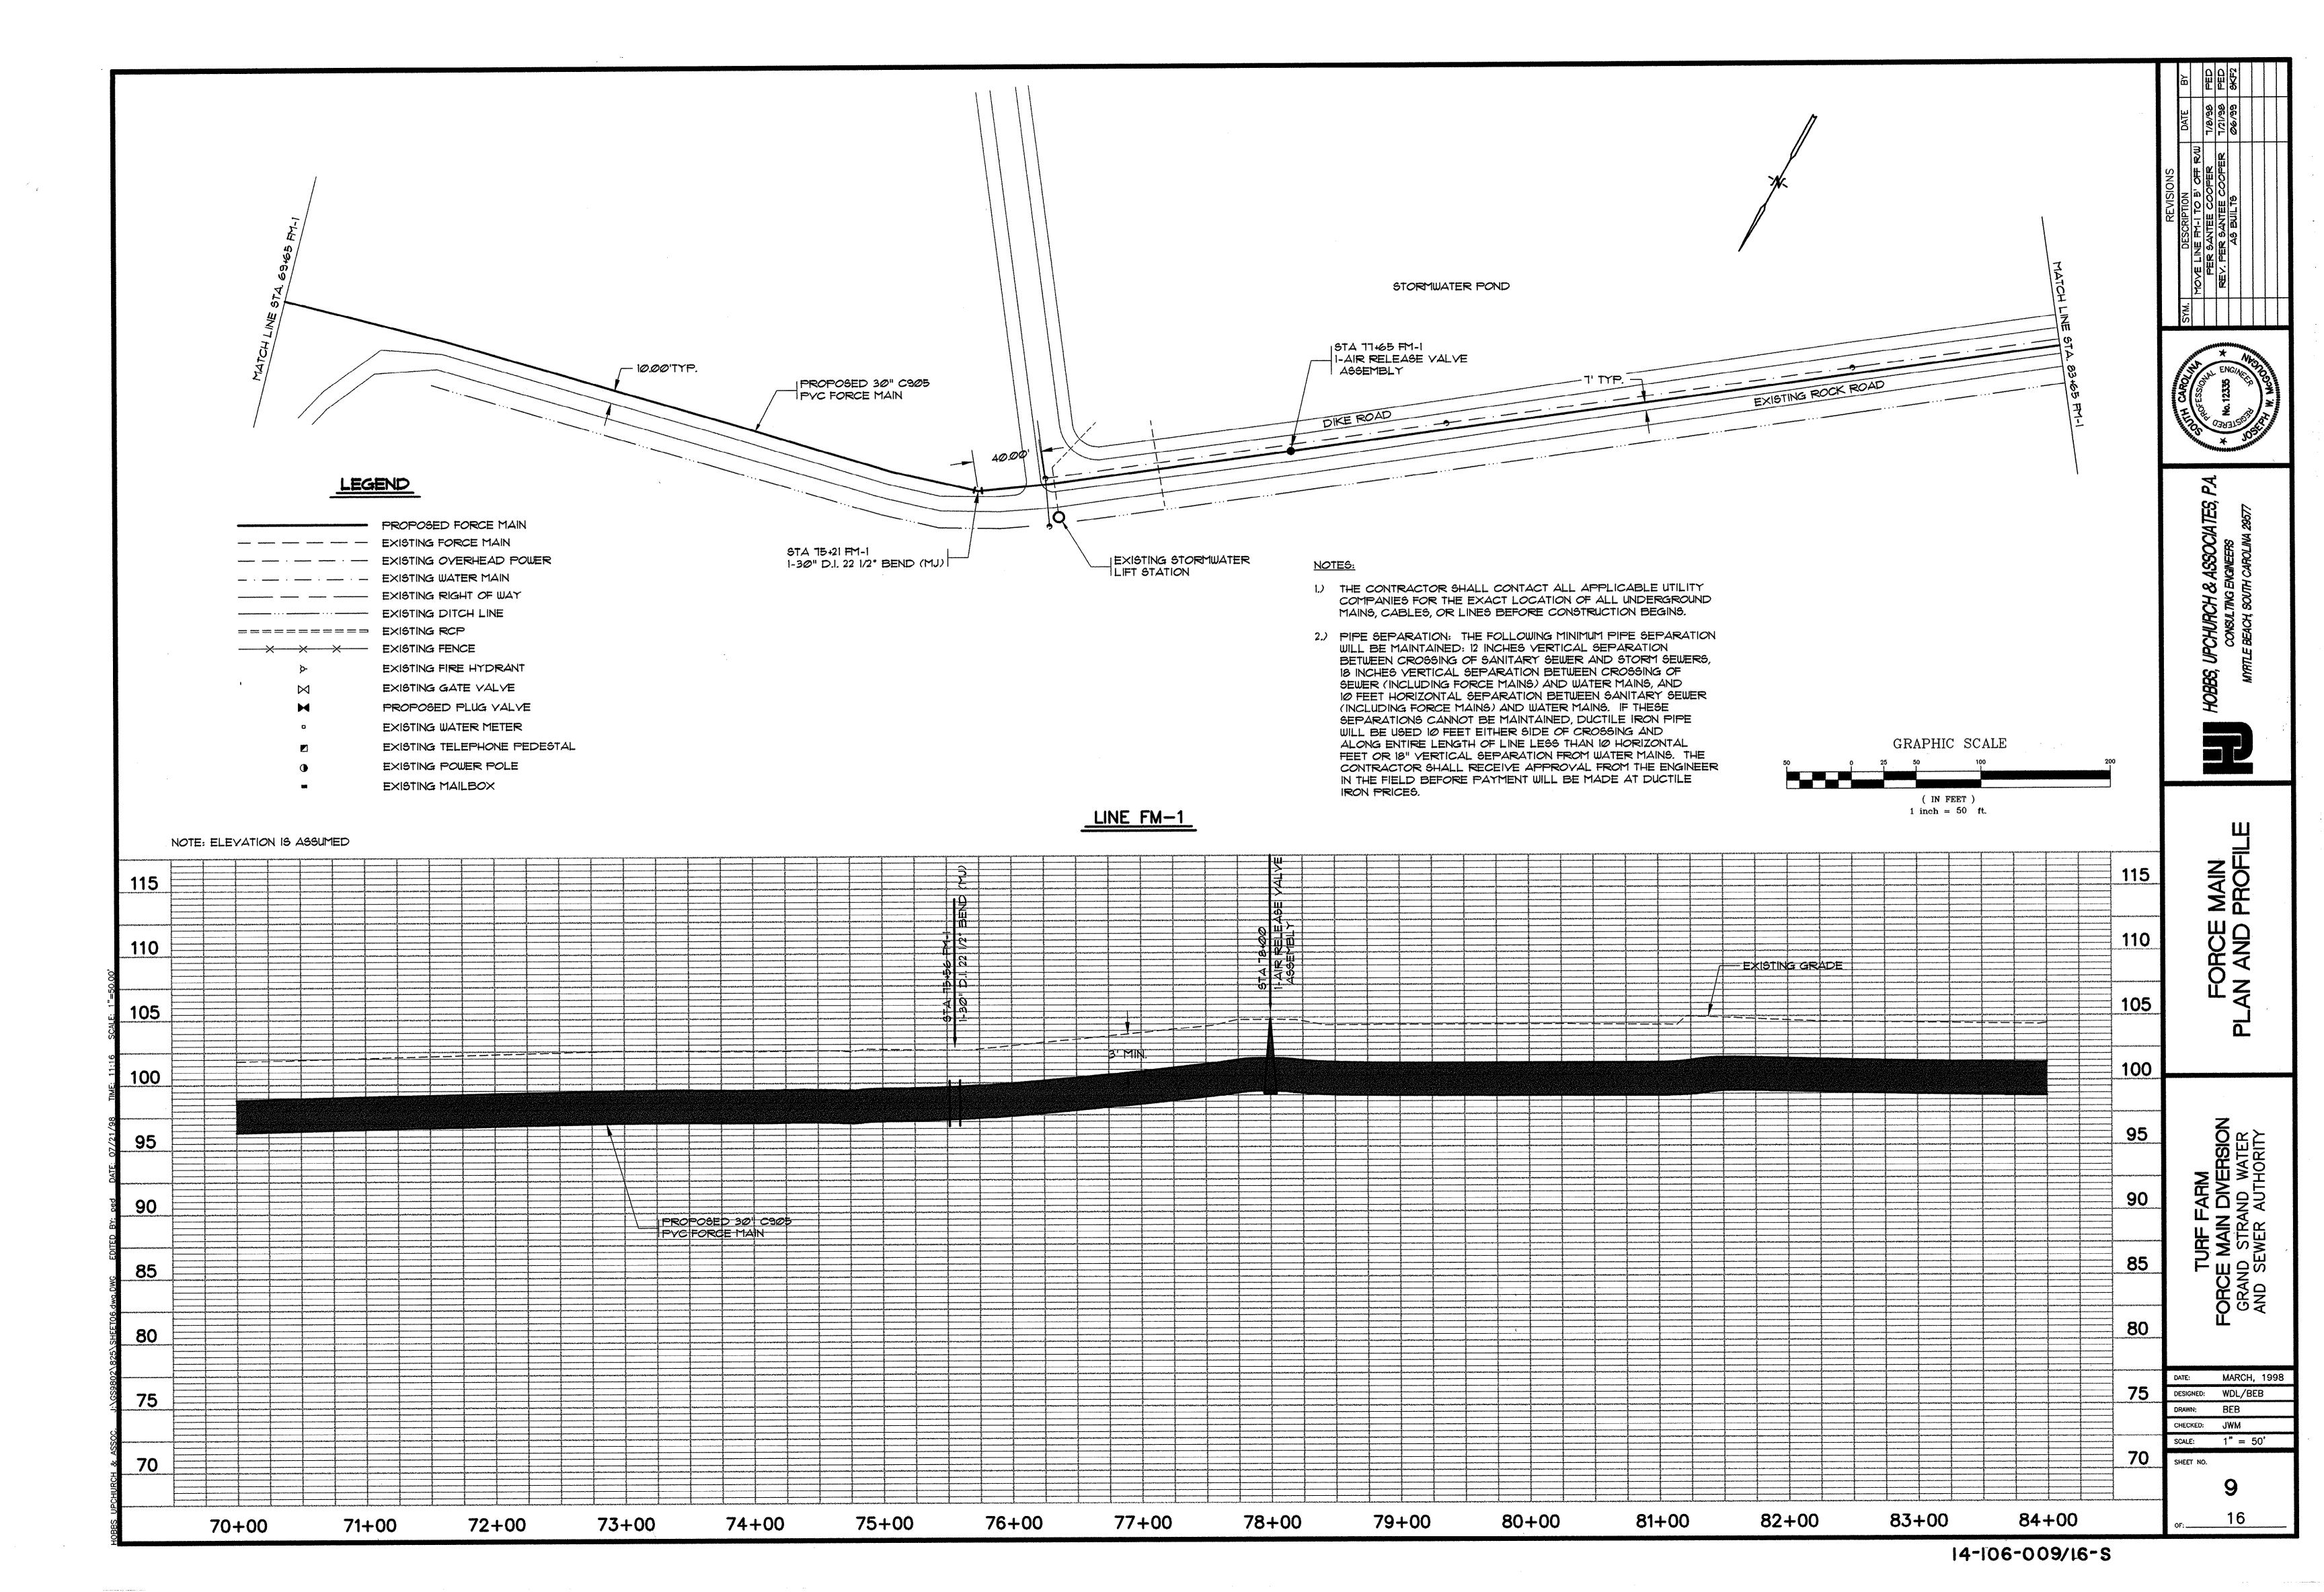


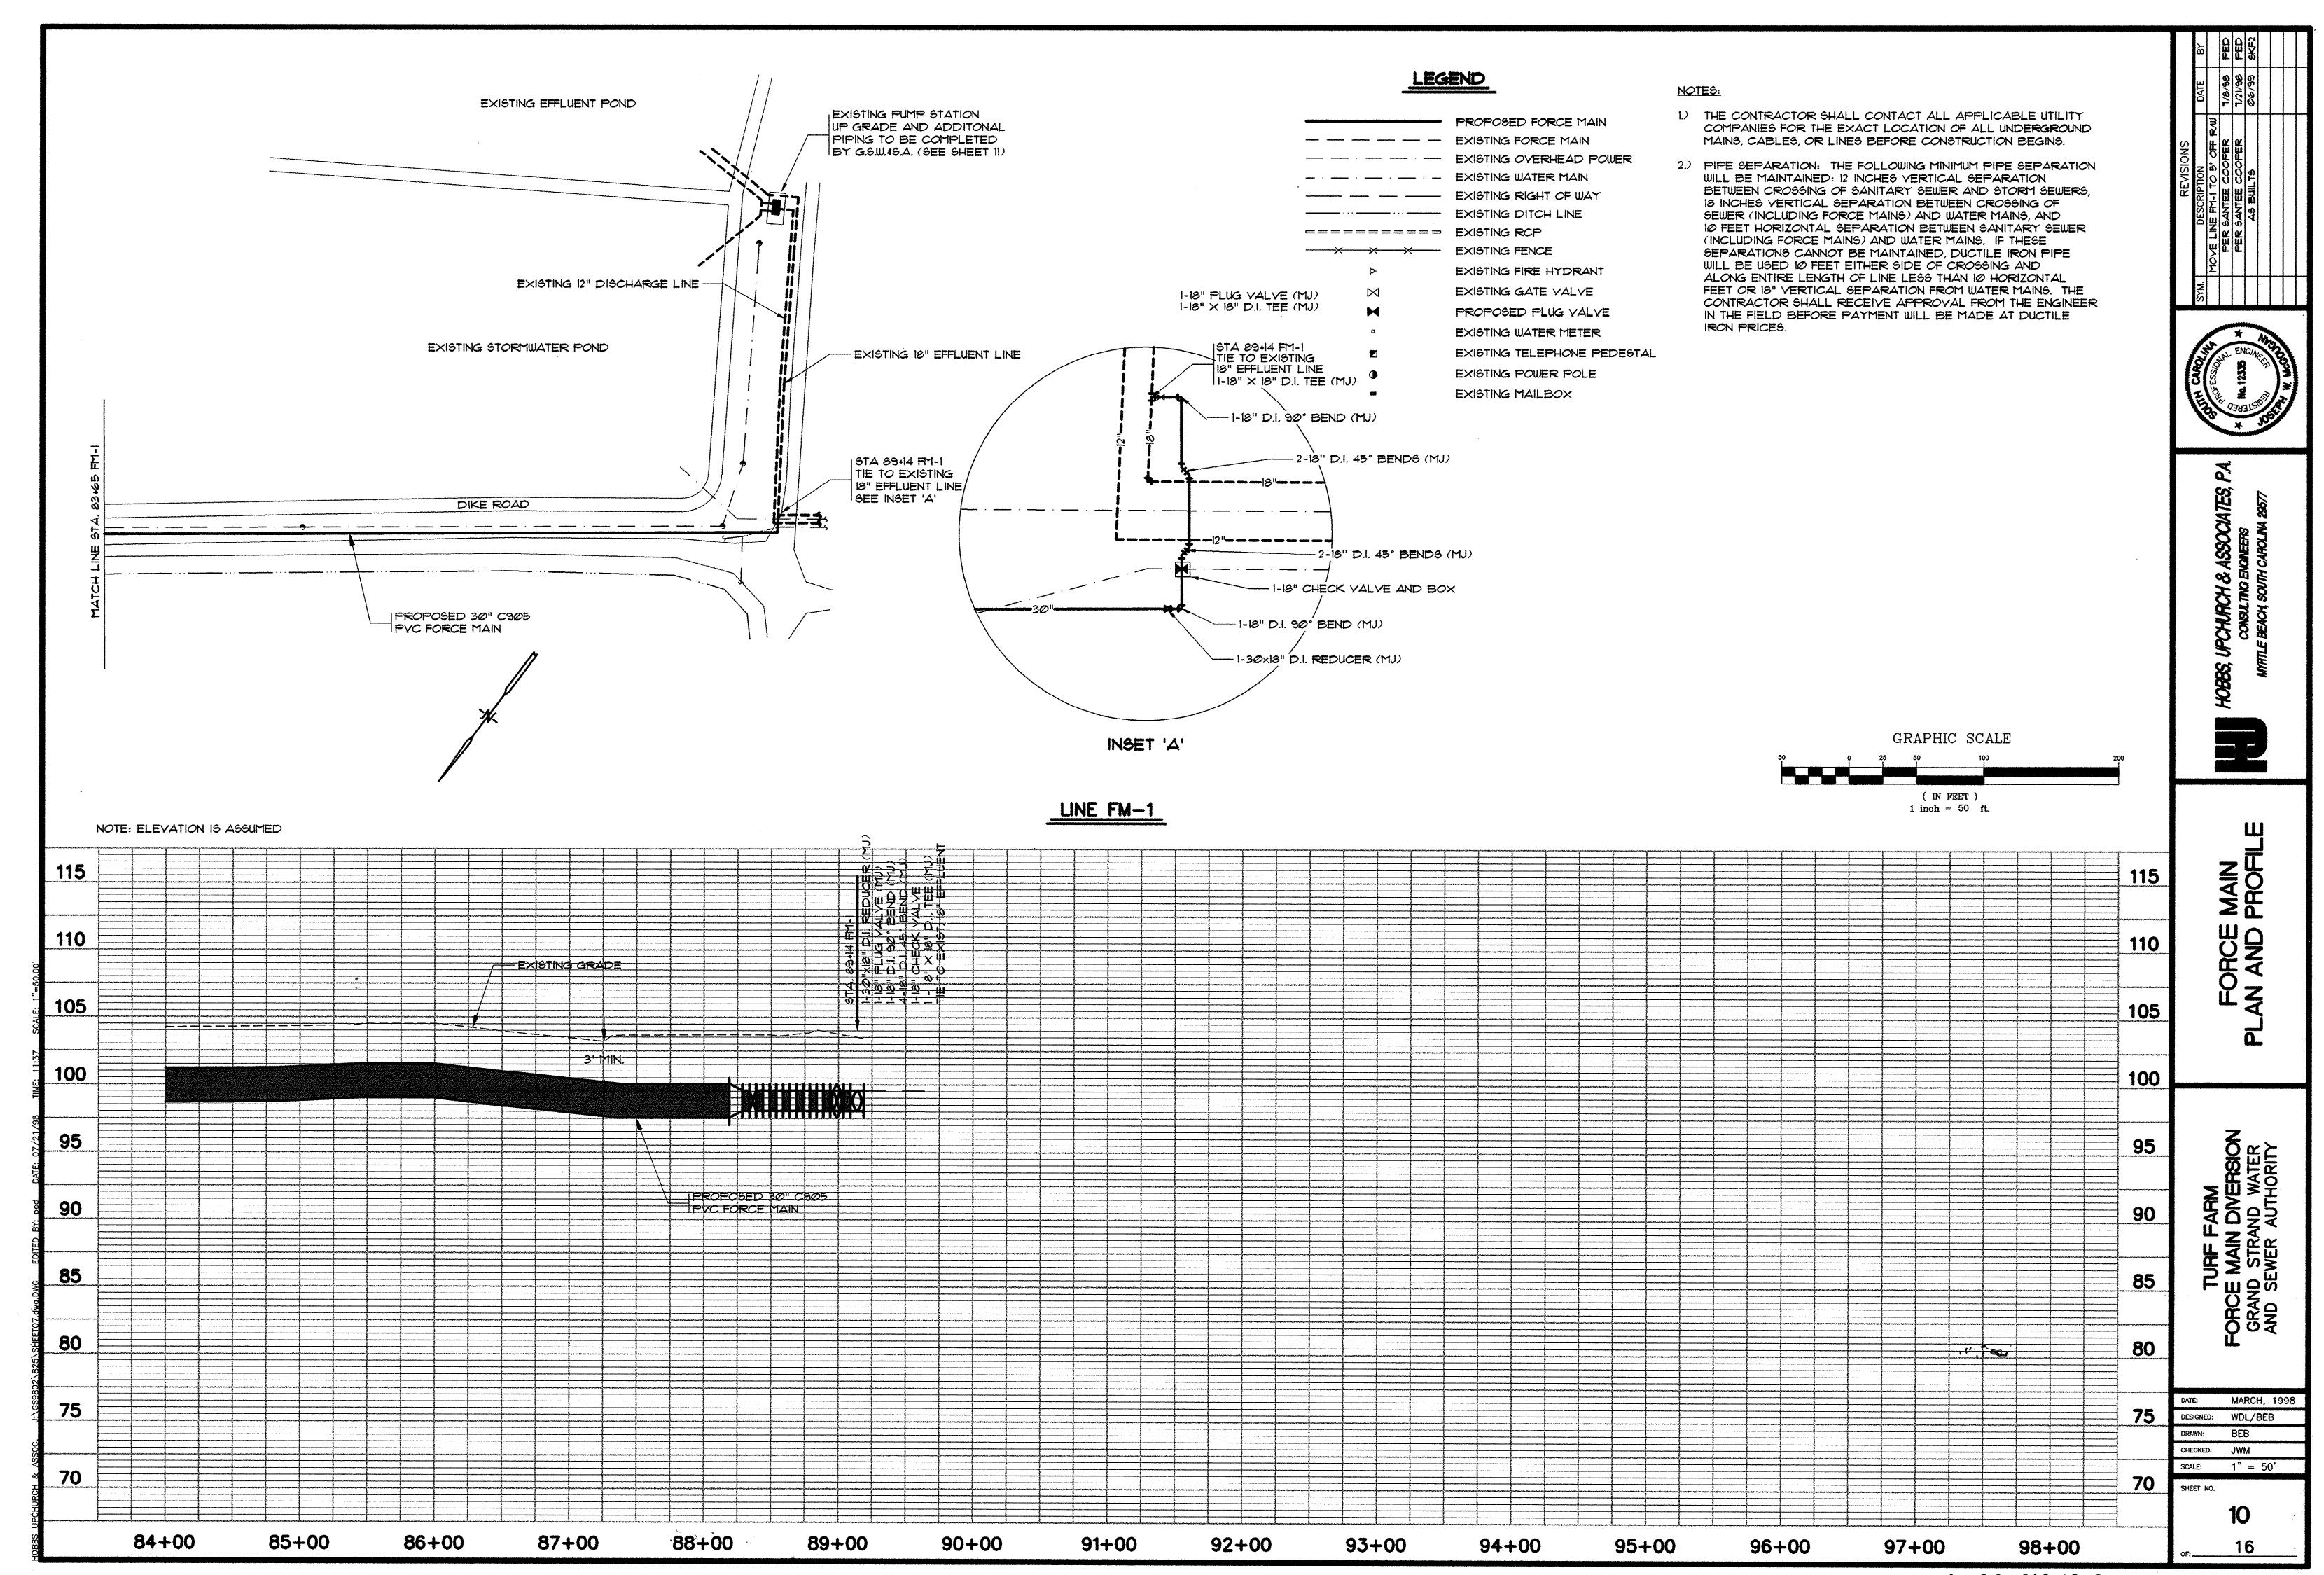

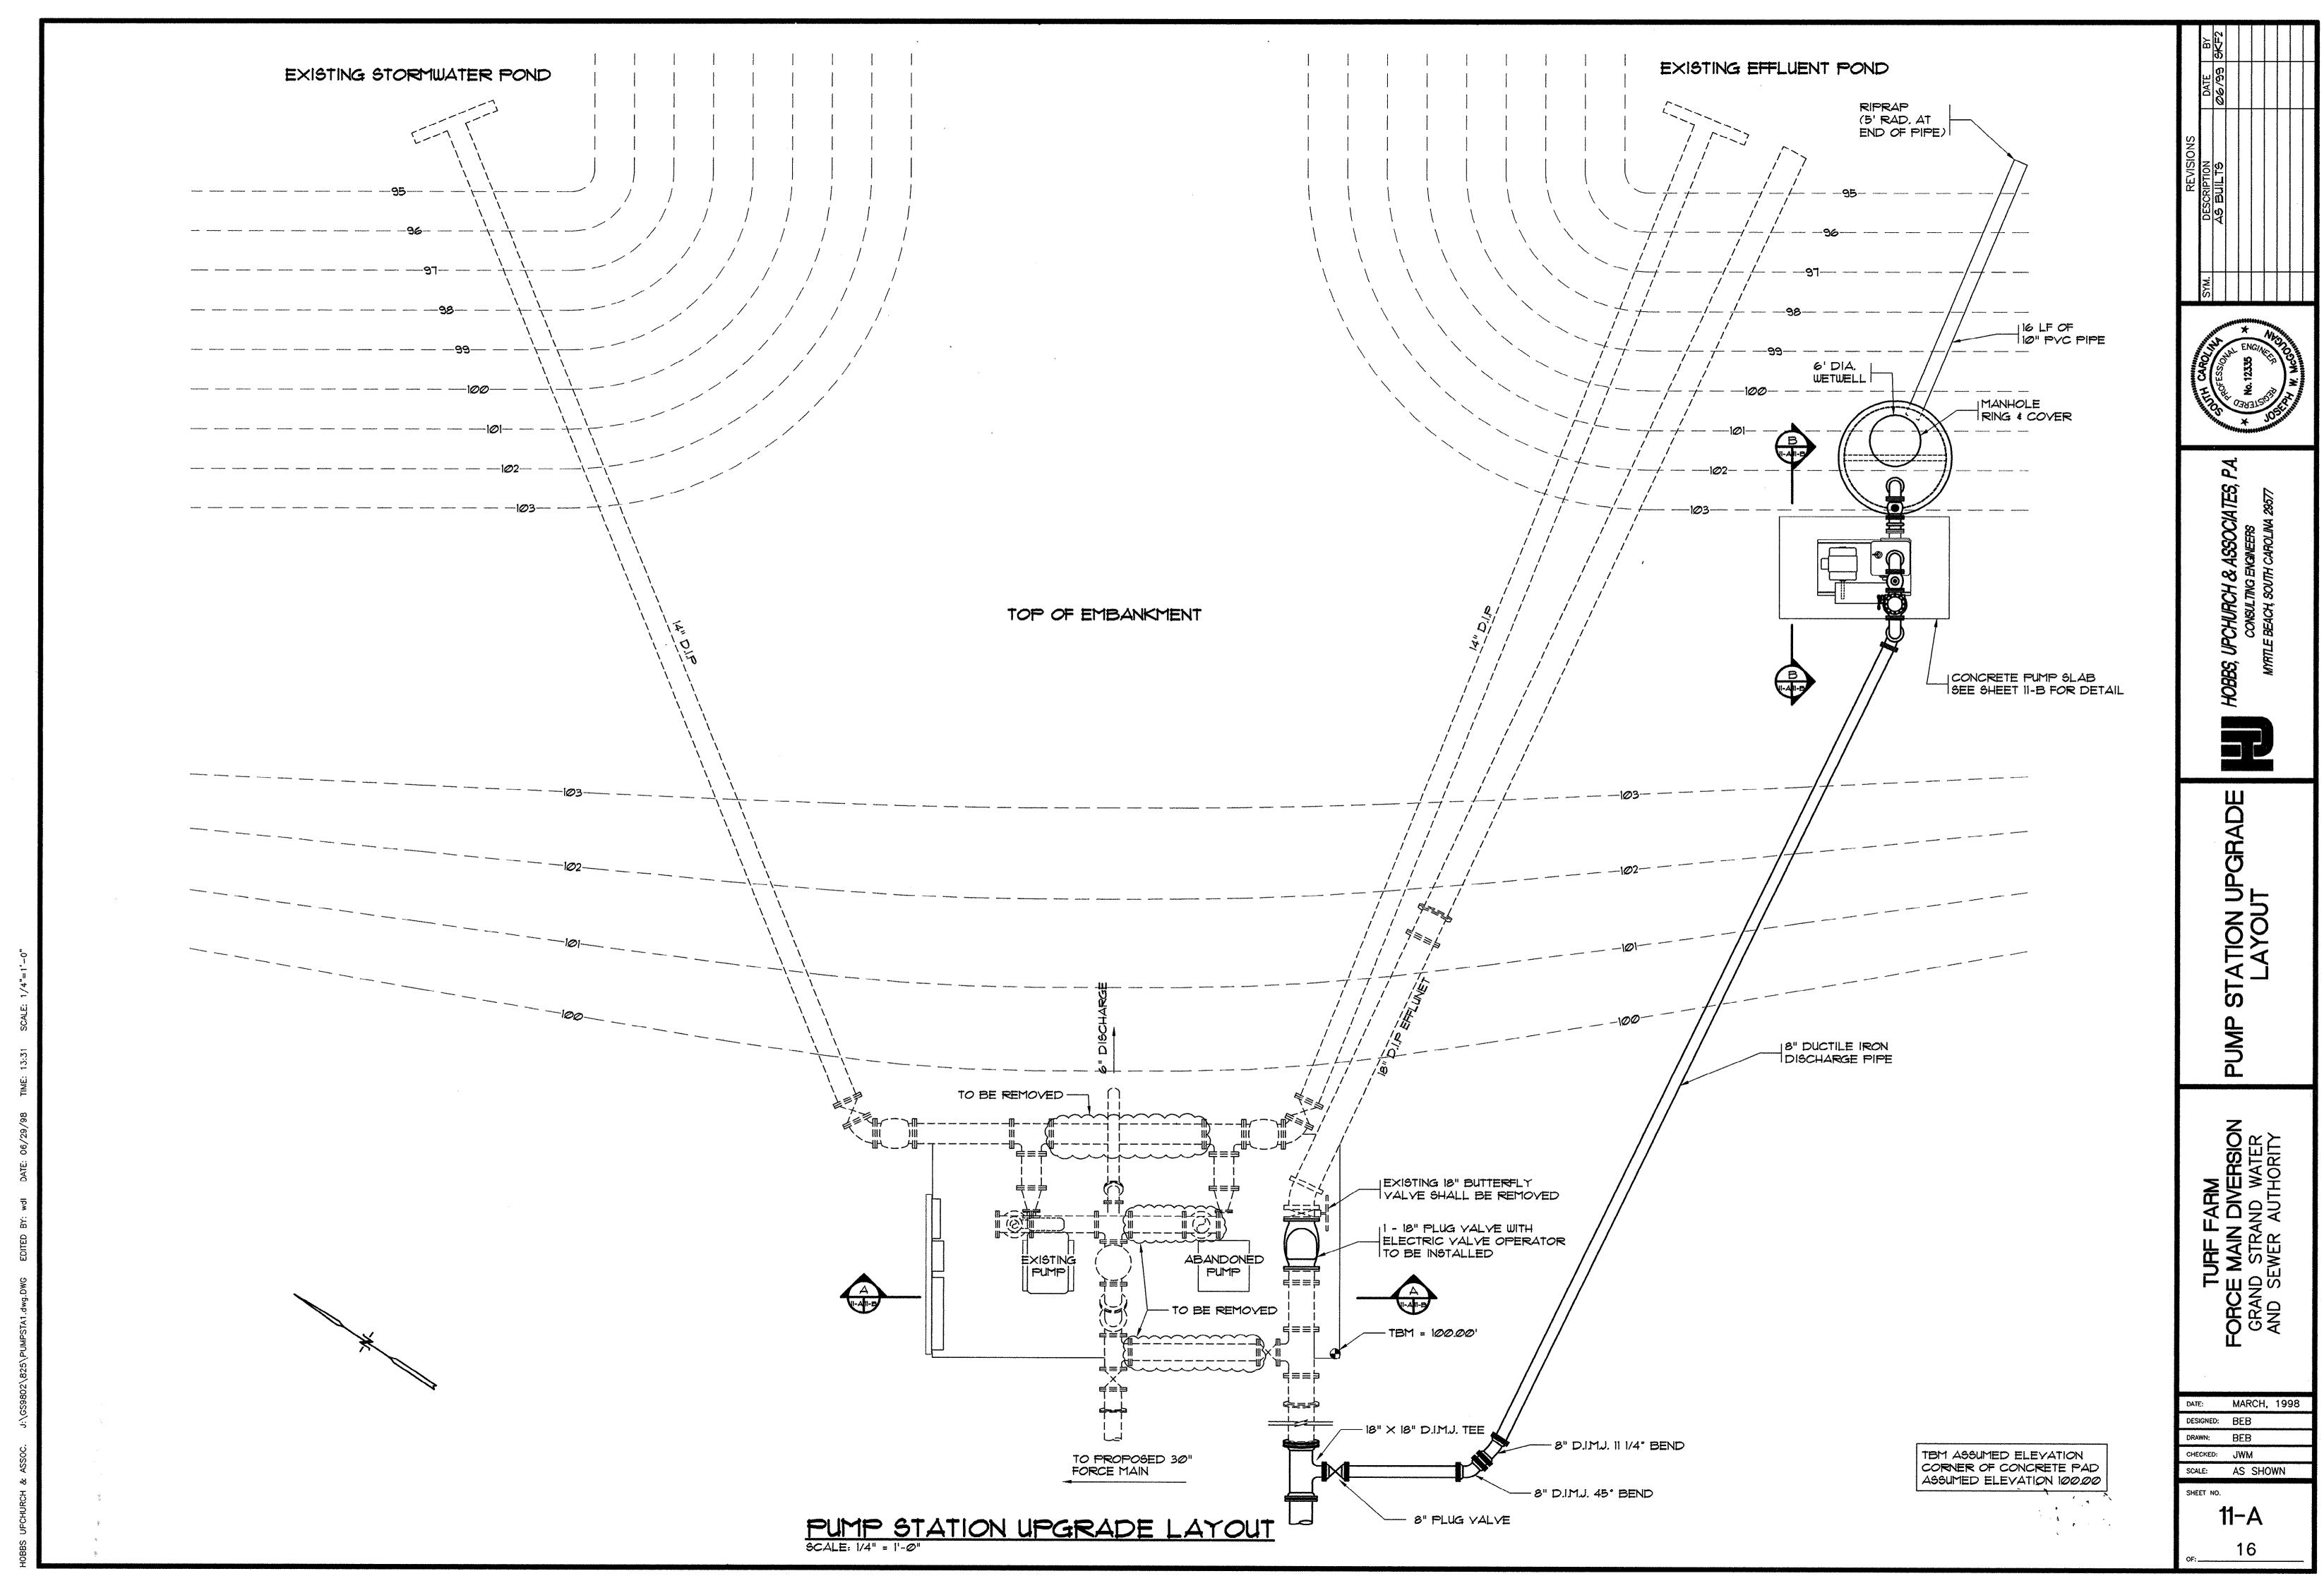


14-106-011A/16-S

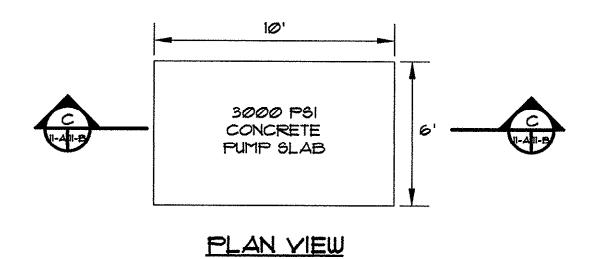


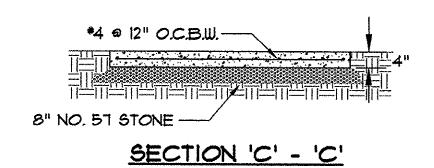

CONCRETE PUMP SLAB

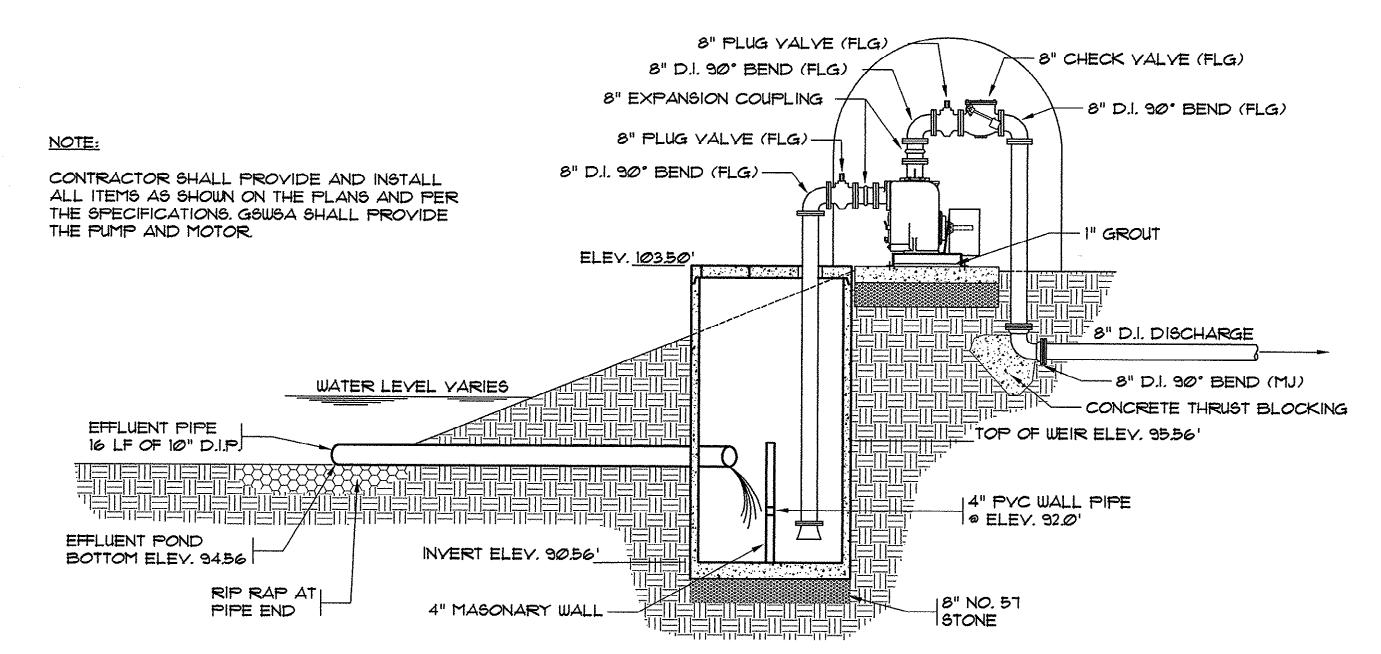

SECTION 'B'-'B' 5CALE: 1/4" = 1'-0"

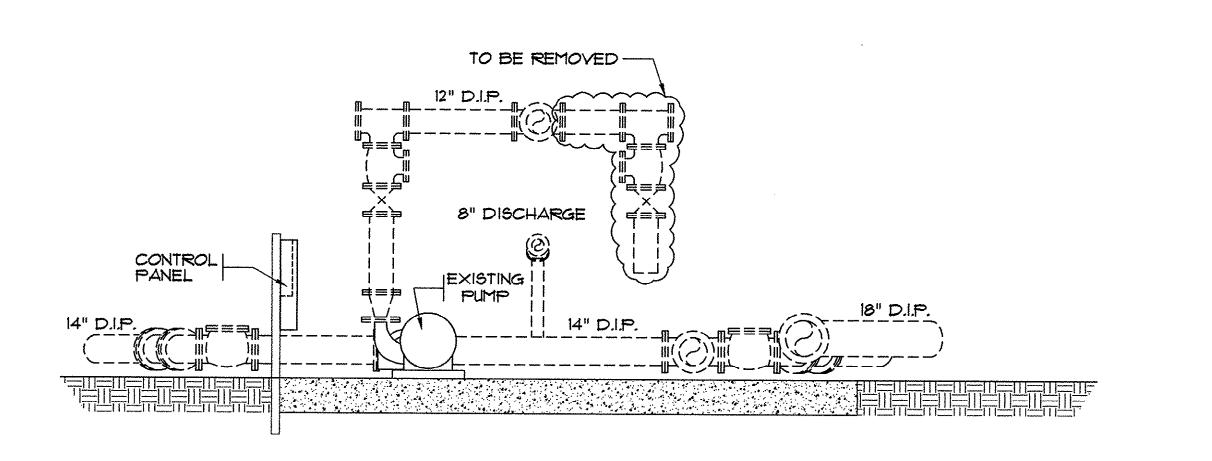


SECTION 'A'-'A'

SCALE: 1/4" = 1'-0"

SYM. DESCRIPTION DATE

A& BUILTS @6/99 6

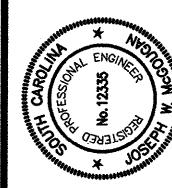

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MYRTLE BEACH, SOUTH CAROLINA 29577


STATION UPGRADE DETAILS AS BUILTS

FORCE MAIN DIVERSION
GRAND STRAND WATER
AND SEWER AUTHORITY

DATE: MARCH, 1998
DESIGNED: BEB
DRAWN: BEB
CHECKED: JWM

SCALE: AS SHOWN
SHEET NO.

11-B 16

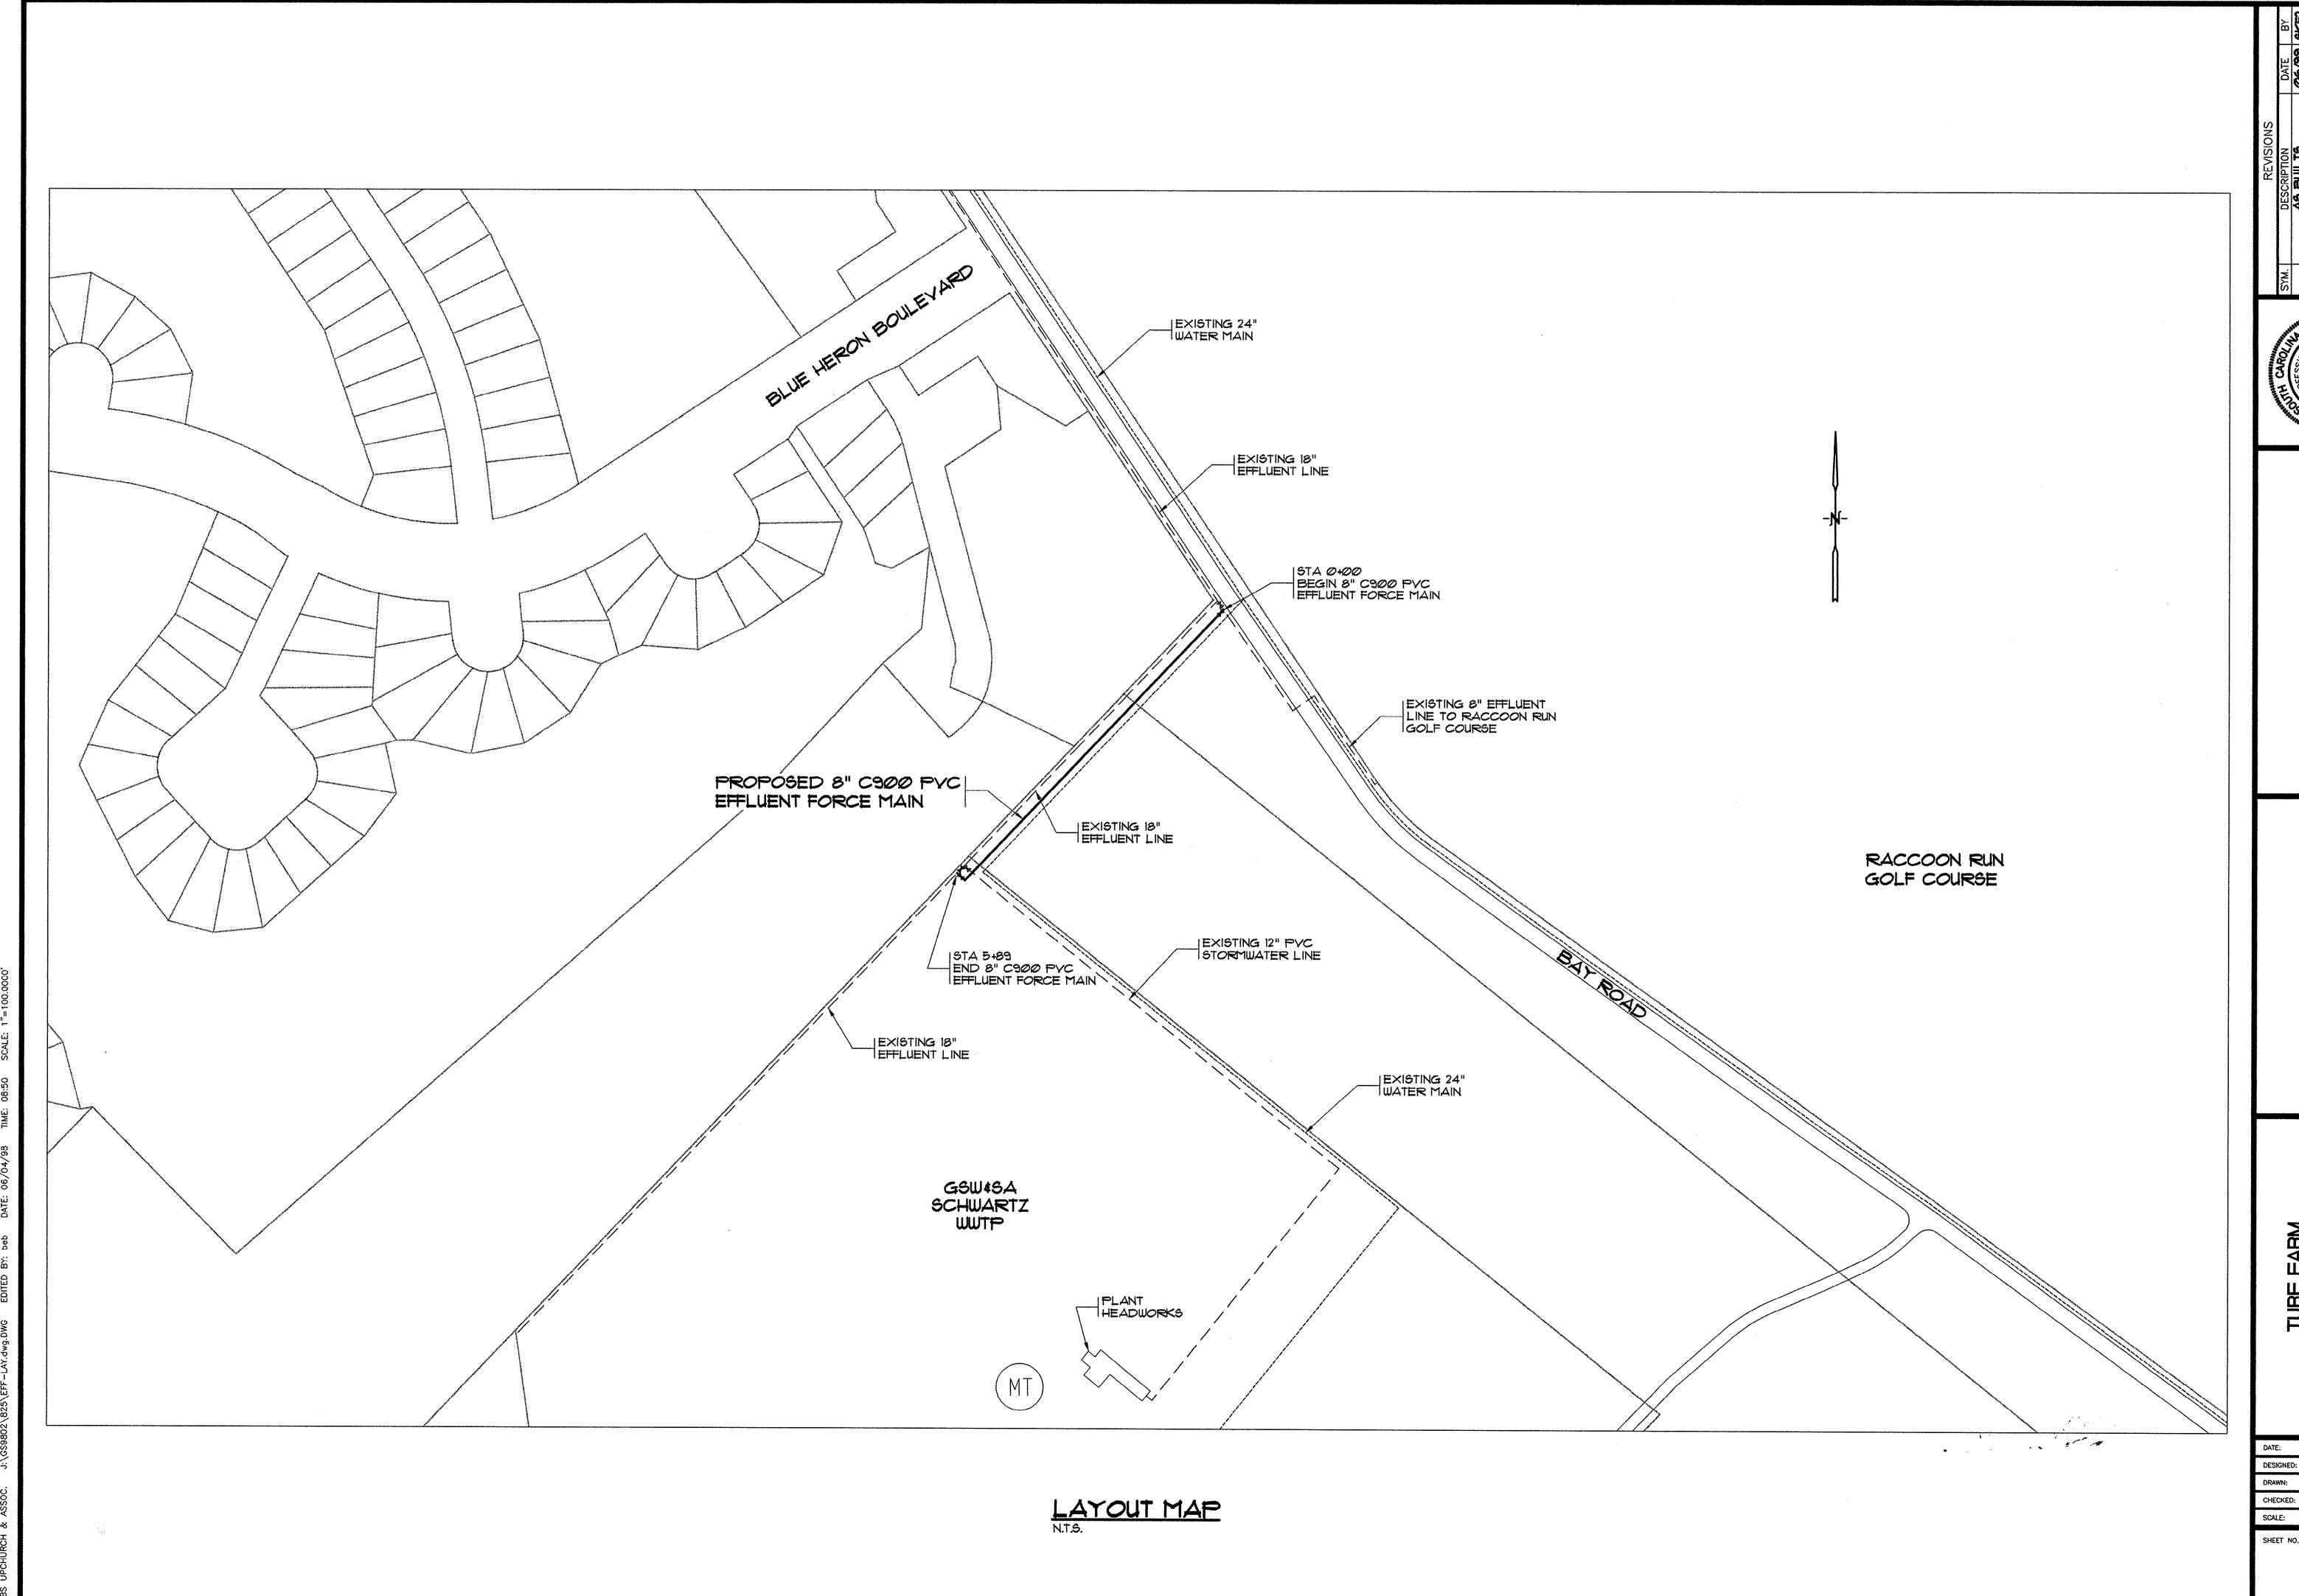

14-106-012/16-\$

ES, P.A.

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* GOUTH CAPOLITY

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HOBBS, UPCHURCH & ASSOCIATES, P.A. CONSULTING ENGINEERS MYRTLE BEACH, SOUTH CAROLINA 28577

IT FORCE MAIN COUT MAP


TURF FARM
RCE MAIN DIVERSION
RAND STRAND WATER

DATE: MARCH, 1998
DESIGNED: WDL/BEB

DRAWN: BEB
CHECKED: JWM


SCALE: AS SHOWN

SHEET NO. 12

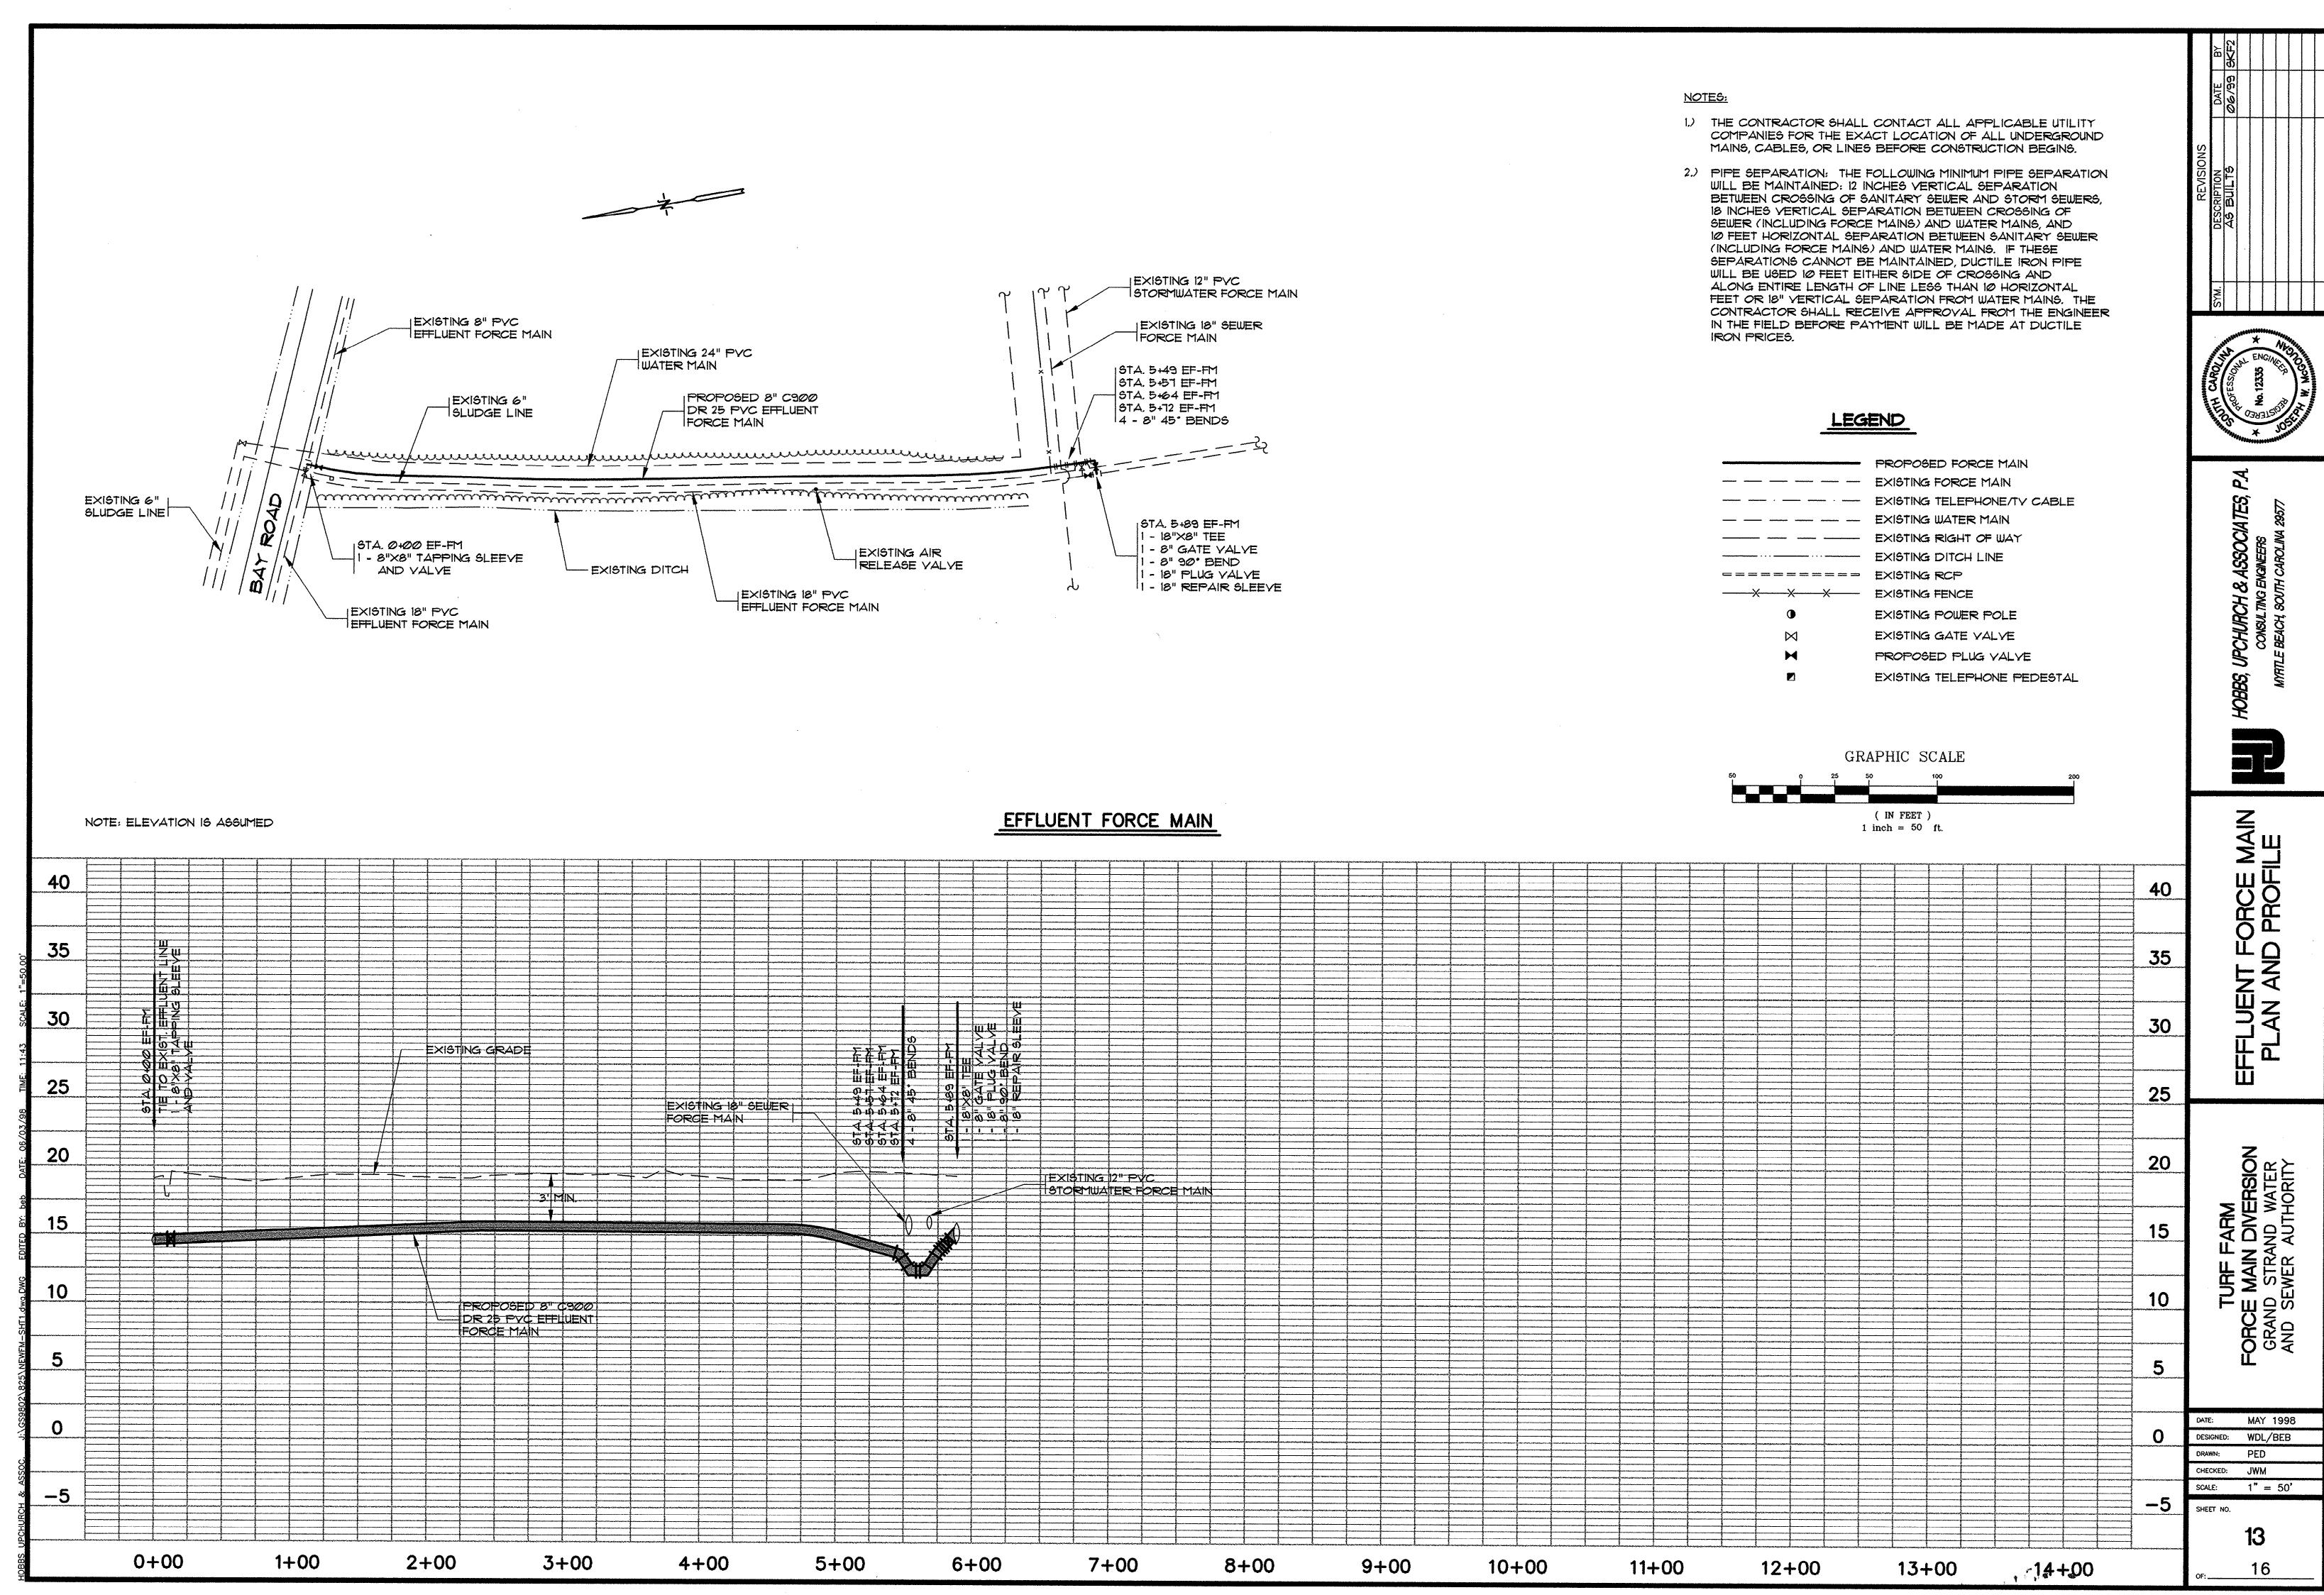


C900 DR 16 PVC PIPE THIS AREA


STORM DRAIN CROSSING

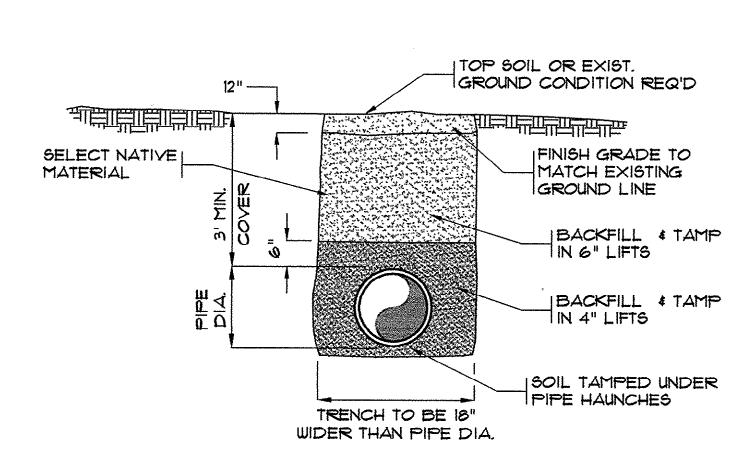


TYPICAL PIPE BEDDING DETAIL

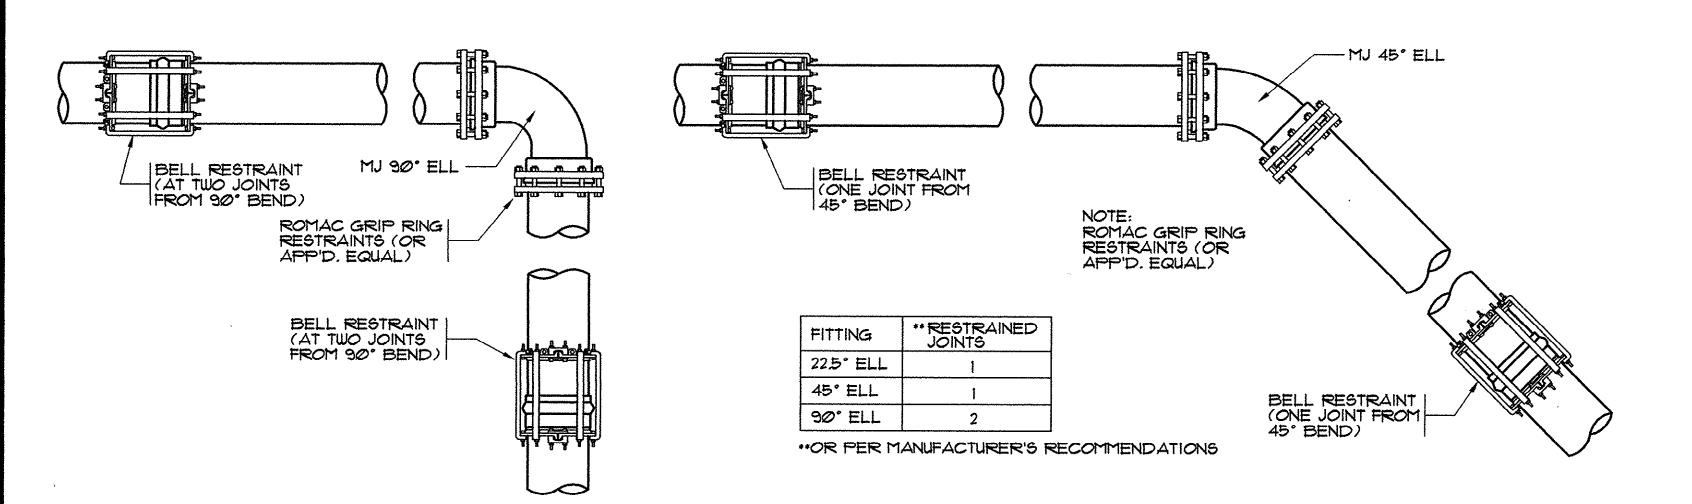


TYPICAL FITTING AND JOINT RESTRAINT (INCLUDES VALVES)

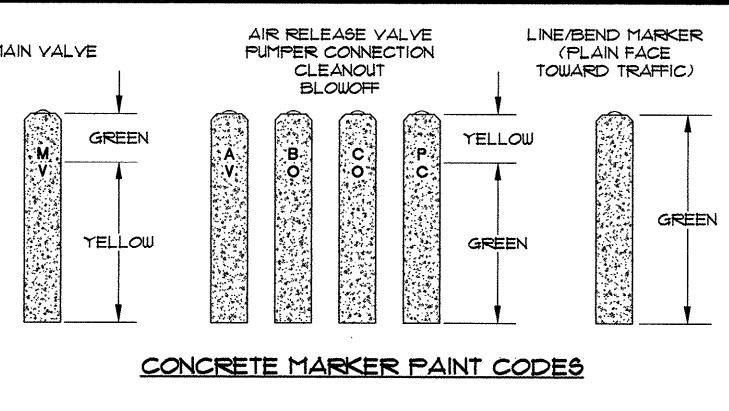


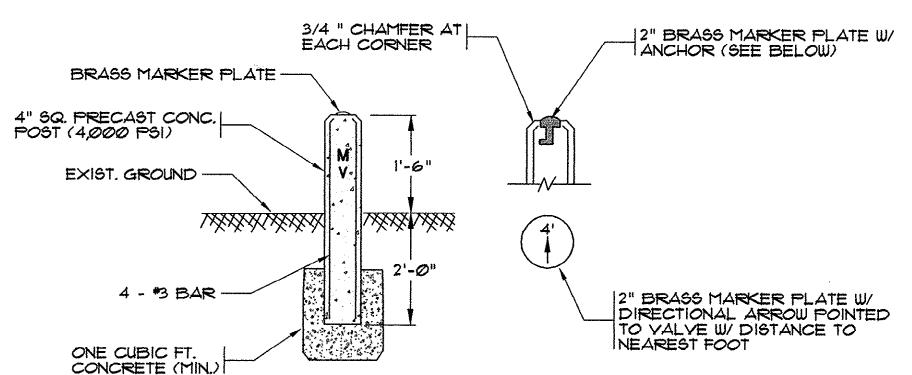

CONCRETE VALVE MARKER

(VALVE, ARV, BLOWOFF, CLEANOUT, PUMPER CONNECTION, BEND, PIPELINE)

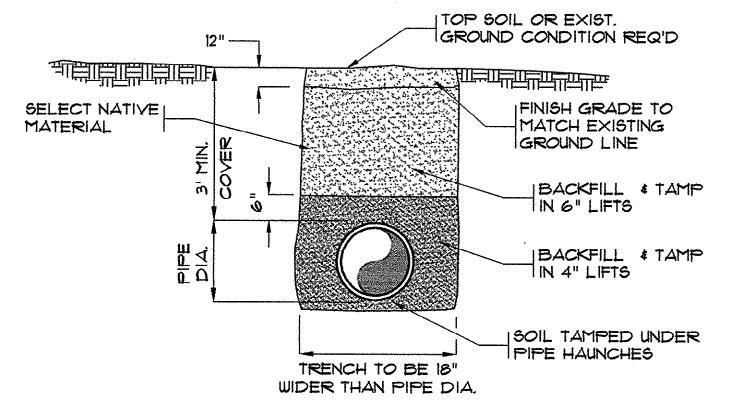


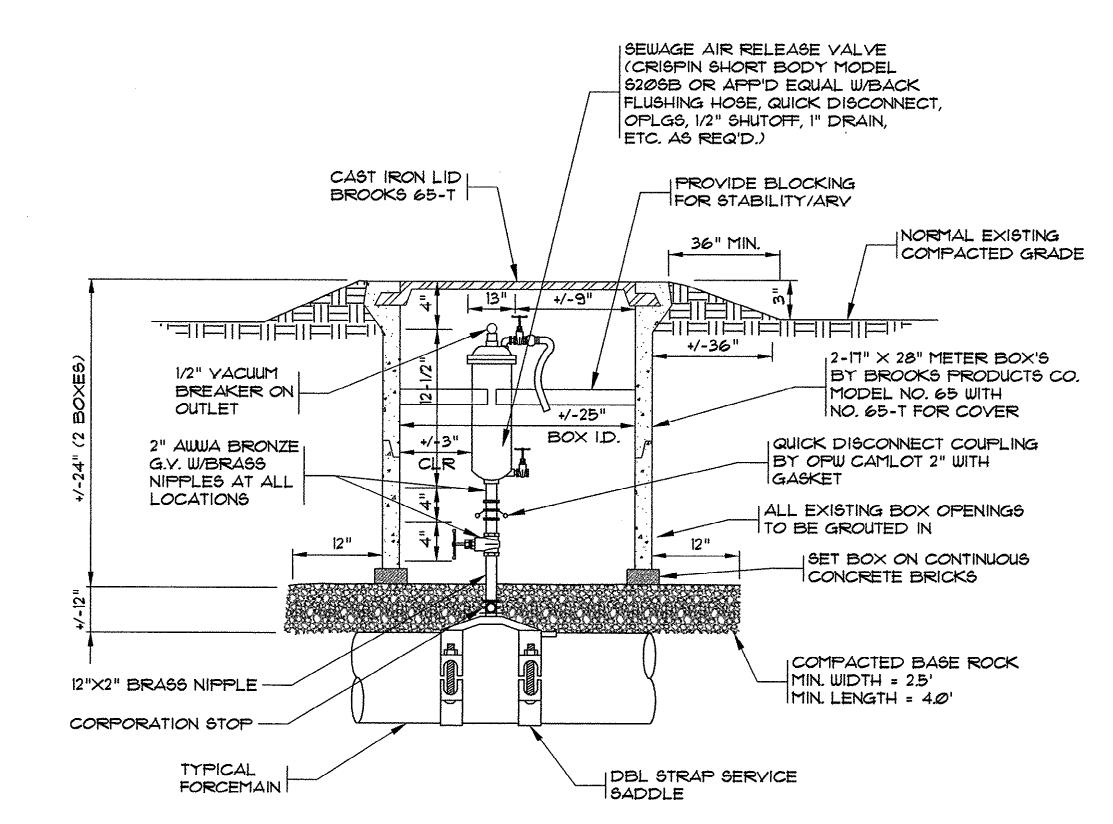

NOTES:

USE AN APPROVED JT. COMPOUND ON ALL THREADED CONNECTIONS. ROTATION & LOCATION OF BOX SETTING TO BE APPROVED BY THE INSPECTOR PRIOR TO INSTALLATION.

TYPICAL SEWER AIR RELEASE VALVE ASSEMBLY

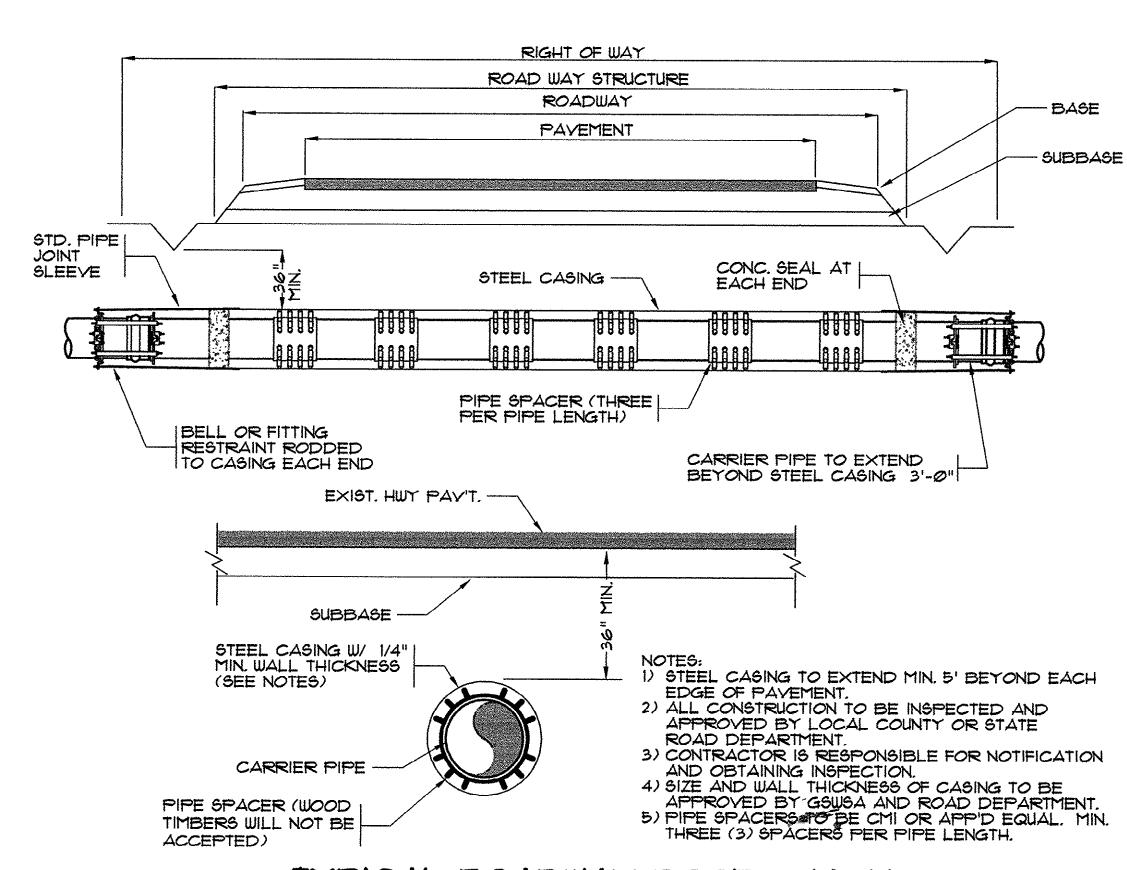

TYPICAL ROADWAY BORE & JACK


3, UPCHURCH & ASSOCIATES, F CONSULTING ENGINEERS PRILE BEACH, SOUTH CAROLINA 29577 HOBBS,


CELLANE

TURF FARM
FORCE MAIN DIVERSION
GRAND STRAND WATER
AND SEWER AUTHORITY

MARCH, 1998 DESIGNED: WDL/BEB BEB DRAWN: CHECKED: JWM SCALE: 1" = 50'SHEET NO.

16

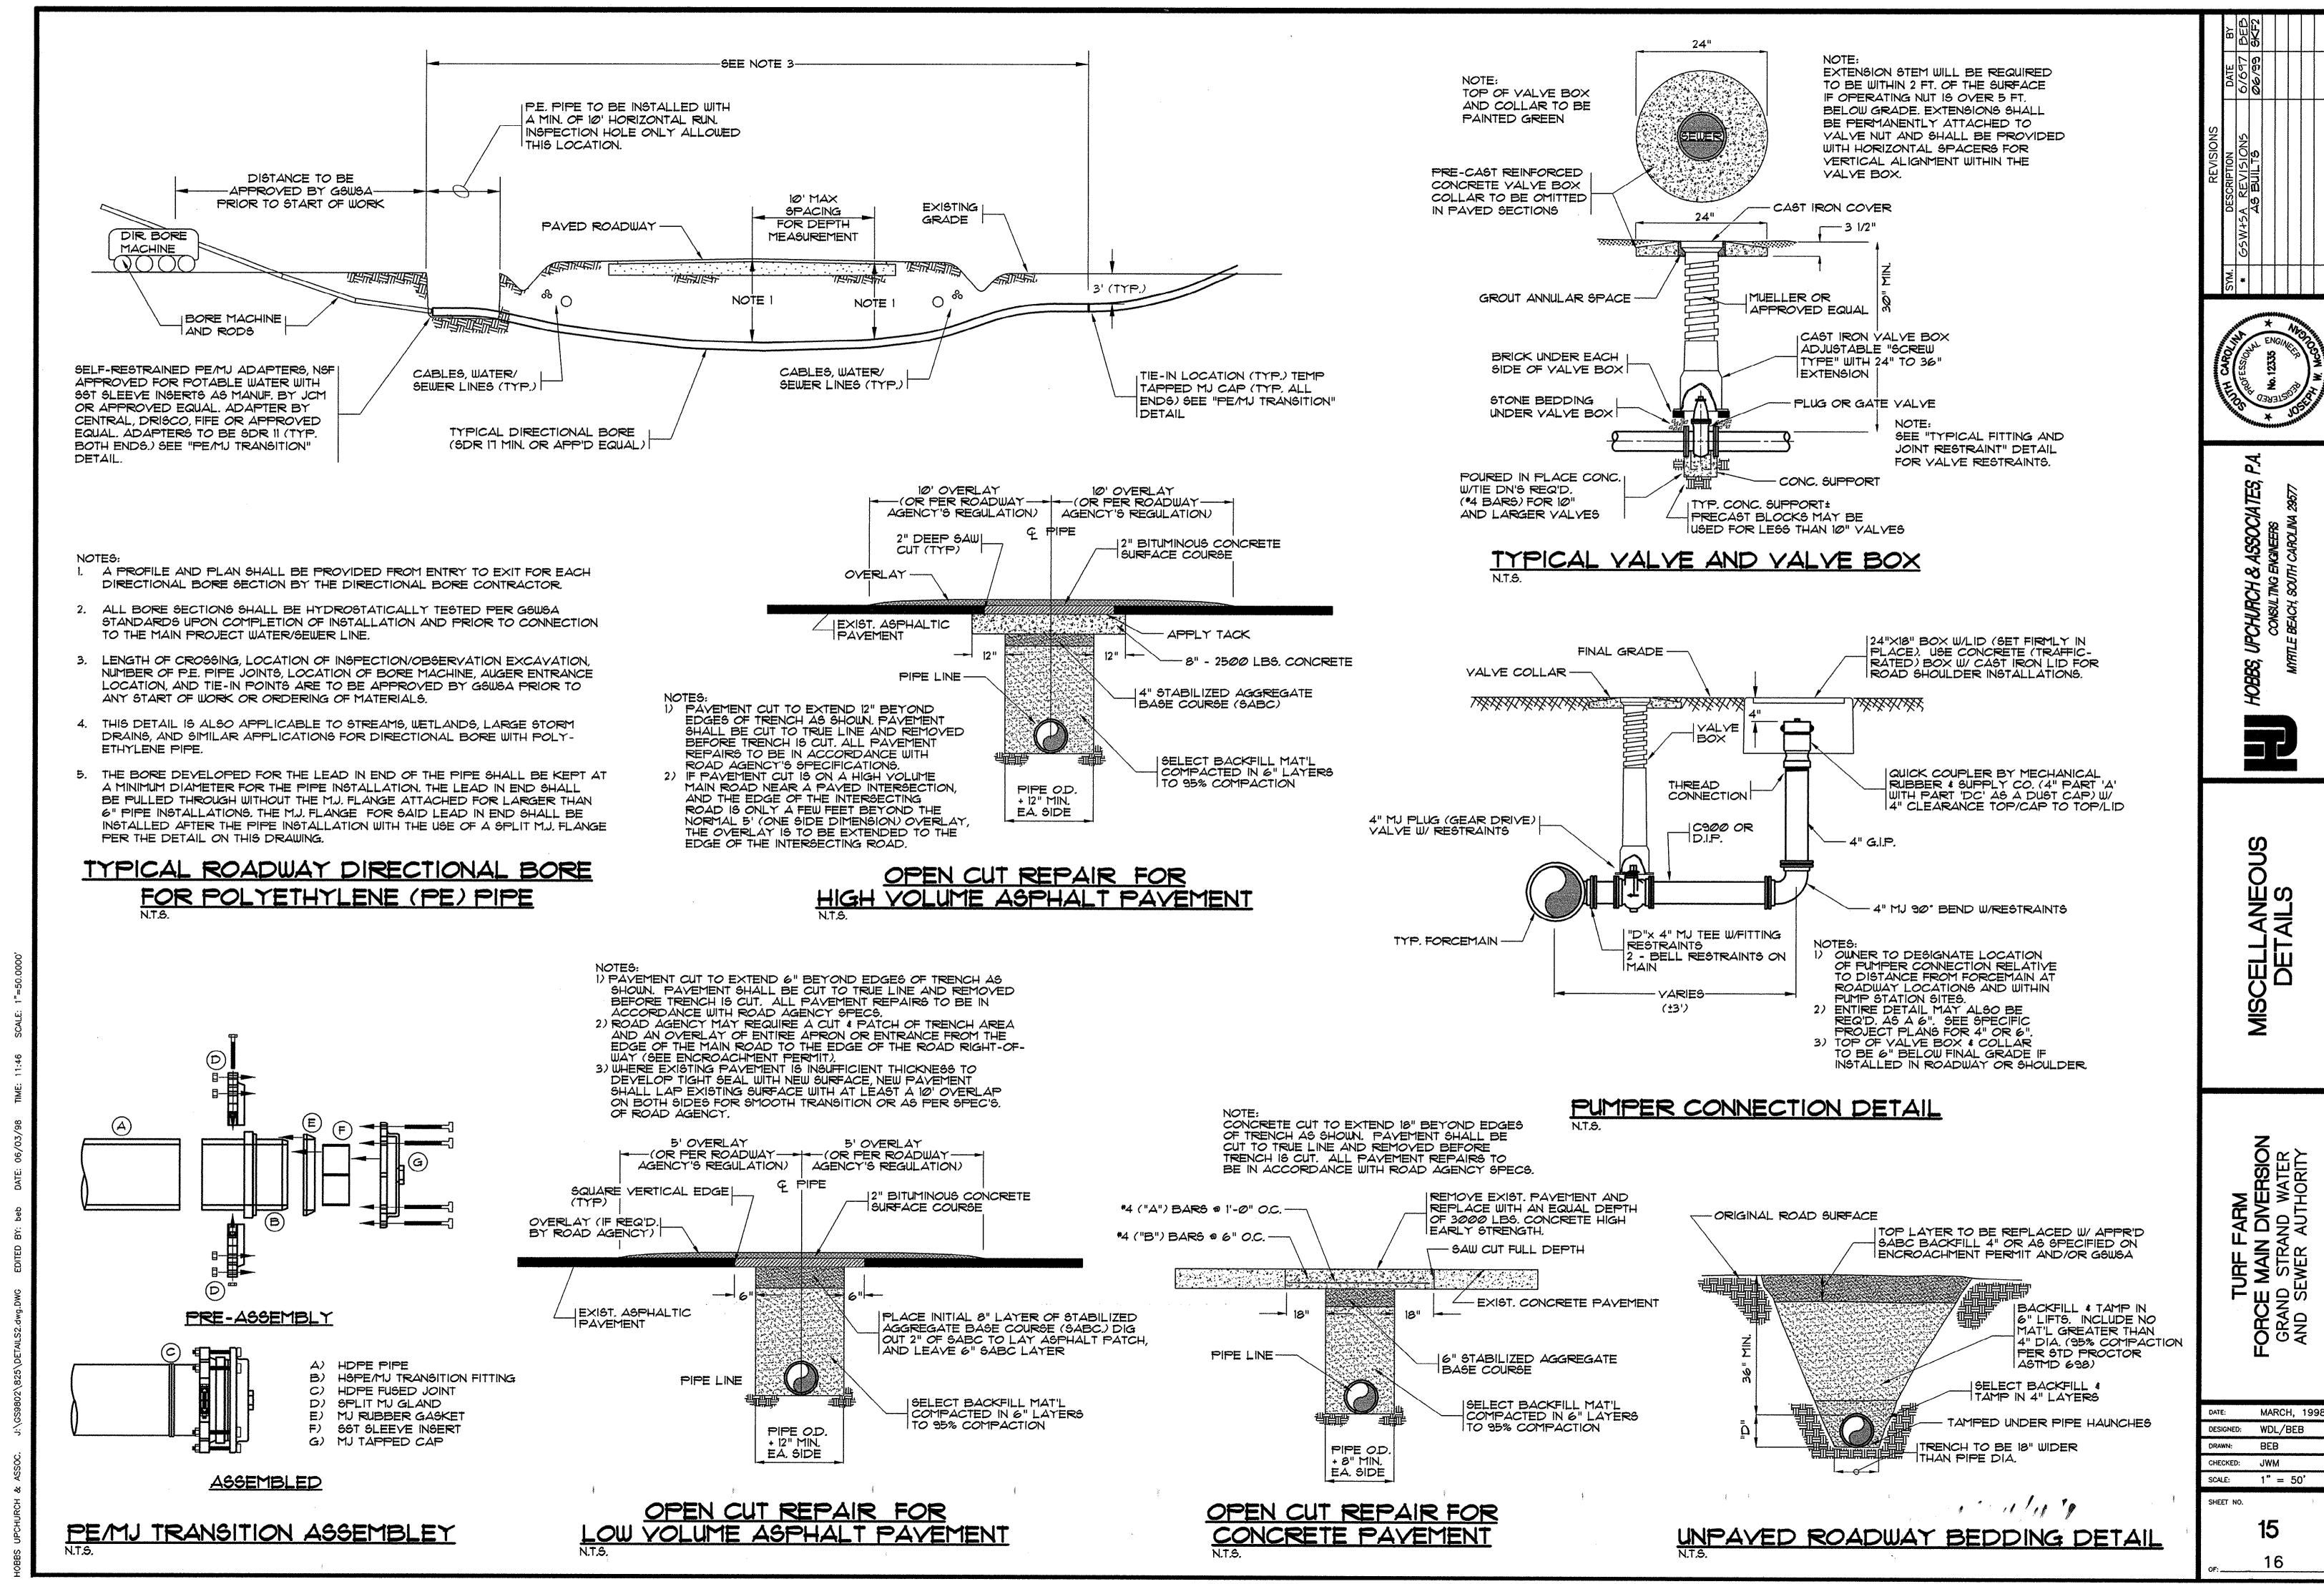


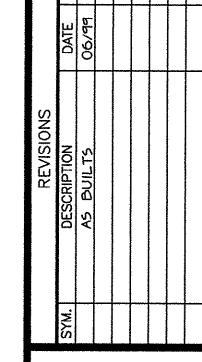

TREATED 2"X4" POSTS SPACED


AT 10 FT. WITHOUT WIRE FENCING AND 6 FT. (MAX.)

WITH WIRE FENCING.

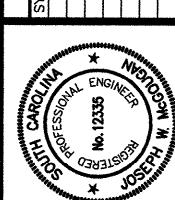

UPCHUPCH & CONSULTING EN

MARCH, 1998 WDL/BEB BEB CHECKED: JWM SCALE: 1" = 50'SHEET NO. 16

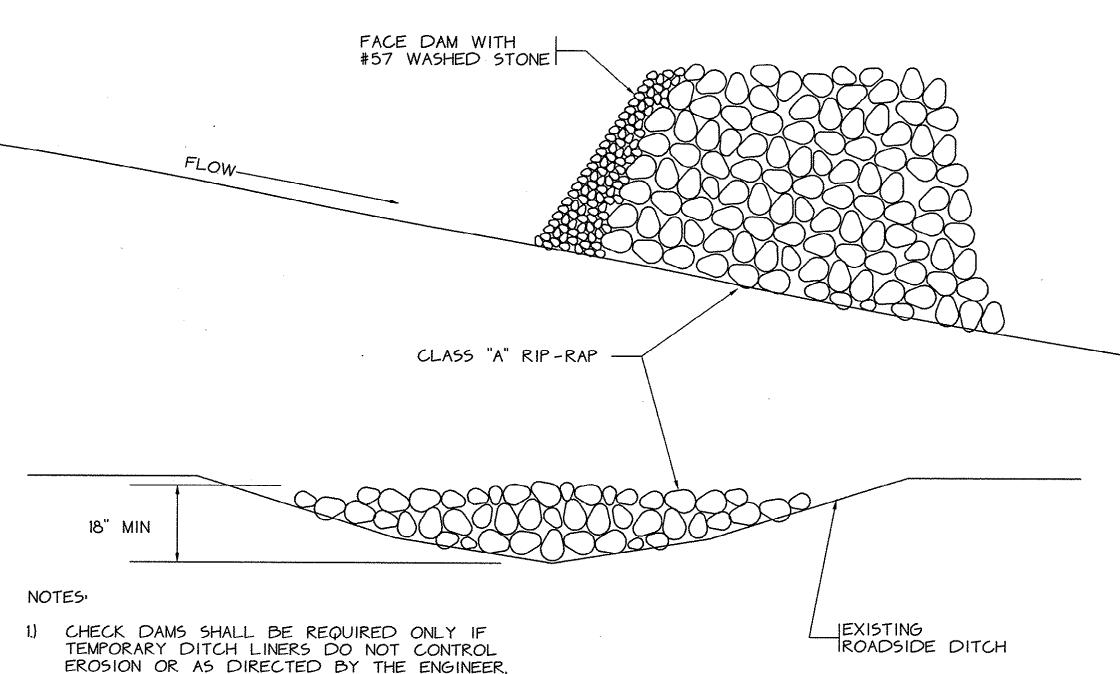


2.) CONTRACTOR SHALL REMOVE SEDIMENT ACCUMULATED BEHIND THE DAM TO PREVENT DAMAGE TO CHANNEL VEGETATION.

3.) CONTRACTOR SHALL REMOVE ROCK CHECK DAMS AFTER PERMANANT VEGETATION HAS BEEN ESTABLISHED.


TEMPORARY GRAVEL CHECK DAM DETAIL

SCALE: N.T.S.

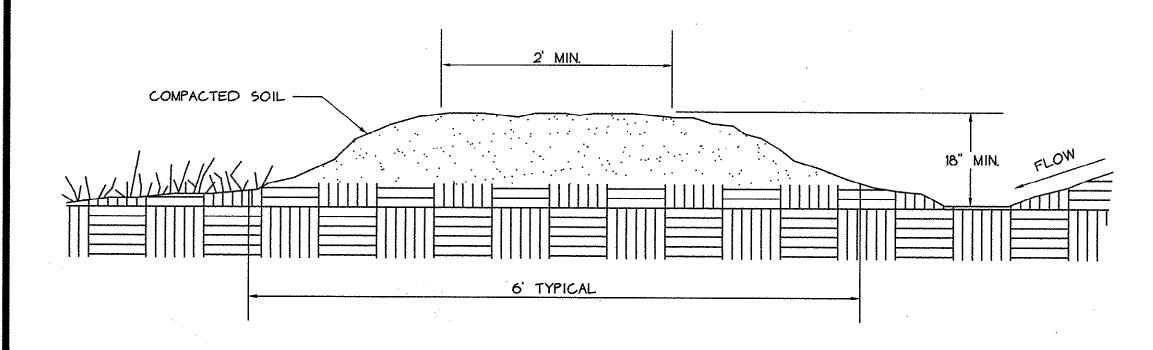

TEMPORARY EARTHEN DIVERSION DIKE


SCALE N.T.S.

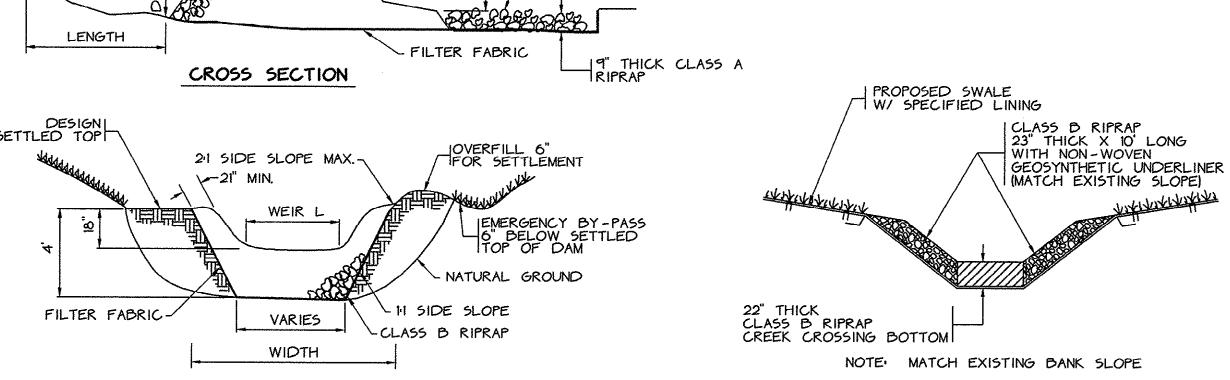


CREEK CROSSING W/ RIPRAP SLOPE PROTECTION DETAIL N.T.S.

DEPTH NON - WOVEN GEOSYNTHETIC FILTER FABRIC AND THICKNESS VARIES SEE CHART BELOW

NOTE: CLASS A RIPRAP SHALL BE 9" THICK. CLASS B RIPRAP SHALL BE 23" THICK. CLASS I RIPRAP SHALL BE 24" THICK. CLASS II RIPRAP SHALL BE 27" THICK.

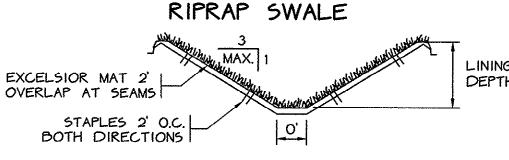

NOTE: PREPARE, SEED, AND INSTALL SOIL EROSION CONTROL BLANKET ON DISTURBED AREA OF DITCH. EXCELSIOR MAT SWALE

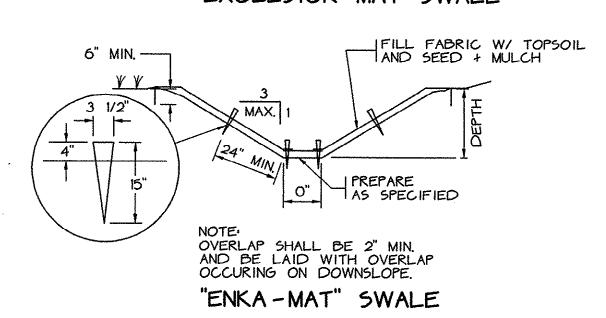

SWALE DETAIL

EXISTING ROAD-SIDE

EROSION AND SEDIMENT CONTROL NOTES:

EXTEND FABRIC AND I

TEMPORARY SILT FENCE DETAIL

WIRE INTO TRENCH

FILTER FABRIC WITH L

WIRE FENCING

1. SILT FENCES SHALL BE INSTALLED AS SHOWN ON THE PLANS OR WHERE DIRECTED BY THE ENGINEER TO CONTROL EROSION.

2. REMOVE SEDIMENT PERIODICALLY, REPAIR ANY

SCALE: N.T.S.

UNDERMINING IMMEDIATELY

4"X4" TRENCH BACKFILLED AND COMPACTED AFTER

NOTES:

GEOTEXTILE FABRIC INSTALLED


- UNLESS OTHERWISE INDICATED, ALL VEGETATION AND STRUCTURAL EROSION AND SEDIMENT CONTROL PRACTICES WILL BE CONSTRUCTED AND MAINTAINED ACCORDING TO MINIMUM STANDARDS AND SPECIFICATIONS OF THE EROSION + SEDIMENT CONTROL PLANNING + DESIGN MANUAL + ACCORDING TO THE SPECIFICATIONS.
- 2. ALL HARD SURFACE PUBLIC ROADS SHALL BE CLEAN AT THE END OF EACH WORK DAY. PROVIDE TEMPORARY CONSTRUCTION ENTRANCES AT THE LOCATIONS SHOWN ON THE PLANS OR AS OTHERWISE NECESSARY.
- 3. THE LOCATION OF ALL EROSION AND SEDIMENT CONTROL MEASURES ARE APPROXIMATE. THESE DEVICES SHALL BE LOCATED TO ACHIEVE MAXIMUM BENEFIT, IF DURING CONSTRUCTION THESE DEVICES ARE NOT SUFFICIENT TO ADEQUATELY CONTROL EROSION AND SEDIMENTATION. ADDITIONAL EROSION CONTROL DEVICES SHALL BE INSTALLED AS DIRECTED BY THE ENGINEER.
- 4. ALL TEMPORARY EROSION AND SEDIMENT CONTROL MEASURES SHALL BE REMOVED AND DISPOSED OF WITHIN 30 DAYS AFTER FINAL SITE STABILIZATION.
- 5. CONTRACTOR SHALL TAKE ALL STEPS NECESSARY TO PREVENT SEDIMENT (GENERATED BY CONSTRUCTION OR EROSION) FROM ENTERING STREAMS. CONSTRUCTION VEHICLES WILL NOT BE ALLOWED IN FLOWING STREAM CHANNELS OR TO DAMAGE THEIR BANKS. TEMPORARY STREAM CROSSINGS SHALL BE INSTALLED IN ALL FLOWING STREAMS WHICH WILL HAVE CONSTRUCTION TRAFFIC CROSSING THEM.
- 6. STOCKPILING OF EXCESS MATERIALS IN WETLAND AREAS IS NOT ALLOWED.
- 7. IN GENERAL, ALL EROSION AND SEDIMENT CONTROL MEASURES SHALL BE CHECKED AFTER EACH RAINFALL OR WEEKLY, WHICHEVER IS MORE FREQUENT (AT LEAST DAILY DURING PERIODS OF PROLONGED RAINFALL). CONTRACTOR SHALL CLEAN AND REPAIR ACCORDINGLY.
- 8. ALL WORK PERFORMED SHALL BE IN COMPLIANCE WITH GSWSA STORM WATER POLLUTION PREVENTION PLAN.

DITCH CROSSING DETAIL

- CLASS A RIP-RAP VARIES

FILTER FABRIC TO BE INSTALLED UNDER ALL RIP-RAP

EXISTING DITCH CENTERLINE

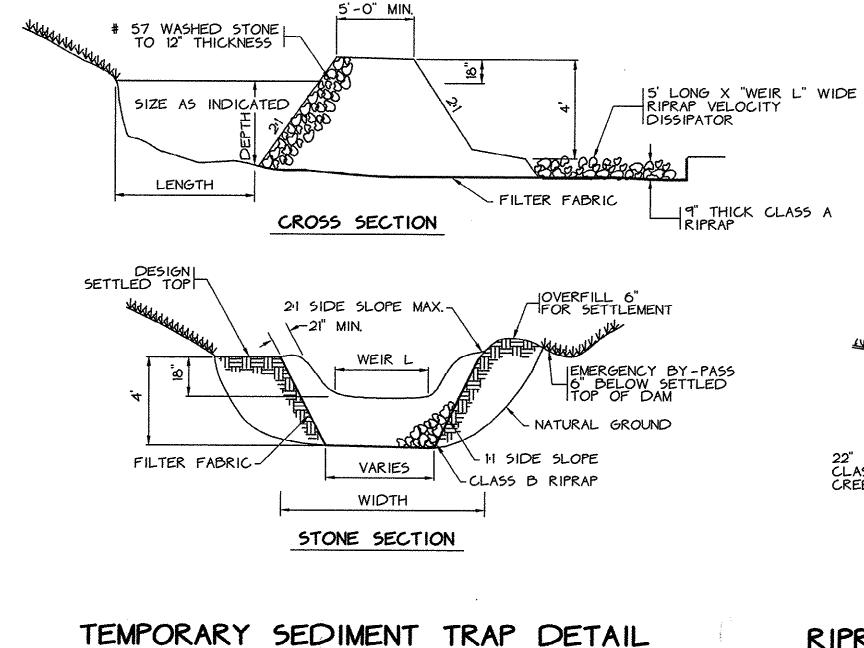

NOTE: IF PIPE DISCAHRGES INTO ROADSIDE SWALE, RIPRAP SHALL ALIGN WITH SPECIFIED SWALE.

PIPE OUTLET

FLOW -